
CITY OF SAUSALITO, CALIFORNIA

GATE 6 ROAD / BRIDGE ROAD / BRIDGEWAY AND NB US 101 ON-RAMP INTERSECTION IMPROVEMENTS

PROJECT NO: CML5098(012)


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LOCATION MAP NOT TO SCALE

PROJECT CONSULTANTS										
CLIENT	CITY OF SAUSALITO	BICYCLE/	BICYCLE SOLUTIONS							
	CITY ENGINEER	PEDESTRIAN SPECIALIST	511 ANDERSON STREET							
	420 LITHO STREET SAUSALITO, CA 94965 (415) 289-4176 tel	SPECIALIST	SAN FRANCISCO, CA 94110 (415) 912-6999 tel							
		SIGNAL	Y&C TRANSPORTATION CONSULTANTS, INC.							
PRIME	URBAN DESIGN CONSULTING ENGINEERS	DESIGNER	3250 RAMOS CIRCLE							
CONSULTANT	4400 MARKET STREET, STE. 800		SACRAMENTO, CA 95827							
	OAKLAND, CA 94608 510 868 1085 tel		(916) 366-8000 tel							
	510 225 1782 fax	LAND SURVEYOR	CINQUINI & PASSARINO LAND SURVEYING, INC 1360 NORTH DUTTON, STE. 150							
TRANSPORTATION	KITTLESON & ASSOCIATES, INC.		SANTA ROSA, CA 95401							
ENGINEER	155 GRAND AVENUE, STE. 900		(707) 542-6268 tel							
	OAKLAND, CA 941612 (510) 839-1742 tel		(707) 542-2106 fax							

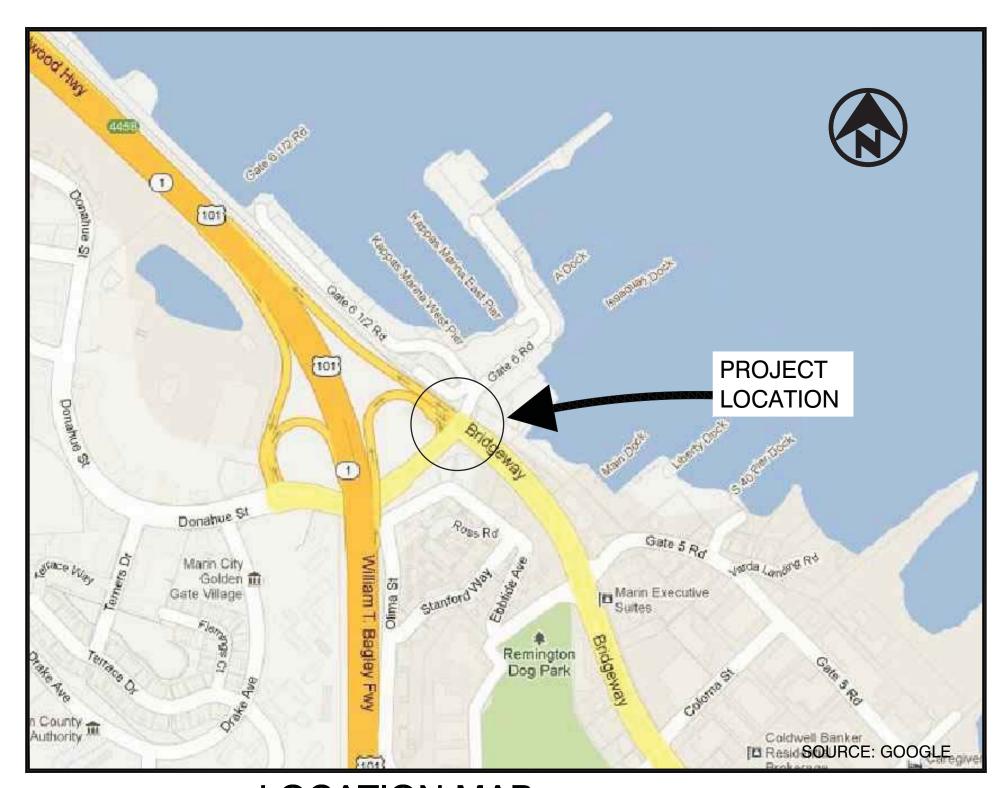

VICINITY MAP

NOT TO SCALE

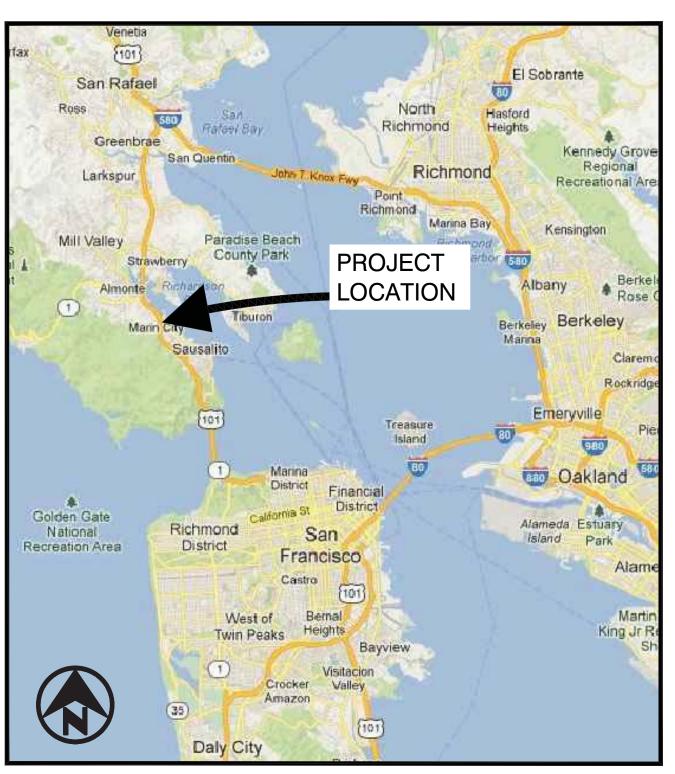CITY ENGINEER

APPROVED
JONATHON GOLDMAN

No. C042165

EXP. 03-31-16

OF CALIFORNIA

OF CALIFORNIA


OF SAUSPILL

420 Litho St., Sausalito CA 94965

CONSULTING ENGINEERS

SPECIALIZING IN URBAN DEVELOPMENT,
CIVIL ENGINEERING AND PROJECT MANAGEMEN
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S INTERSECTION ROVEMENTS

TITLE SHEET

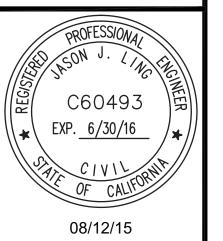DATE: 05/24/2016

SCALE: AS SHOWN

DRAWN BY MLK

PROJECT NO: CML5098(01

G-1.0

1 OF 23 SHEETS

s\130319 Gate 6 Intersection\D-Drawings\01 Sheets\01 G-1.0 TITLE

/15/2016 10·40 AI

GENERAL NOTES

- 1. NO WORK SHALL START UNTIL ALL NECESSARY PERMITS ARE OBTAINED FROM THE CITY OF SAUSALITO.
- 2. PROPOSED IMPROVEMENTS IN CITY RIGHT OF WAY SHALL BE DONE IN ACCORDANCE WITH THE UNIFORM CONSTRUCTION STANDARDS, ALL CITIES AND COUNTY OF MARIN, AND SHALL MEET THE APPROVALS OF THE CITY ENGINEER OF THE CITY OF SAUSALITO. FOR DETAILS NOT SHOWN ON THESE PLANS, REFER TO THE UNIFORM CONSTRUCTION STANDARDS, CURRENT EDITION.
- 3. ALL GENERAL CONTRACTORS AND SUBCONTRACTORS MUST HAVE A CITY OF SAUSALITO BUSINESS LICENSE.
- ENCROACHMENT PERMITS AND GRADING PERMITS REQUIRED FOR WORK WITHIN EXISTING PUBLIC RIGHTS OF WAY INCLUDING CALTRANS, COUNTY OF MARIN, AND CITY OF SAUSALITO SHALL BE OBTAINED BY THE CONTRACTOR.
- CONTRACTOR SHALL BE RESPONSIBLE FOR MAINTAINING A PERMIT COPY OF CONSTRUCTION PLANS AT THE PROJECT SITE DURING CONSTRUCTION.
- 6. CONTRACTOR SHALL BE RESPONSIBLE FOR ANY DAMAGE TO ROADS OR ADJACENT PUBLIC OR PRIVATE PROPERTY CAUSED BY CONSTRUCTION RELATED WORK, AND SHALL BE RESPONSIBLE FOR ANY OTHER WORK REQUIRED TO PREVENT SUCH DAMAGE.
- 7. CONTRACTOR SHALL PROVIDE AND MAINTAIN VEHICULAR, BICYCLE, AND PEDESTRIAN TRAFFIC ON ALL EXISTING STREETS DURING CONSTRUCTION. CONTRACTOR SHALL SUBMIT TRAFFIC CONTROL PLAN TO BE APPROVED BY THE CITY AND CALTRANS.
- 8. CONTRACTOR SHALL NOTIFY UNDERGROUND SERVICES ALERT (U.S.A) AT (800) 227-2600 AT LEAST 48 HOURS PRIOR TO ANY EXCAVATION. CONTACTING U.S.A. DOES NOT RELIEVE THE CONTRACTOR FROM HIS RESPONSIBILITY TO DETERMINE LOCATION AND DEPTH OF BURIED UTILITIES.
- 9. ANY POTHOLING SHALL BE DONE BY THE VACUUM TYPE METHOD, NOT WITH HEAVY EXCAVATION EQUIPMENT.
- 10. ALL EXCAVATIONS 5 FEET IN DEPTH OR GREATER SHALL BE SHORED AND BRACED ACCORDING TO OSHA REGULATIONS.
- 11. THE REMOVAL AND DISPOSAL OF DEMOLITION ITEMS (POWER POLES, FENCES, RETAINING WALLS, TREES, STRUCTURES, PIPELINES, ETC.) SHALL BE AT THE CONTRACTOR'S EXPENSE.
- 12. CONTRACTOR SHALL BE RESPONSIBLE TO COORDINATE ALL DEMOLITION AND CONSTRUCTION STAGING AMONG ALL ADJACENT PROJECTS, INCLUDING BUT NOT LIMITED TO TRAFFIC HANDLING, CURB RETURNS, UTILITIES, TRAFFIC SIGNALS AND DRAINAGE.
- 13. ALL DEBRIS AND UNSUITABLE MATERIAL WITHIN THE AREA OF WORK, WHICH IS NOT INCORPORATED IN THE WORK, SHALL BE REMOVED TO A LEGAL DUMPSITE AT THE EXPENSE OF THE CONTRACTOR.
- 14. STREET SIGNAGE SHALL BE MAINTAINED UNTIL RELOCATION OR ALTERNATE SIGNAGE IS INSTALLED AND APPROVED OR REMOVAL IS AUTHORIZED BY THE CITY IN ACCORDANCE WITH APPLICABLE LAW.
- 15. THE CONTRACTOR SHALL EXERCISE CARE WHEN WORKING NEAR EXISTING UTILITIES AND SHALL BE RESPONSIBLE FOR ALL DAMAGE, BREAKAGE OR LEAKS CAUSED BY HIS WORK.
- 16. PIPE INSTALLED WITH THIS PROJECT SHALL BE AS SPECIFIED ON THESE PLANS OR AS OTHERWISE APPROVED BY THE CITY ENGINEER.
- 17. EXISTING CONTOURS SHOWN ARE INTERPRETED FROM THE FIELD SURVEY'S EXISTING SPOT ELEVATIONS.
- 18. THE CONTRACTOR SHALL CONFIRM BY POTHOLING PROPOSED STORM DRAIN PIPE ALIGNMENTS ARE FREE OF OBSTRUCTIONS. NOTIFY ENGINEER IF OBSTRUCTIONS ARE ENCOUNTERED.
- 19. THE CONTRACTOR SHALL NOT TURN OFF ANY VALVES IN THE CITY OF SAUSALITO OR MAKE ANY CONNECTIONS TO THE EXISTING DOMESTIC WATER DISTRIBUTION SYSTEM WITHOUT WRITTEN CONSENT OF THE CITY ENGINEER. CONNECTIONS REQUIRING SHUTDOWN OF THE EXISTING SYSTEMS SHALL BE DONE BETWEEN THE HOURS OF MIDNIGHT AND 6 A.M. OR AS DIRECTED BY THE CITY ENGINEER.
- 20. SHOULD IT APPEAR THAT THE WORK TO BE DONE, OR ANY MATTER RELATIVE THERETO IS NOT SUFFICIENTLY DETAILED OR EXPLAINED ON THESE PLANS, THE CONTRACTOR SHALL CONTACT THE ENGINEER FOR FURTHER EXPLANATION AS MAY BE NECESSARY PRIOR TO CONSTRUCTION.
- 21. THE CONTRACTOR SHALL BE HELD RESPONSIBLE FOR ANY FIELD CHANGES MADE WITHOUT WRITTEN CONSENT OF THE ENGINEER AND CITY ENGINEER.
- 22. WHERE A CONFLICT OCCURS BETWEEN THE PROJECT SPECIFICATIONS, THE UNIFORM CONSTRUCTION STANDARDS, CALTRANS STANDARD SPECIFICATION AND STANDARD PLANS, AND RECOMMENDATIONS BY THE CONTRACTOR, THE MOST STRINGENT SHALL APPLY.

- 23. ALL QUANTITIES AND PAY ITEMS ARE AND WILL BE BASED ON HORIZONTAL MEASUREMENTS.
- 24. CONTRACTOR SHALL PROVIDE ALL LIGHTS, SIGNS, BARRICADES, FLAGMAN, OR OTHER DEVICES NECESSARY TO PROVIDE FOR PUBLIC SAFETY AS REQUIRED, OR AS DIRECTED BY CITY ENGINEER. THE CONTRACTOR SHALL PROVIDE THE CITY ENGINEER WITH A TRAFFIC CONTROL PLAN FOR THE PORTIONS OF WORK WHICH WILL REQUIRE LANE CLOSURES OR DETOURS. THIS PLAN SHALL BE SUBMITTED ONE WEEK IN ADVANCE OF THESE CONSTRUCTION ACTIVITIES FOR CITY STAFF'S REVIEW AND APPROVAL.
- 25. CONTRACTOR SHALL COMPLY WITH THE RULES AND REGULATIONS OF THE STATE, CITY AND OSHA CONSTRUCTION SAFETY ORDERS.
- 26. ALL CONSTRUCTION EQUIPMENT POWERED BY INTERNAL COMBUSTION ENGINES SHALL BE MUFFLED AND MAINTAINED. STATIONARY NOISE-GENERATING CONSTRUCTION EQUIPMENT, SUCH AS AIR COMPRESSORS, SHALL BE LOCATED AS FAR AWAY AS POSSIBLE FROM EXISTING RESIDENCES.
- 27. ALL STORM DRAIN INLETS MUST BE LABELED "NO DUMPING DRAINS TO BAY" USING APPROVED METHODS.
- 28. ALL EROSION CONTROL MEASURES SHALL BE IN PLACE BY START OF CONSTRUCTION AND MUST BE MAINTAINED AND OPERATIONAL UNTIL THE COMPLETION OF CONSTRUCTION ACTIVITIES.
- 29. ALL GRADING ACTIVITIES SHALL COMPLY WITH THE STORM WATER POLLUTION PREVENTION PLAN (SWPPP) AND EROSION CONTROL PLAN. THE CONTRACTOR SHALL MEET AND FOLLOW ALL NATIONAL POLLUTANT DISCHARGE ELIMINATION SYSTEM (NPDES) REQUIREMENTS IN EFFECT AT THE TIME OF CONSTRUCTION. CONTRACTOR SHALL PREPARE AND OBTAIN APPROVAL OF A SWPPP FOR THE PROJECT.
- 30. ALL EXISTING UTILITIES AND IMPROVEMENTS THAT BECOME DAMAGED DURING CONSTRUCTION SHALL BE COMPLETELY RESTORED TO THE SATISFACTION OF THE CITY ENGINEER, AND THE UTILITY OWNER AT THE CONTRACTOR'S SOLE EXPENSE.
- 31. ALL GRADING AND NOISE THEREFROM, INCLUDING BUT NOT LIMITED TO, WARMING OF EQUIPMENT MOTORS IN RESIDENTIAL ZONES, OR WITHIN FIVE HUNDRED (500) FEET OF ANY RESIDENTIAL OCCUPANCY, SHALL BE LIMITED TO THE HOURS OF 8:00 AM TO 6:00 PM WEEKDAYS, AND SATURDAYS 9:00 AM TO 5:00 PM UNLESS OTHER HOURS ARE APPROVED BY THE CITY ENGINEER, AND UPON RECEIPT OF EVIDENCE THAT AN EMERGENCY EXISTS WHICH WOULD CONSTITUTE A HAZARD TO PERSONS OR PROPERTY.
- 32. STOCKPILING OF MATERIALS SHALL BE SUBJECT TO CITY APPROVAL AND SHALL BE REMOVED OR RELOCATED WHEN REQUIRED FOR PUBLIC HEALTH AND SAFETY.
- 33. THE LOCATION AND SIZES OF THE UNDERGROUND UTILITIES SHOWN HEREON ARE APPROXIMATE OR SCHEMATIC IN NATURE USING INFORMATION FURNISHED BY THE RESPECTIVE AGENCIES. THE CONTRACTOR IS RESPONSIBLE FOR VERIFYING ALL UTILITY INFORMATION AND TAKING PROPER PRECAUTIONS TO PROTECT EXISTING UTILITIES. UTILITIES SHALL BE FIELD-VERIFIED BY POTHOLING PRIOR TO COMMENCING ANY GRADING, DEMOLITION, TRENCHING OR ROAD EXCAVATION.
- 34. THE CONTRACTOR SHALL TAKE PRECAUTIONARY MEASURES TO PROTECT UTILITY LINES AND STRUCTURES SHOWN AS WELL AS ANY AND ALL OTHERS NOT OF RECORD OR NOT SHOWN ON THESE DRAWINGS. EXISTING UTILITY SERVICE LATERALS ARE SPECIFICALLY NOT SHOWN ON THESE DRAWINGS AND ARE TO BE PROTECTED BY THE CONTRACTOR.
- 35. ALL EXISTING SURVEY MONUMENTS SHALL BE PRESERVED. ANY MONUMENT DISTURBED WITHOUT THE WRITTEN CONSENT OF THE CITY SURVEYOR MAY INCUR A FINE OF UP TO \$5000. CONTRACTOR SHALL ARRANGE AND PAY FOR PREVIOUS STRUCTURE REFERENCING AND REPLACEMENT OF ANY MONUMENT WHICH MAY BE DISTURBED BY HIS WORK. REFER TO SECTION 8771 OF THE BUSINESS AND PROFESSIONS CODE.
- 36. THE CONTRACTOR SHALL NOT DESTROY ANY PERMANENT SURVEY POINTS WITHOUT THE CONSENT OF THE CITY ENGINEER. ANY PERMANENT MONUMENT OR BENCHMARK DESTROYED SHALL BE REPLACED BY A LICENSED SURVEYOR AT THE CONTRACTOR'S EXPENSE. THE PROJECT SURVEYOR SHALL FILE A CORNER RECORD WITH THE COUNTY AT THE CONTRACTOR'S EXPENSE. IN THE EVENT THE SURVEY IS DONE BY THE CONTRACTOR, MONUMENTS WITH THE POTENTIAL TO BE IMPACTED BY THE WORK SHALL BE REFERENCED AND RECORDS FILED (BY THE CONTRACTOR'S SURVEYOR) WITH THE COUNTY SURVEYOR. PRIOR TO THE START OF ANY EXCAVATION AT THE SITE, COPIES OF THE RECORDED DOCUMENTS SHALL BE DELIVERED TO THE CITY SURVEYOR.
- 37. THE CITY REPRESENTATIVES SHALL BE PRESENT DURING THE MARKING OF LOCATION OF POLES, CABINETS, ETC. DOCUMENT APPROVAL OF ALL SUCH LOCATIONS.
- 38. THE PROJECT SHALL CONFORM TO ALL REQUIREMENTS OF CALTRANS ENCROACHMENT PERMIT # 0414-NSN1454 LOCATED AT 04-MRN-101-PM 3.38.


OF SAUS PLITO

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ATE 6 INTERSECTION IMPROVEMENTS

DATE: 05/24/2016

SCALE: **AS SHOWN**

PROJECT NO: CML5098(012

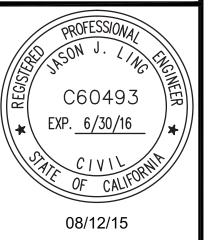DRAWN BY

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SYMBOLS & LEGEND

SYMBO	OL	LEGEND	SYM	BOL	LEGEND	SYMB	<u>OL</u>	LEGEND	<u>ABB</u>	REVIATION:
EXISTING	PROPOSED		EXISTING	PROPOSED		EXISTING	PROPOSED		AC	ASPHALT CONCRETE
× 157.7	× 158.5	SPOT ELEVATION	——————————————————————————————————————	<u> </u>	COMBINED SEWER SERVICE / MAIN			CURB	BKW CC	BACK OF WALK CENTER OF CIRCLE
Ⅲ OR ۩	III OR 10	CATCH BASIN	3'x5', CS		COMBINED SEWER BOX			CURB & GUTTER	CONC CP	CONCRETE CONTROL POINT
	ST	SAND TRAP	SD	SD				(E) CONTOURS	(E) EF	EXISTING EACH FACE
		SIGN	SD	VCP-SD	STORM DRAIN	——X———X——		(E) FENCE	EP FF	EDGE OF PAVEMENT FINISH FLOOR
		ROAD SIGN	3D	UD	VITRIFIED CLAY PIPE - STORM DRAIN			R/W	FG	FINISH GRADE
	\circ	MANHOLE/MANWAY			UNDER DRAIN			LIMIT OF WORK	FL FP	FLOW LINE FINISH PAVEMENT
0	0	CLEANOUT/VENT	— J T —	$=$ $\stackrel{JT}{=}$ $=$	JOINT TRENCH UTILITIES	W		WATER SERVICE	FNC FH	FENCE FIRE HYDRANT
		WATER METER	SS	SS	SANITARY SEWER SERVICE / MAIN	TV		COMCAST	GB INV	GRADE BREAK INVERT
	~	FIRE HYDRANT	G	G		2GAS		2in GAS LINE	MH (N)	MANHOLE NEW
					GAS	——18SS ——		18in SANITARY SEWER	NIC	NOT IN CONTRACT
	•	ELECTRICAL MANHOLE OR HANDHOLE	——— GST ———		UNDERGROUND GST				OFF OG	OFFSET ORIGINAL GRADE
0	•	POST OR GUARD POST	——————————————————————————————————————		HETCH HETCHY POWER				PPB PCC	PEDESTRIAN PUSH BU PORTLAND CEMENT C
5	lacksquare	VALVE AND CORP. STOP	——————————————————————————————————————		HIGH VOLTAGE ELECTRIC			AREA DRAIN	RW R/W	RETAINING WALL RIGHT OF WAY
\triangle		COMBINATION AIR RELEASE VALVE	LPW	LPW	LOW PRESSURE WATER	(SS)		SANITARY SEWER MANHOLE	S SED	SLOPE SEE ELECTRICAL DRA
Q	•	BLOWOFF		HPW		SD		STORM DRAIN MANHOLE	STA	STATION
·	\(\sqrt{\sq}}\sqrt{\sq}}}}}}}}}}}}}}}}}}}}}}}}}}}}}}}}}}}}	CATHODIC PROTECTION TEST STATION	——————————————————————————————————————		HIGH PRESSURE WATER			STORM DRAIN CATCH BASIN	SD SDI	STORM DRAIN STORM DRAIN INLET
D 4	ı			FW	FIRE WATER			DRAINAGE INLET	SS SSCO	SANITARY SEWER SANITARY SEWER CLE
	—	NEW GATE VALVE		DW	DOMESTIC WATER			DRAINAGE INLET	S/W TC	SIDEWALK TOP OF CURB
		REDUCER				S		TRAFFIC SIGNAL	TW UON	TOP OF WALL UNLESS OTHERWISE N
		SLOPE WITH FLOW DIRECTION		RWL	RECLAIMED WATER LINE	- S		TRAFFIC SIGNAL POLE W/STREET LIGHT	WV	WATER VALVE
			MCI		UNDERGROUND MCI	->		STREET LIGHT	W	WATER
		ASPHALT CONCRETE PAVEMENT	——— MFN ———		UNDERGROUND MFN			STREET LIGHT BOX		
	<u>V 7 7 7 7 7 7</u>		IVII IV		UNDERGROUND WIFN	S		TRAFFIC SIGNAL LIGHT BOX		
	A A A	CONCRETE SIDEWALK	——— MFS ———		UNDERGROUND MFS			TRAFFIC DETECTOR LID TELEPHONE BOX		
	▶		——— MSN———		LINDED ODOLIND MON	T		TELEPHONE MANHOLE		
			M2N		UNDERGROUND MSN			CABLE TV BOX		
		TRUNCATED DOMES	NXLK		UNDERGROUND NEXTLINK	TEL		TELEPHONE VAULT		
	000000000000000000000000000000000000000		——————————————————————————————————————		UNDERGROUND PACBELL			IRRIGATION CONTROL VALVE		
		GRANITE CURB & CONC GUTTER/ CONCRETE CURB AND GUTTER	FCB		ONDERGROUND PACELL	HOH		FIRE HYDRANT		
		CONCILLE COLD AND GOTTER	——————————————————————————————————————		UNDERGROUND SPRINT			WATER VALVE		
××-	-xx-	CHAIN LINK FENCE	TCG		UNDERGROUND TCG	VV		WATER METER		
			. 3 0			E		ELECTRIC BOX		
		STRUCTURE, BUILDING OR FACILITY	<u></u>	\triangle	HORIZONTAL OR VERTICAL	<i>PG&E</i> (E)		PG&E VAULT ELECTRIC LID		
		CONTOLID LINE	A 075 W	A 075 V	POINT OF INTERSECTION					
-155		CONTOUR LINE	▲ STP-X	▲ STP-X	BENCH MARK, TEST PIT	-∭JP		JOINT UTILITY POLE JOINT POLE W/STREET LIGHT		
3:1		EMBANKMENT AND SLOPE			SECTION LINE AND LIMIT OF WORK	>				
					PROPERTY LINE, RIGHT-OF-WAY LINE			GAS VALVE		
		DRAINAGEWAY OR DITCH			EASEMENT LINE	©		GAS METER BOLLARD		
		GUY ANCHOR			CENTER LINE	_		SIGN		
•		LIGHT POLE/UTILITY POLE (SEE POLE SCHEDULE)						MAILBOX FOUND IRON PIPE, SIZE AND		
, \ \	⊕				SILT FENCE	_		TAGGED AS NOTED		
OR _	OR ⊚ 	UTILITY POLE/LIGHT POLE (SEE POLE SCHEDULE)			DORE & JACK			FOUND MONUMENT, SIZED AND		
			-		UTILITY CASING PIPE	£ @ }		STAMPED, AS NOTED TREE SYMBOL AND DRIP LINE		
\sim		COMBINATION POLE	-		OPEN CUT	The state of the s				
\mathfrak{A}		DECIDUOUS TREE			UTILITY CASING PIPE	VIF		VERIFY IN FIELD		
	OR O	TREE LOCATION			NOTES:					
I					NOTES:					


SH BUTTON ENT CONCRETE DRAWINGS R CLEANOUT ISE NOTED

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GATE 6 INTERSECTION IMPROVEMENTS


05/24/2016 SCALE: **AS SHOWN**


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3 OF 23 SHEETS


NOTES:

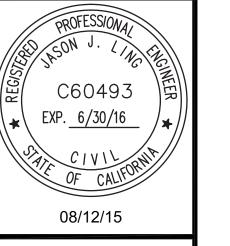- 1. SYMBOLS ON THIS SHEET APPLY ONLY TO THE CIVIL DRAWINGS. REFER TO OTHER DISCIPLINES FOR APPLICABLE SYMBOLS NOT PROVIDED HERE.
- 2. THIS IS A STANDARD SYMBOL SHEET, THEREFORE, SOME SYMBOLS MAY APPEAR ON THIS SHEET AND MAY NOT BE UTILIZED ON THIS PROJECT.



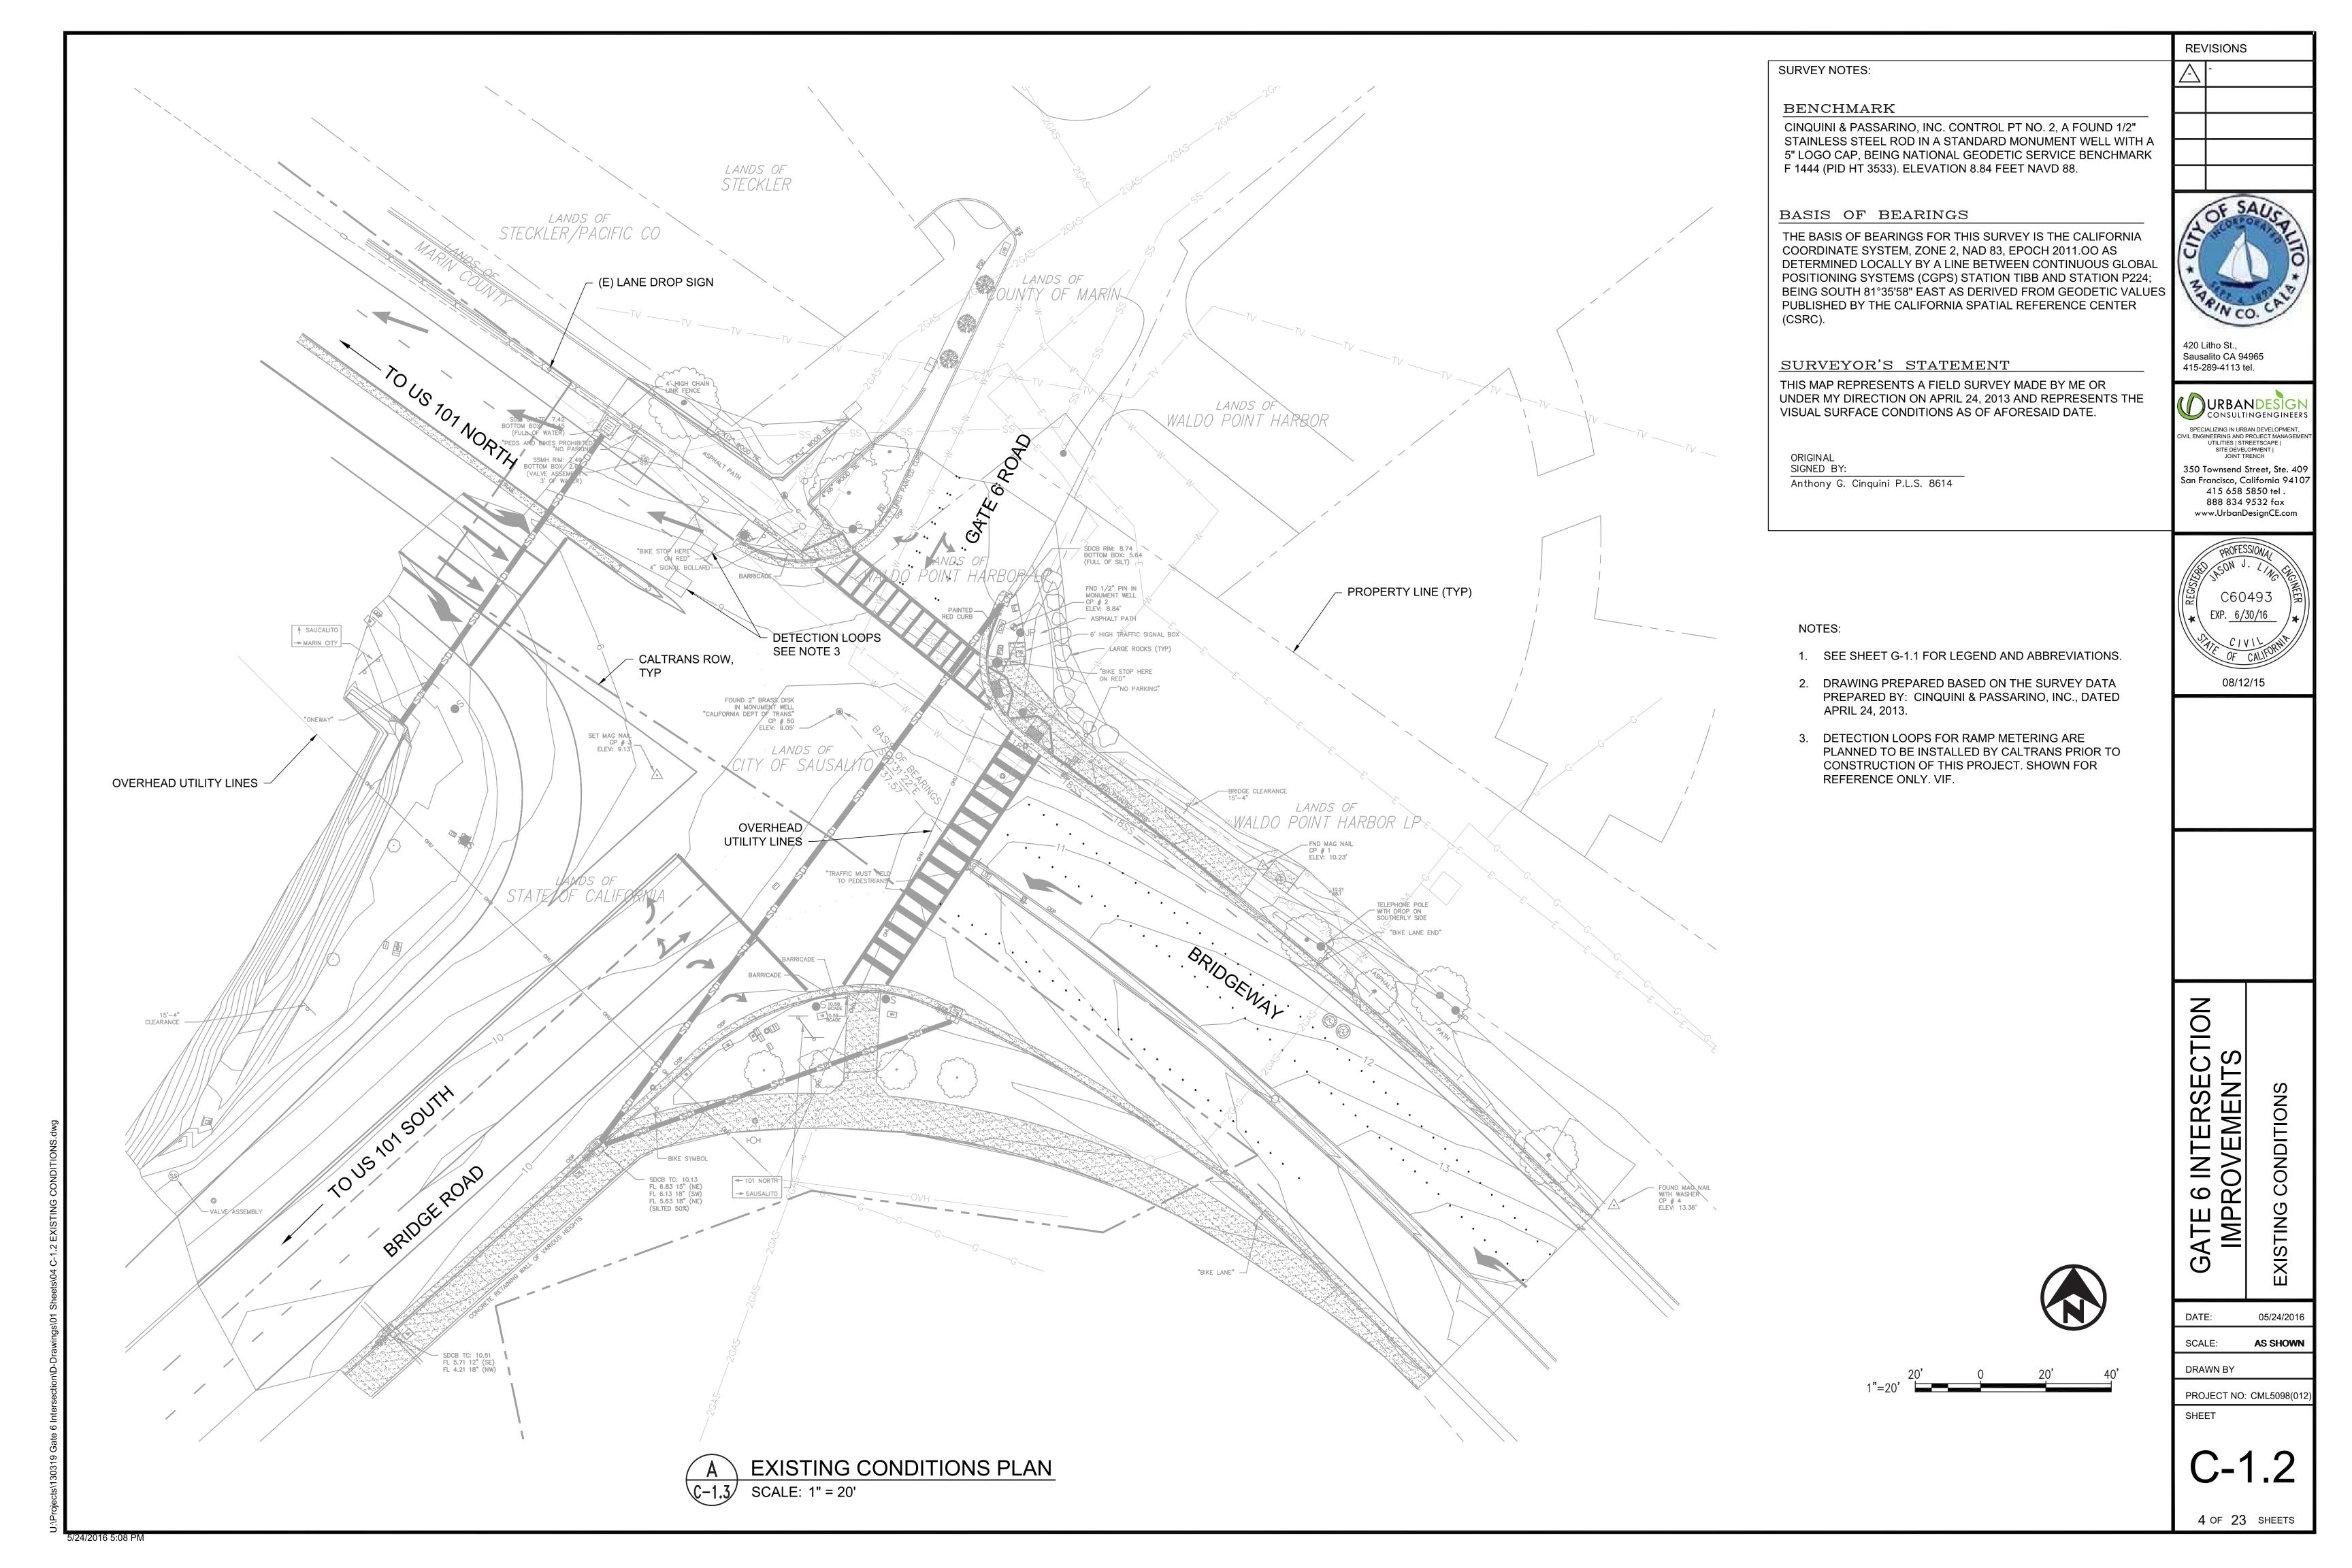

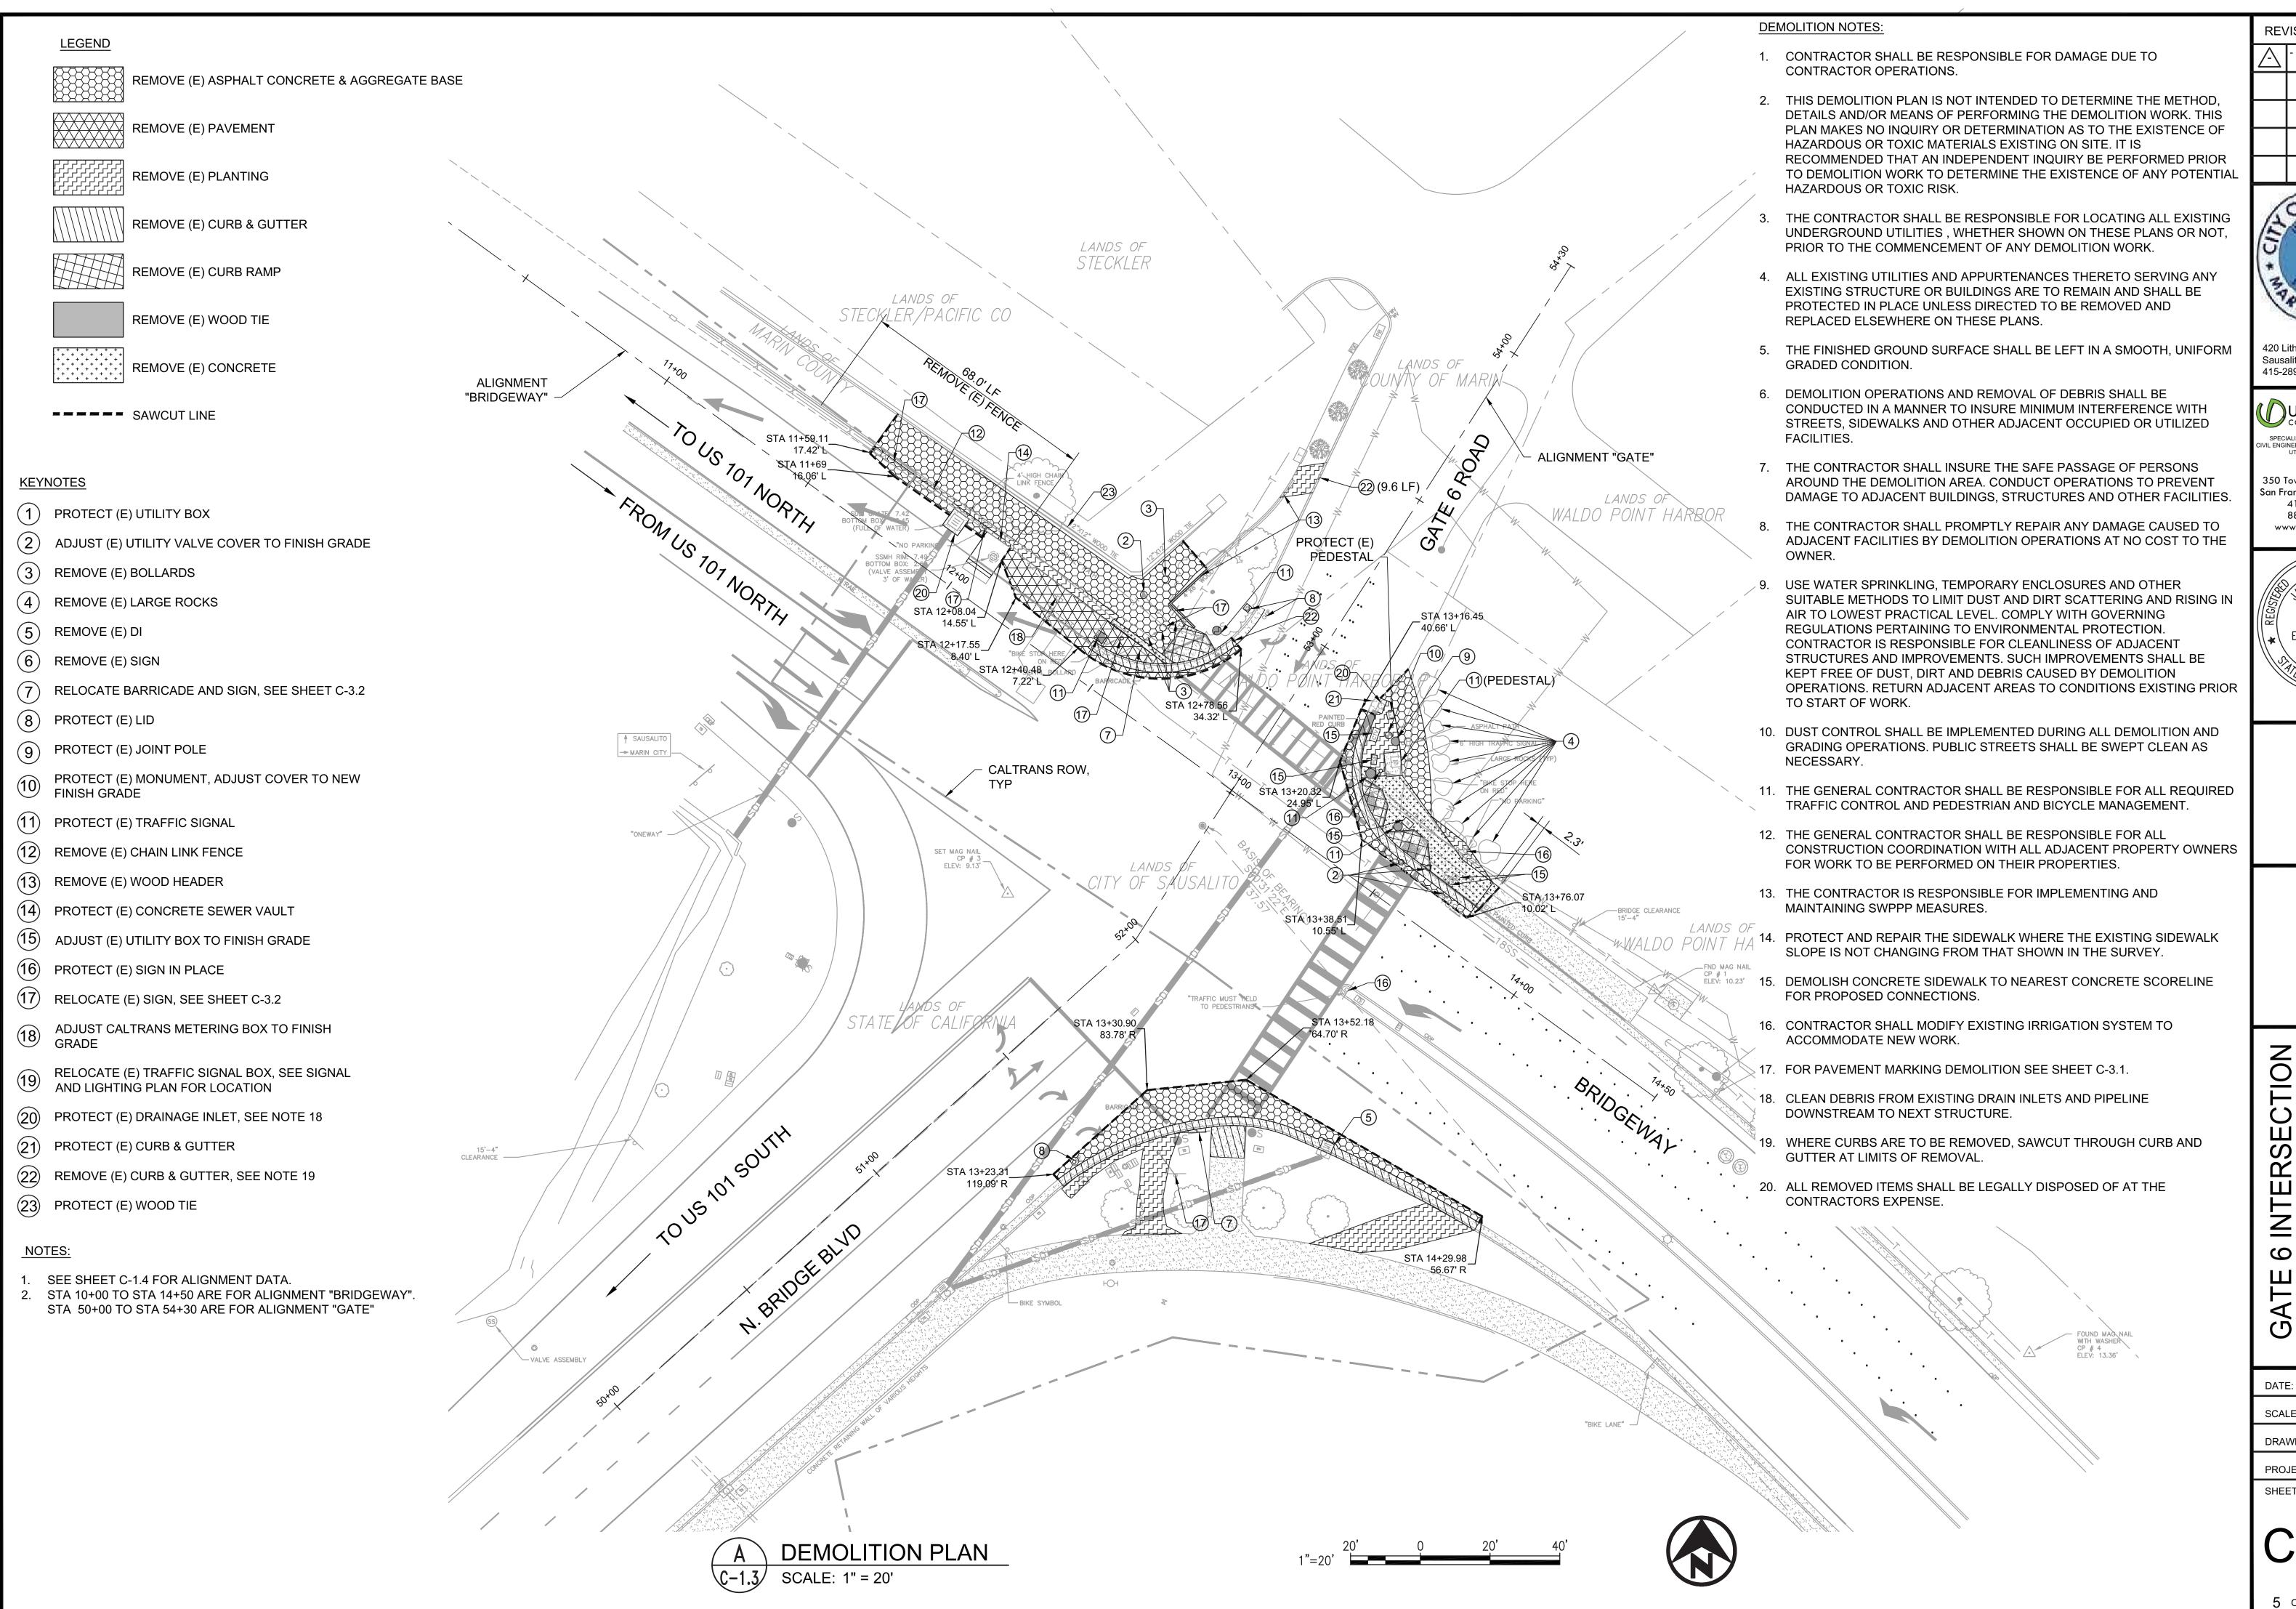
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08/12/15

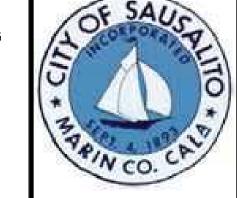
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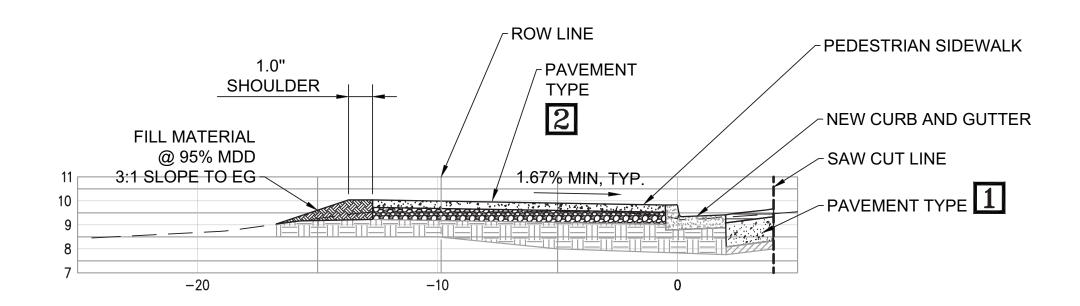
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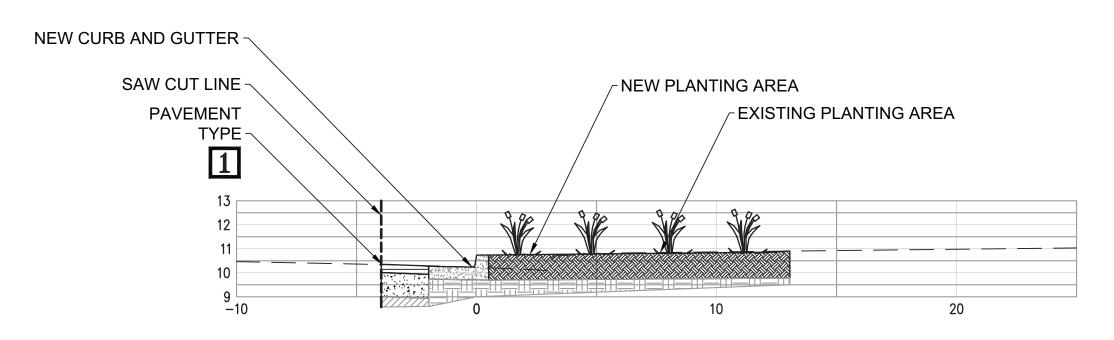
PROJECT NO: CML5098(01




BIKE LANE AND SIDEWALK TYPICAL SECTION SCALE: 1" = 4'

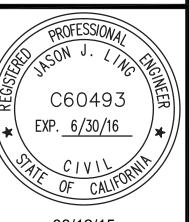

SIDEWALK TYPICAL SECTION C-2.1 SCALE: 1" = 4'

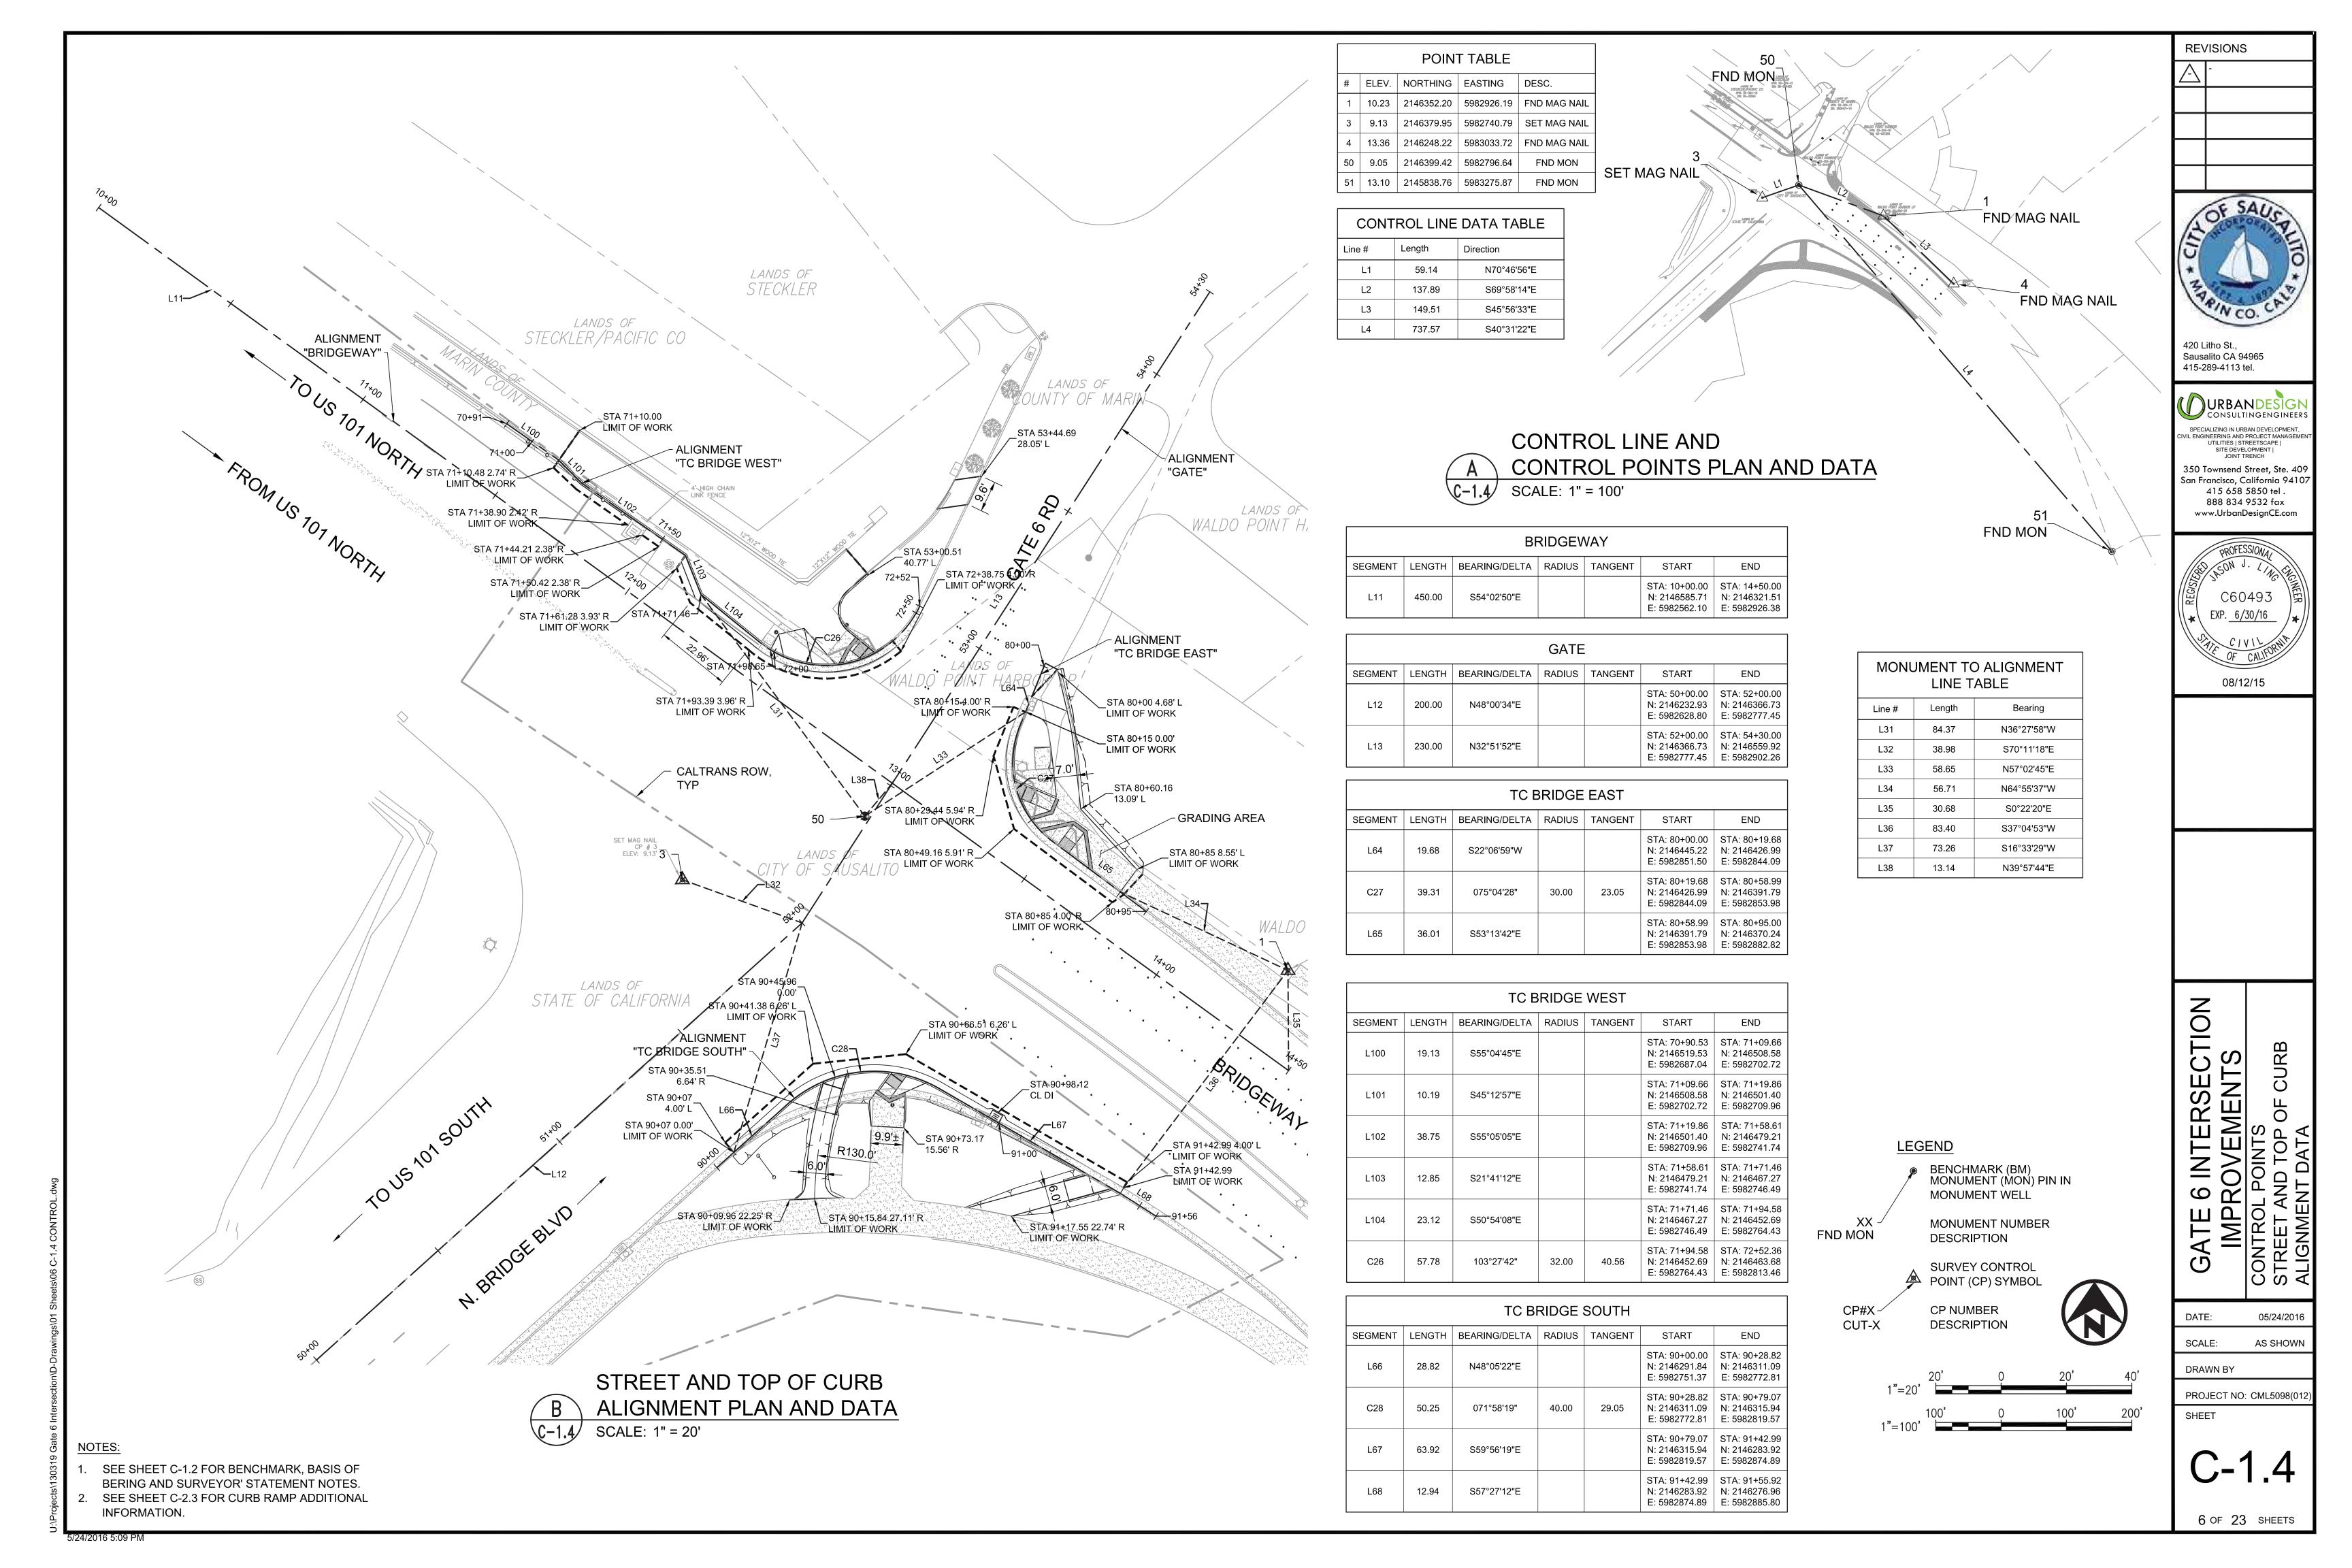


SIDEWALK TYPICAL SECTION SCALE: 1" = 4'

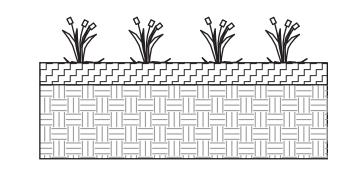

MULCH FILL MATERIAL @ 85% MDD, THICKNESS VARIES

NEW PLANTING TO MATCH EXISTING ADJACENT

TYPICAL PLANTER SECTION SCALE: N.T.S.

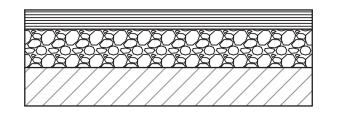

HOT MIX ASPHALT CONCRETE (AC) TYPE A AGGREGATE BASE CLASS 2 COMPACT TO

EXISTING SUB BASE, COMPACT TO 95% MDD

PAVEMENT TYPE 1

ASPHALT CONCRETE

CONCRETE

AGGREGATE BASE, CLASS 2, COMPACT TO 95% MDD

EXISTING GROUND, COMPACTED TO 95% MDD


PAVEMENT TYPE 2 CONCRETE SIDEWALK

PAVEMENT TYPE 3 ASPHALT CONCRETE HOT MIX ASPHALT CONCRETE (AC) TYPE A

AGGREGATE BASE CLASS 2 COMPACT TO

EXISTING GROUND, SUBGRADE, SCARIFIED AND COMPACTED TO 95% MDD

LEGEND:

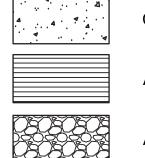

CONCRETE

ASPHALT CONCRETE

AGGREGATE BASE



EXISTING SUB BASE



PROJECT NO: CML5098(01)

7 OF 23 SHEETS

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C60493

EXP. 6/30/16

08/12/15

ATE 6 INTERSECTION IMPROVEMENTS


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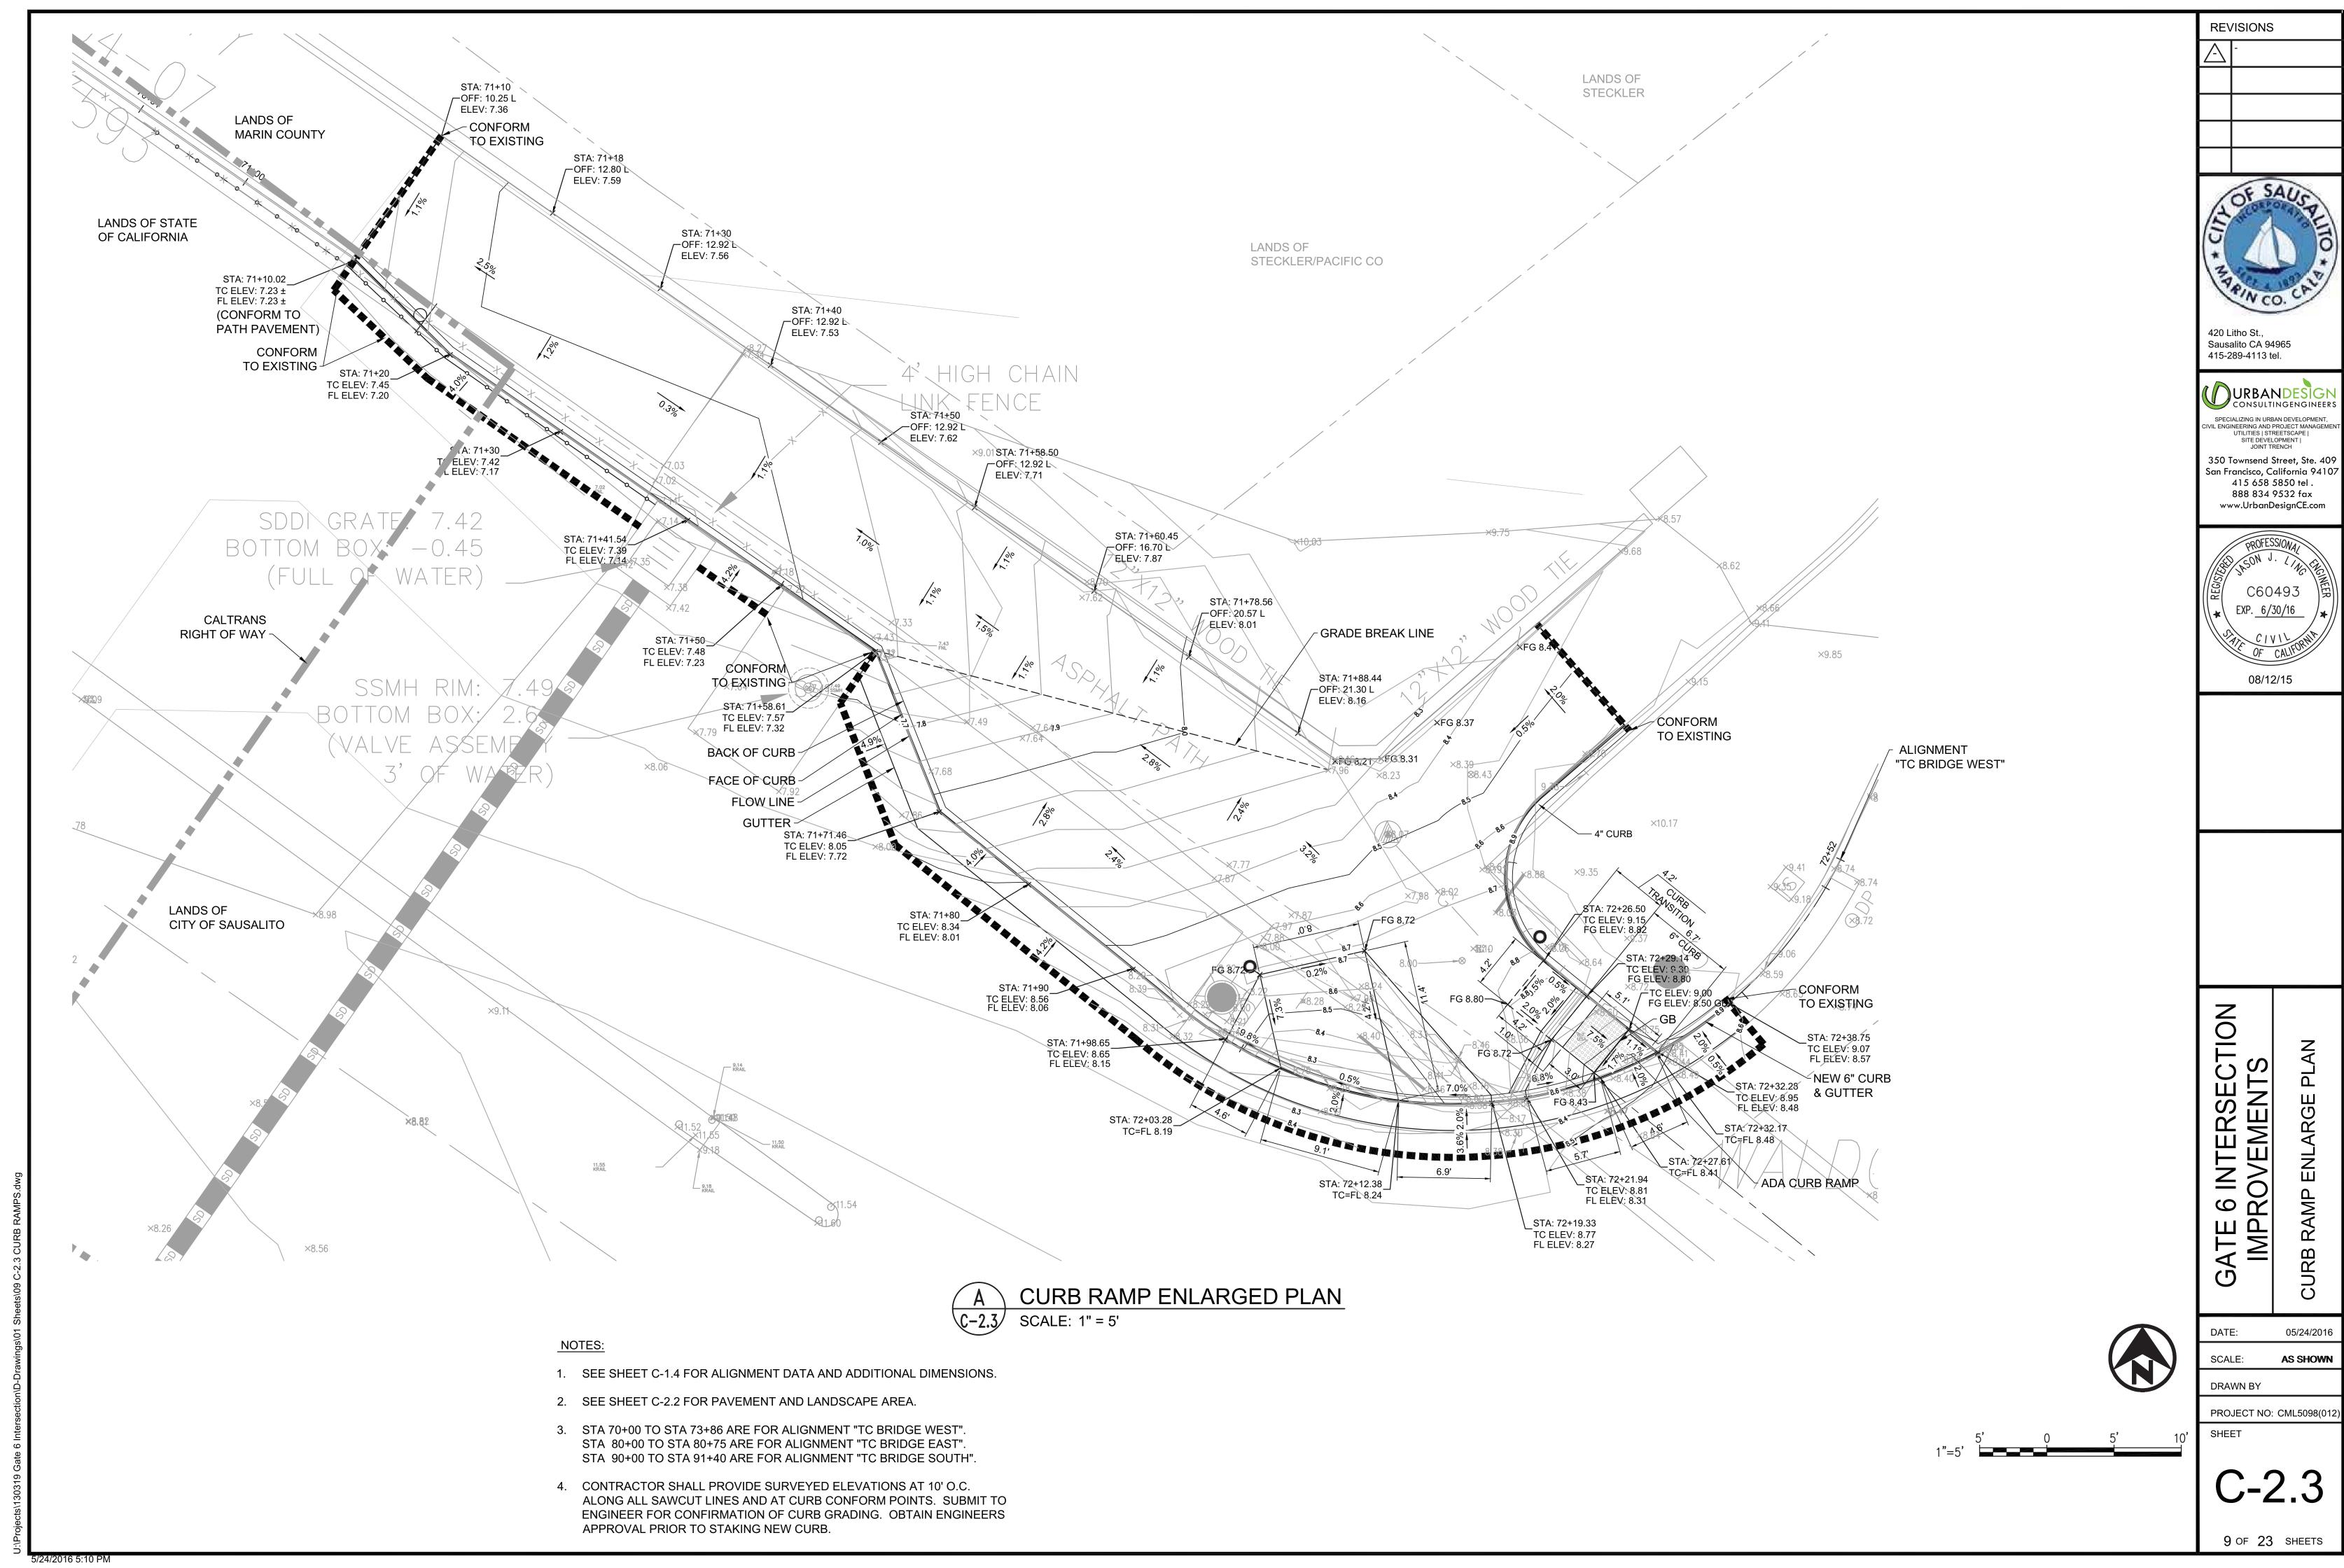
DATE:


SECTIONS

05/24/2016

AS SHOWN SCALE: DRAWN BY



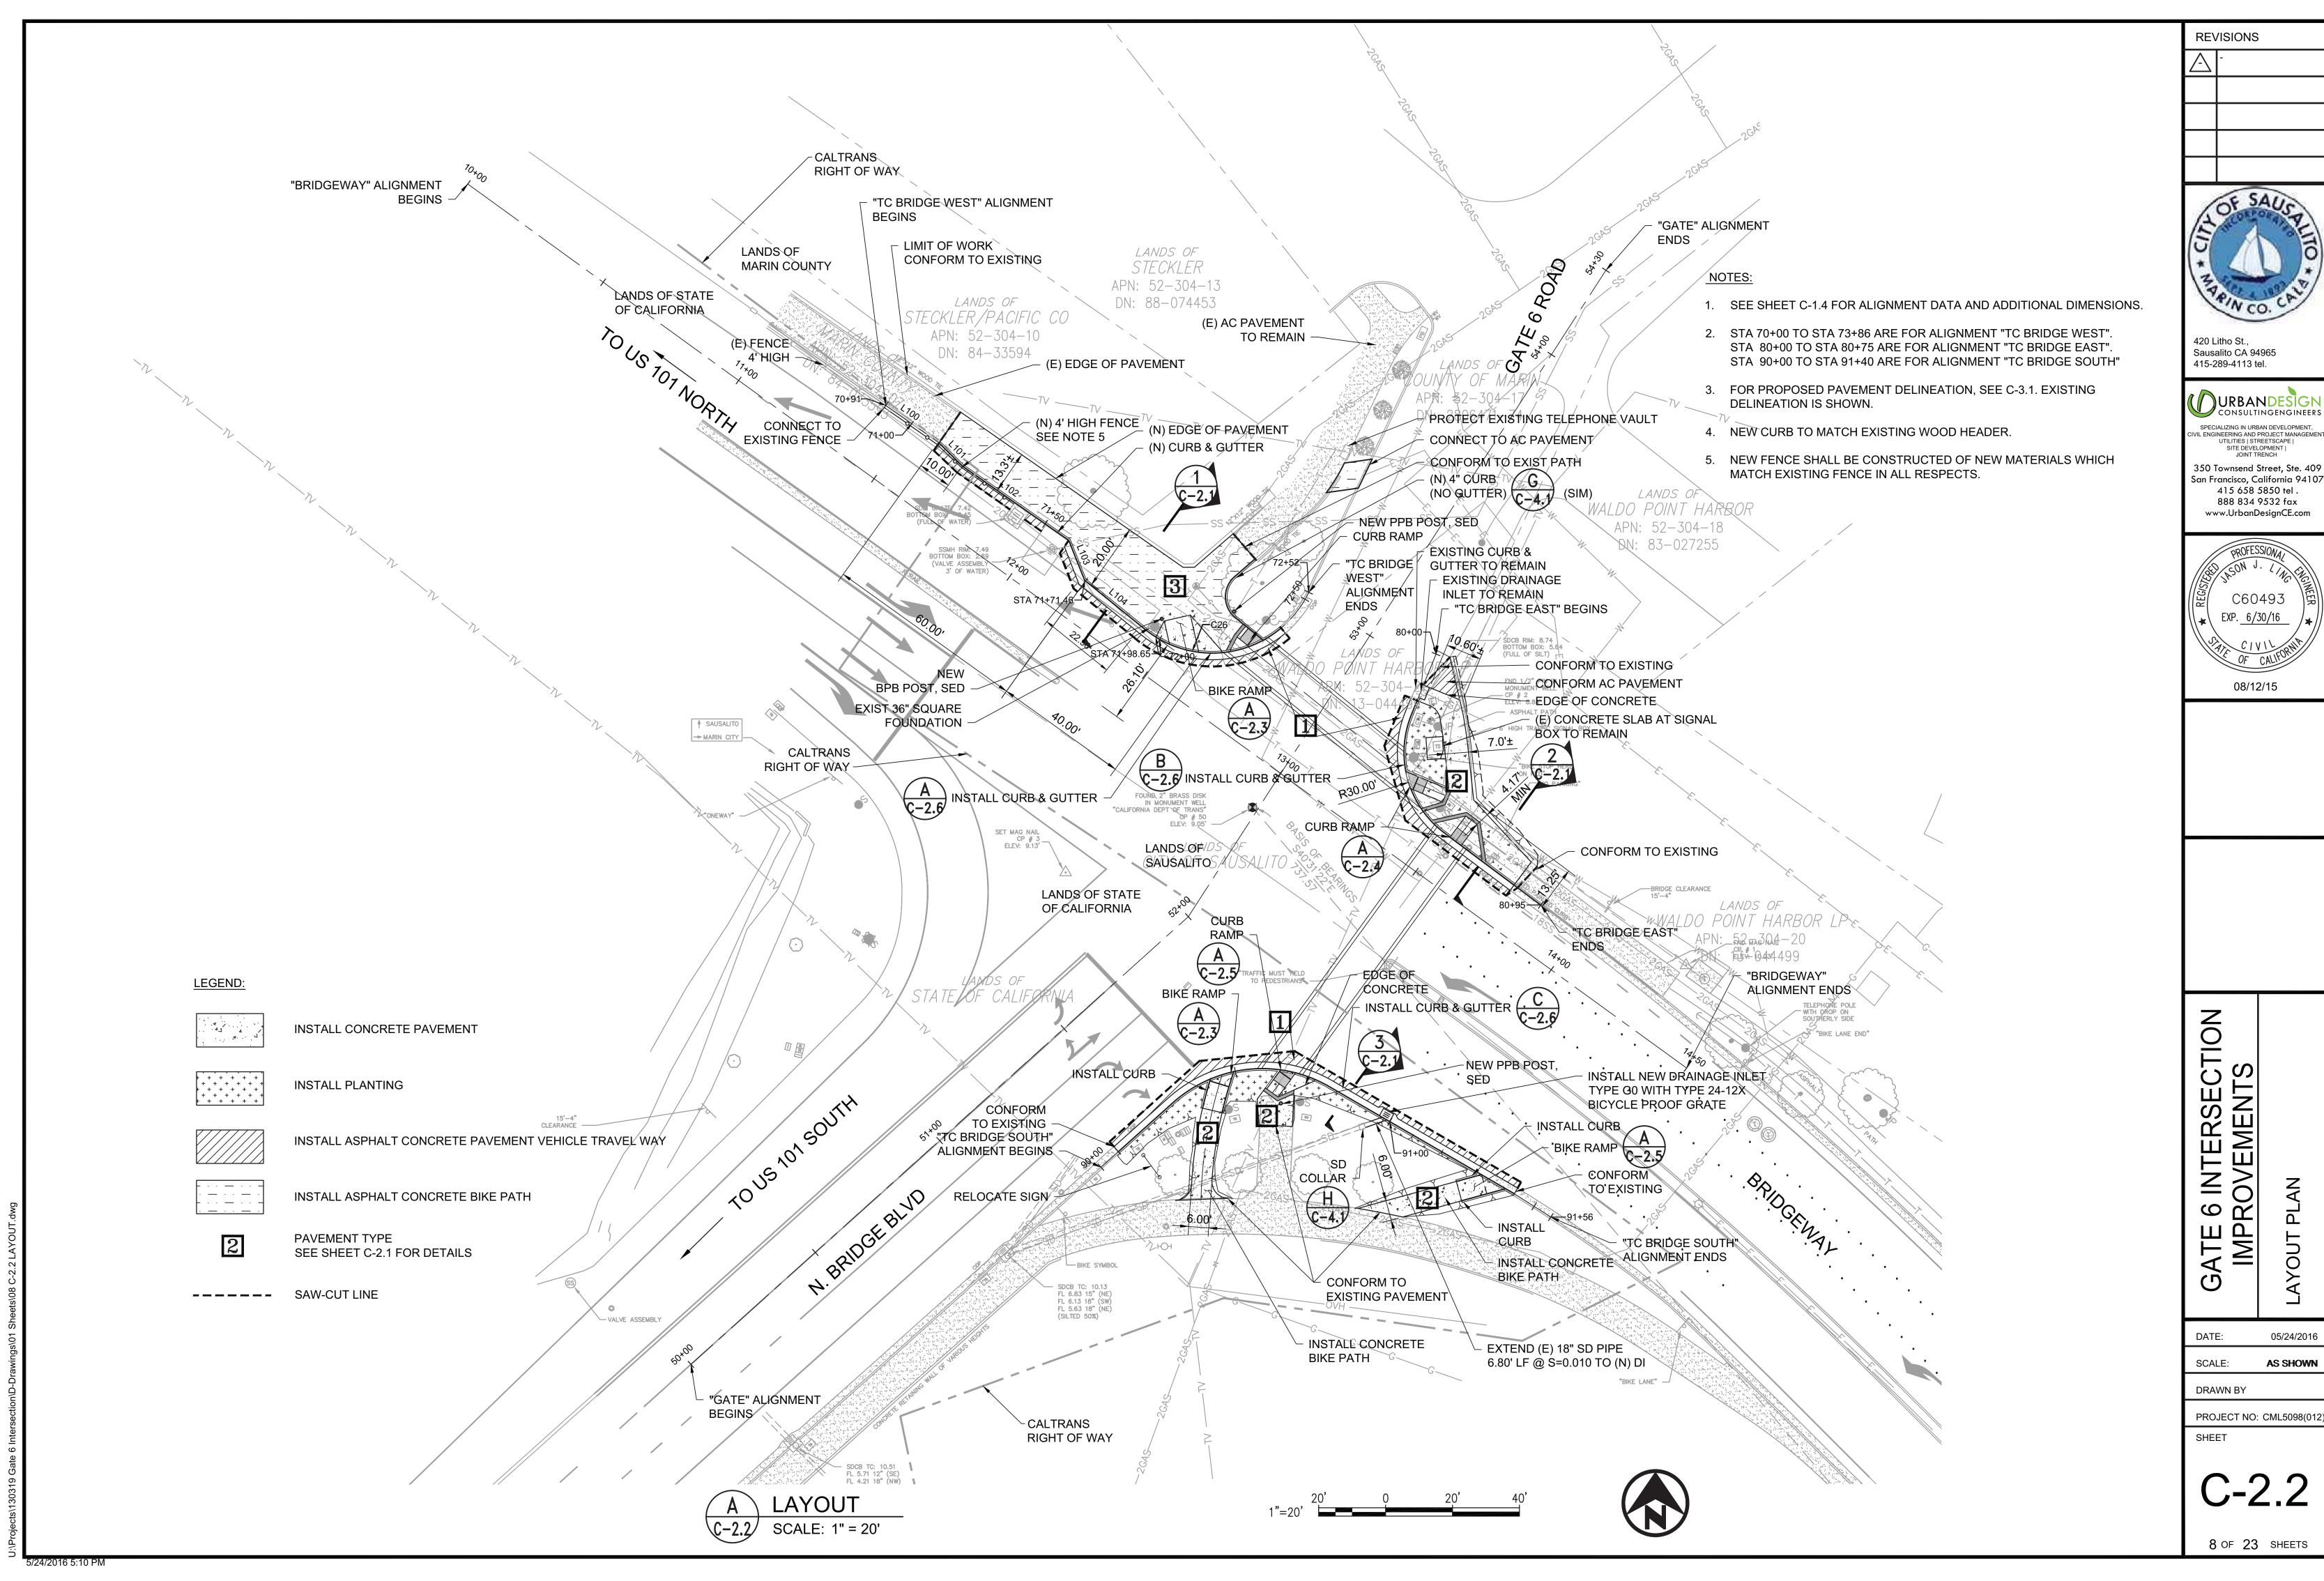

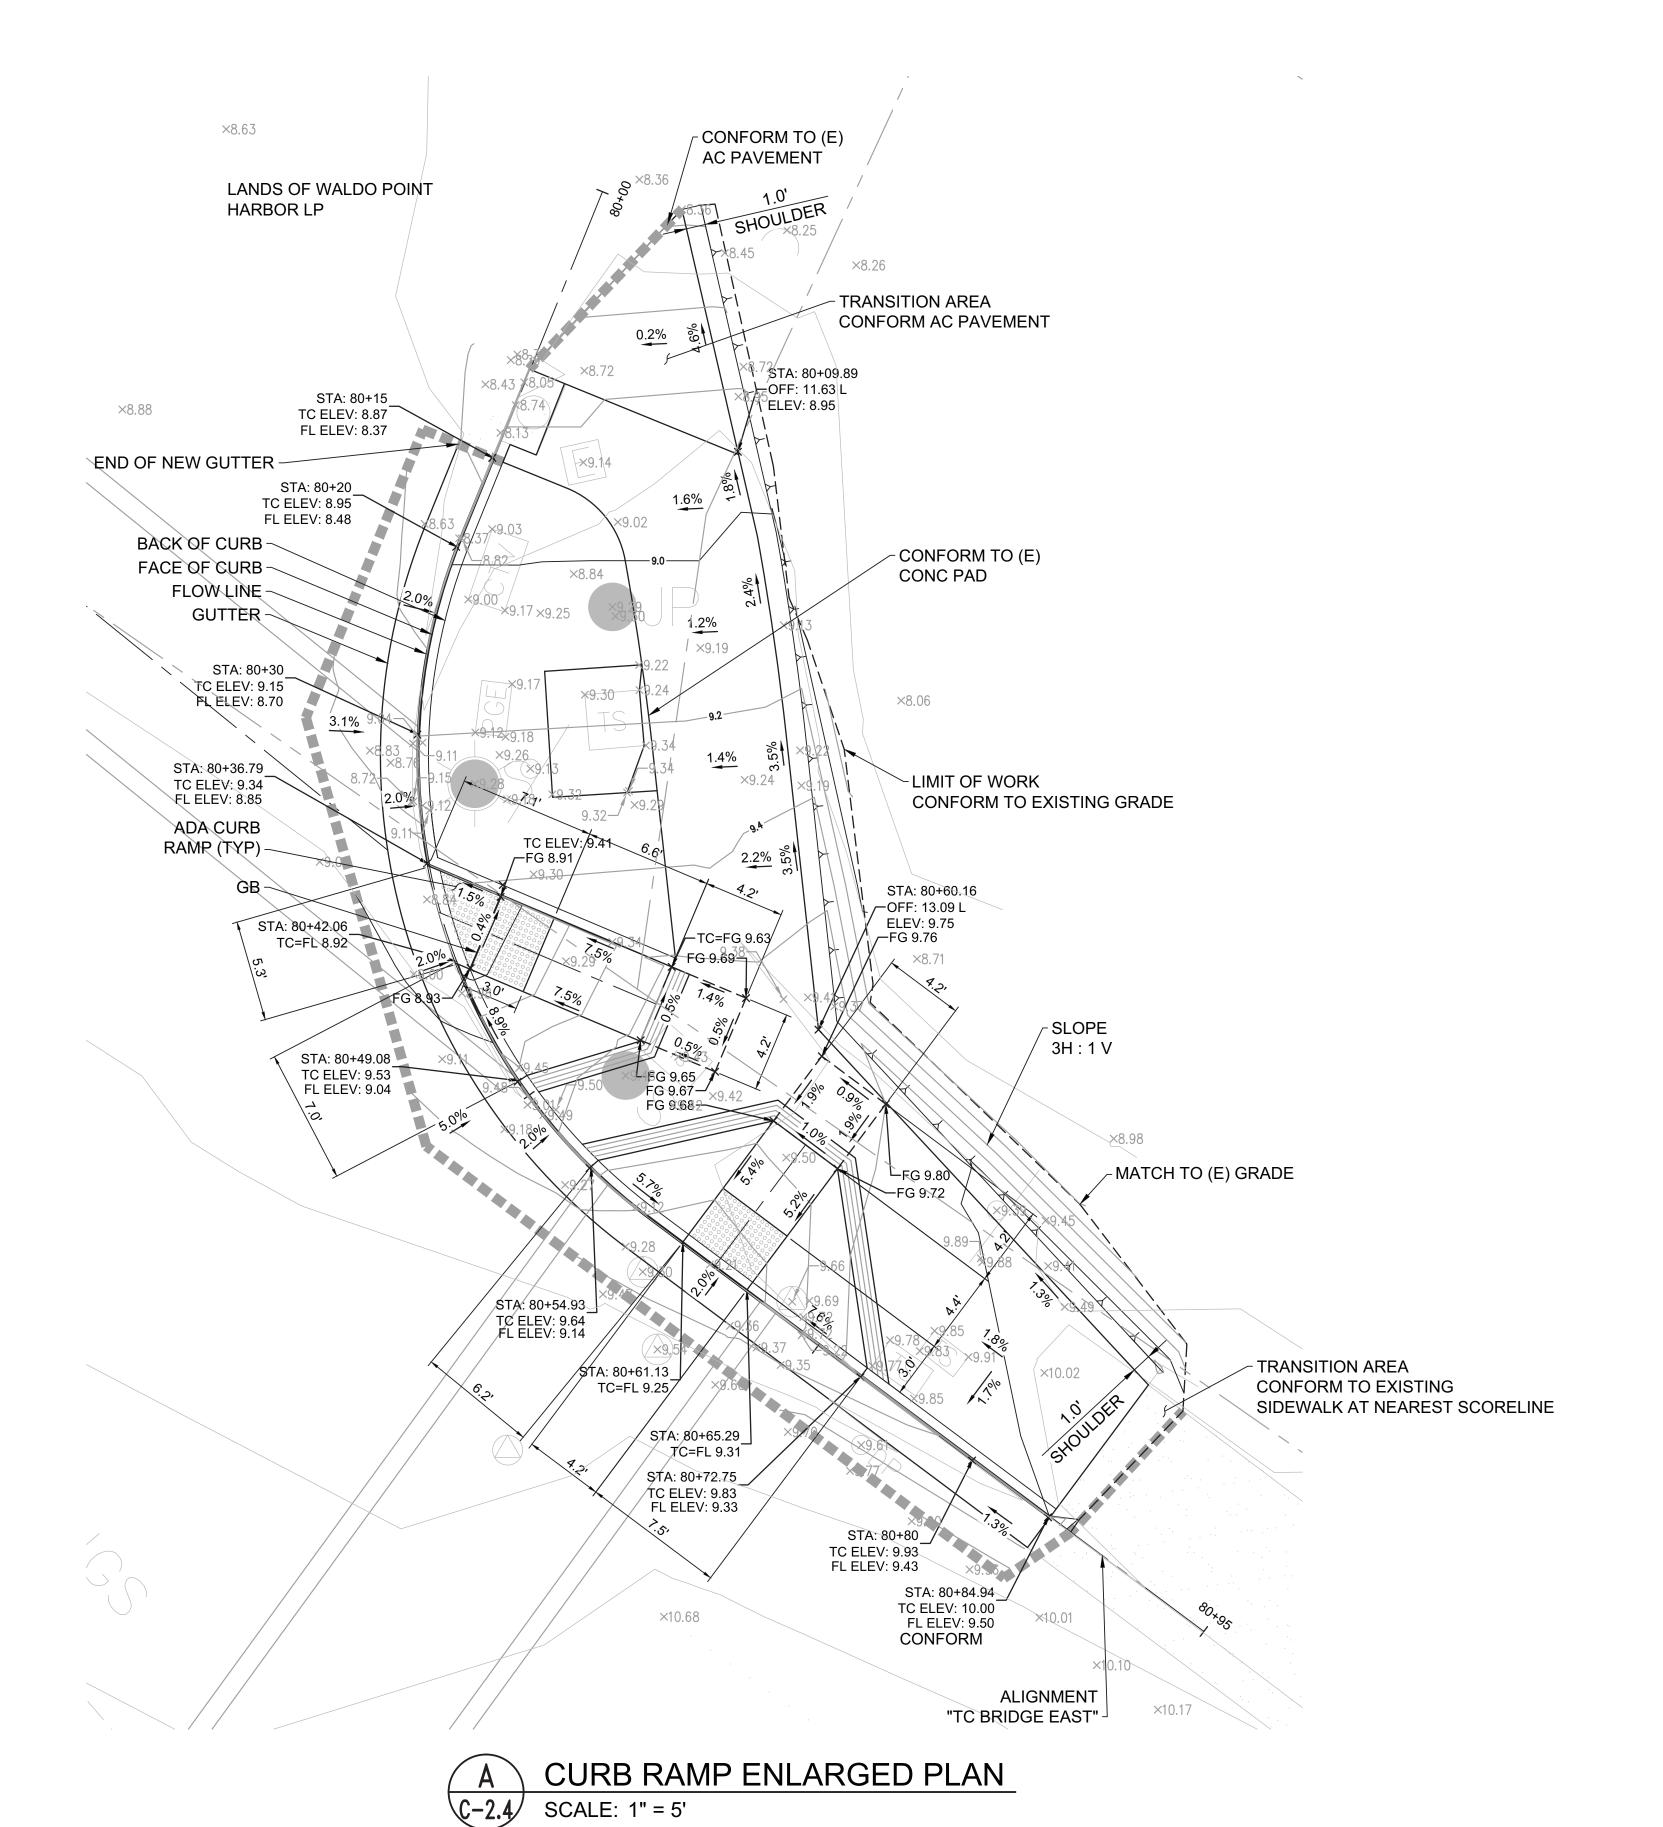


NOTES:

- 1. SEE SHEET C-1.4 FOR ALIGNMENT DATA AND ADDITIONAL DIMENSIONS.
- 2. SEE SHEET C-2.2 FOR PAVEMENT AND LANDSCAPE AREA.
- 3. STA 70+00 TO STA 73+86 ARE FOR ALIGNMENT "TC BRIDGE WEST". STA 80+00 TO STA 80+75 ARE FOR ALIGNMENT "TC BRIDGE EAST". STA 90+00 TO STA 91+40 ARE FOR ALIGNMENT "TC BRIDGE SOUTH".
- 4. CONTRACTOR SHALL PROVIDE SURVEYED ELEVATIONS AT 10' O.C.ALONG ALL SAWCUT LINES AND AT CURB CONFORM POINTS. SUBMIT TO ENGINEER FOR CONFIRMATION OF CURB GRADING. OBTAIN ENGINEERS APPROVAL PRIOR TO STAKING NEW CURB.





REVISIONS
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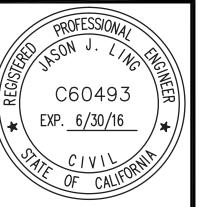

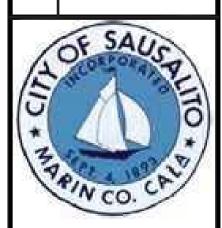
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08/12/15

ATE 6 INTERSECTION IMPROVEMENTS

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DATE: 05/24/2016

SCALE: AS SHOWN


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PROJECT NO: CML5098

PROJECT NO: CML5098(012

C-2.4

10 OF 23 SHEETS

/319 Gate 6 Intersection\D-Drawings∖01 Sheets∖10-11 C

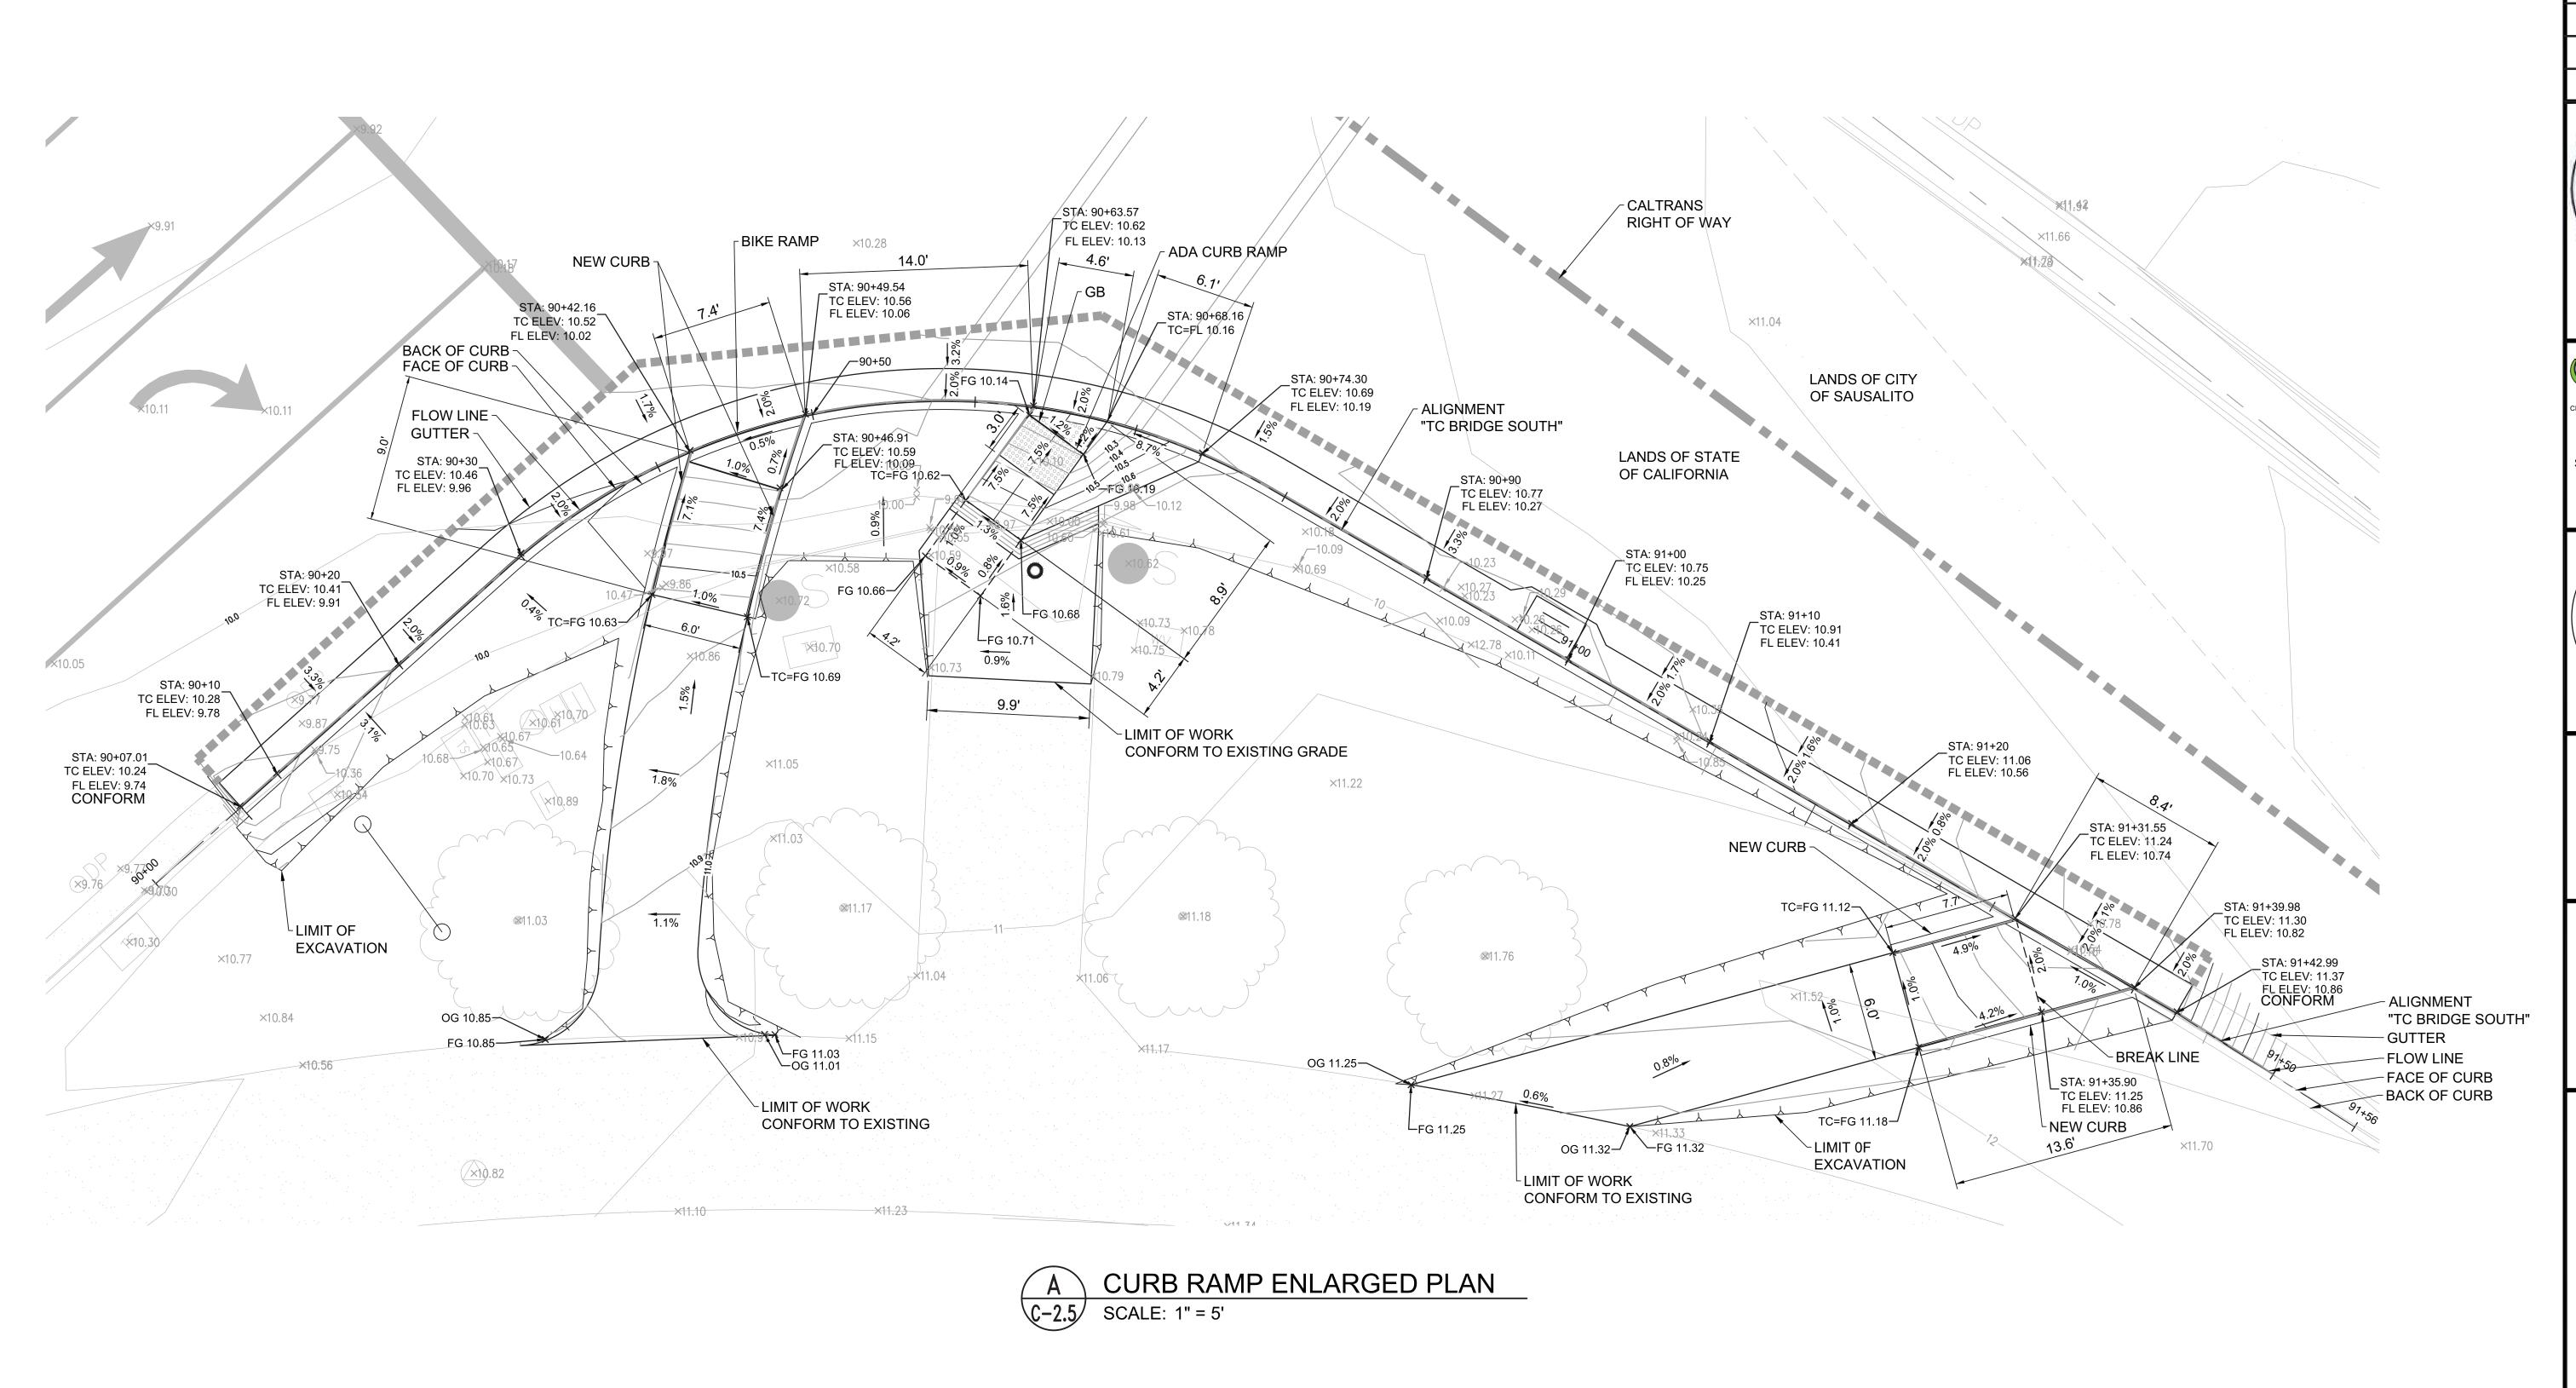

NOTES:

- 1. SEE SHEET C-1.4 FOR ALIGNMENT DATA AND ADDITIONAL DIMENSIONS.
- 2. SEE SHEET C-2.2 FOR PAVEMENT AND LANDSCAPE AREA.
- 3. STA 70+00 TO STA 73+86 ARE FOR ALIGNMENT "TC BRIDGE WEST". STA 80+00 TO STA 80+75 ARE FOR ALIGNMENT "TC BRIDGE EAST". STA 90+00 TO STA 91+40 ARE FOR ALIGNMENT "TC BRIDGE SOUTH".
- 4. CONTRACTOR SHALL PROVIDE SURVEYED ELEVATIONS AT 10' O.C.ALONG ALL SAWCUT LINES AND AT CURB CONFORM POINTS. SUBMIT TO ENGINEER FOR CONFIRMATION OF CURB GRADING. OBTAIN ENGINEERS APPROVAL PRIOR TO STAKING NEW CURB.





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EXP. 6/30/16

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08/12/15

ATE 6 INTERSECTION IMPROVEMENTS

DATE: 05/24/2016

SCALE: AS SHOWN


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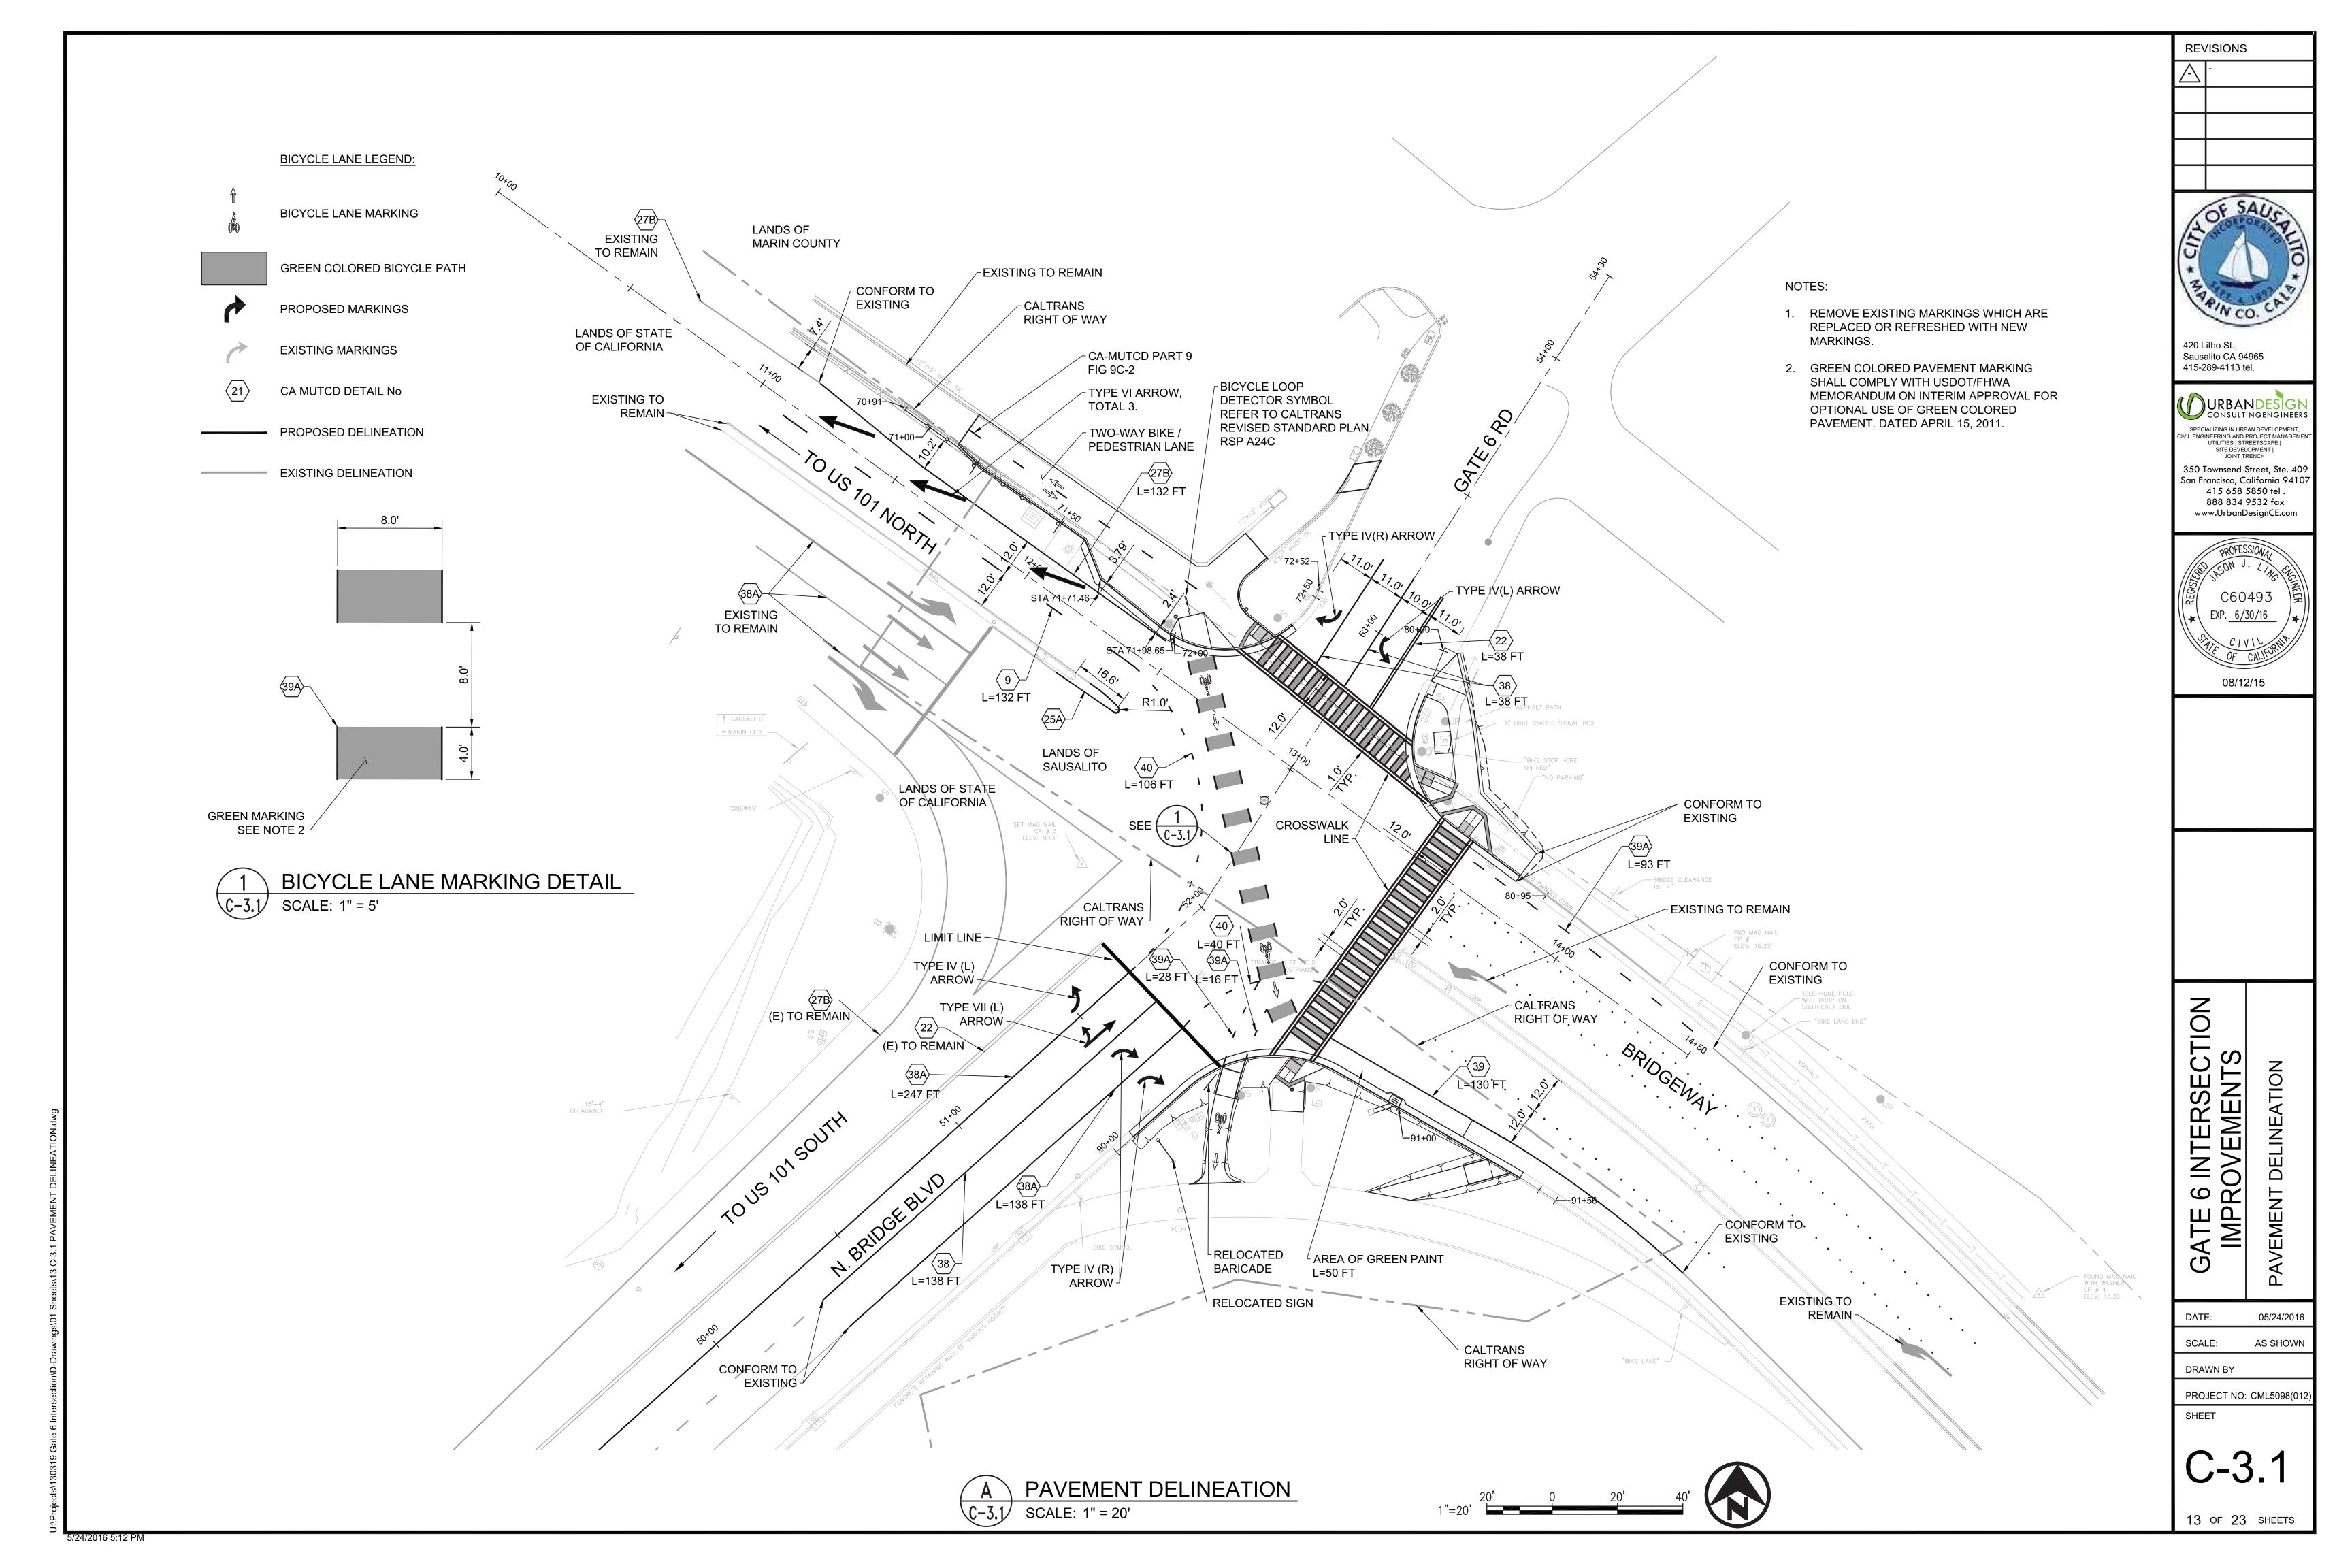
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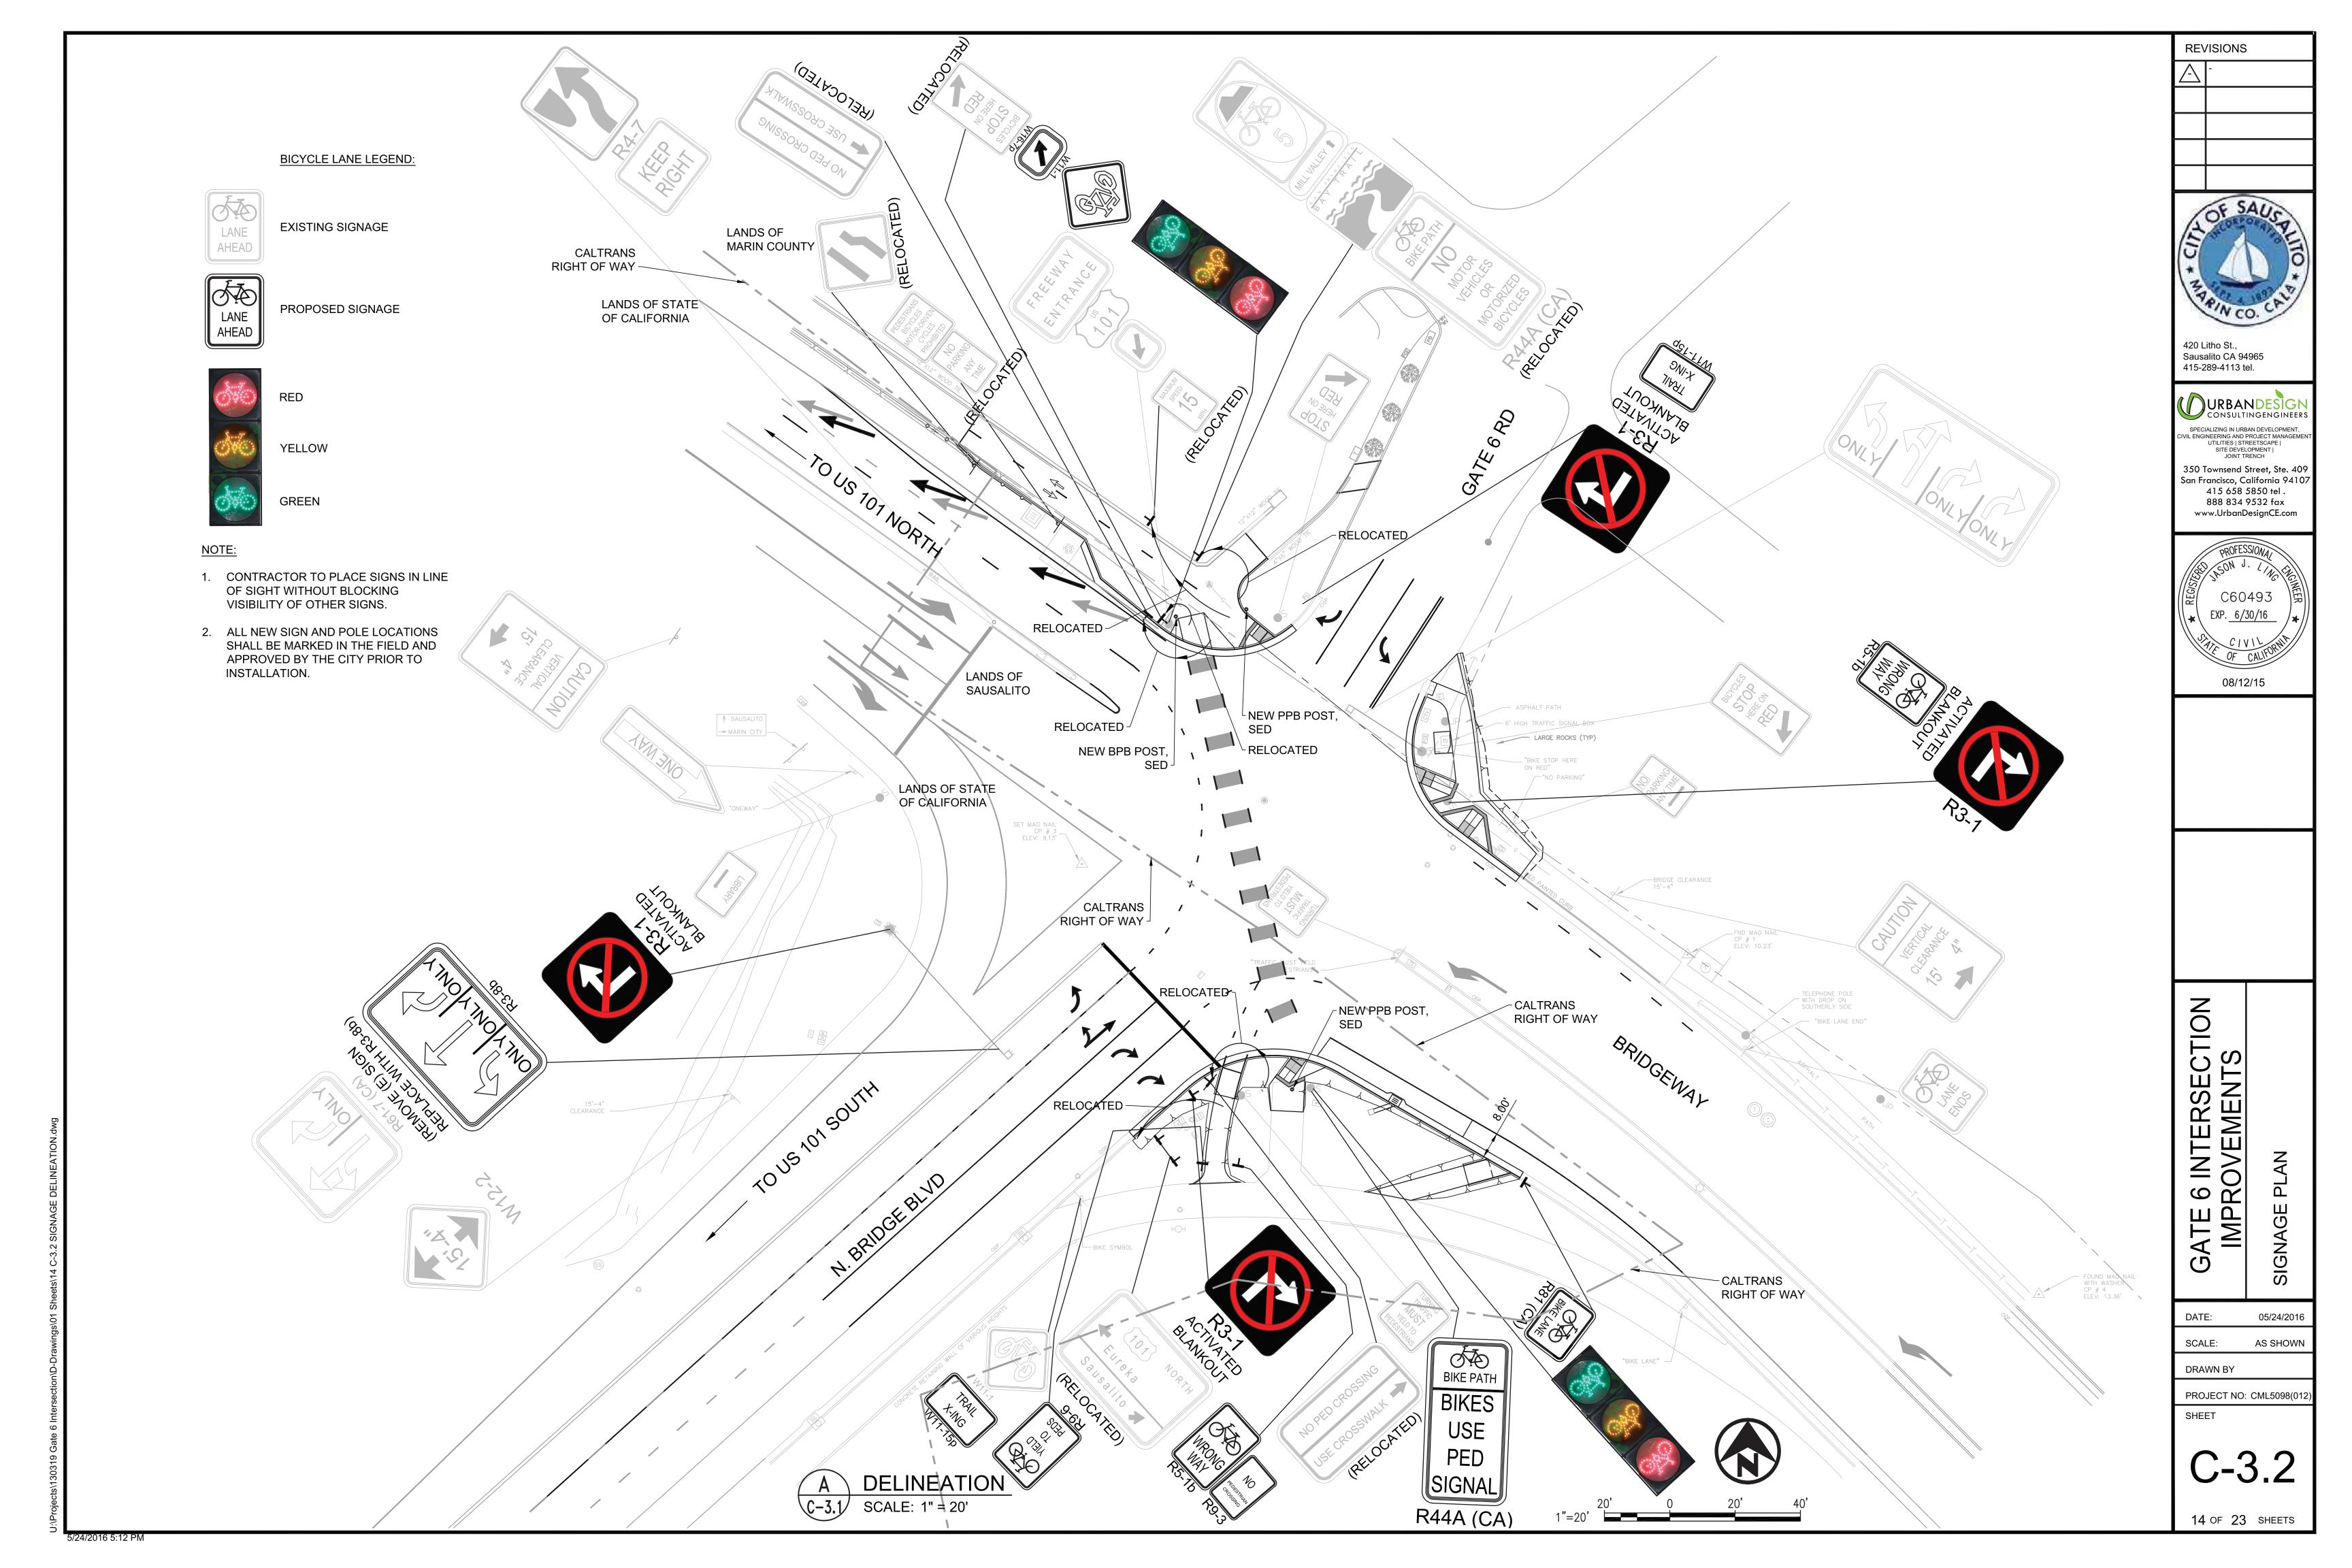
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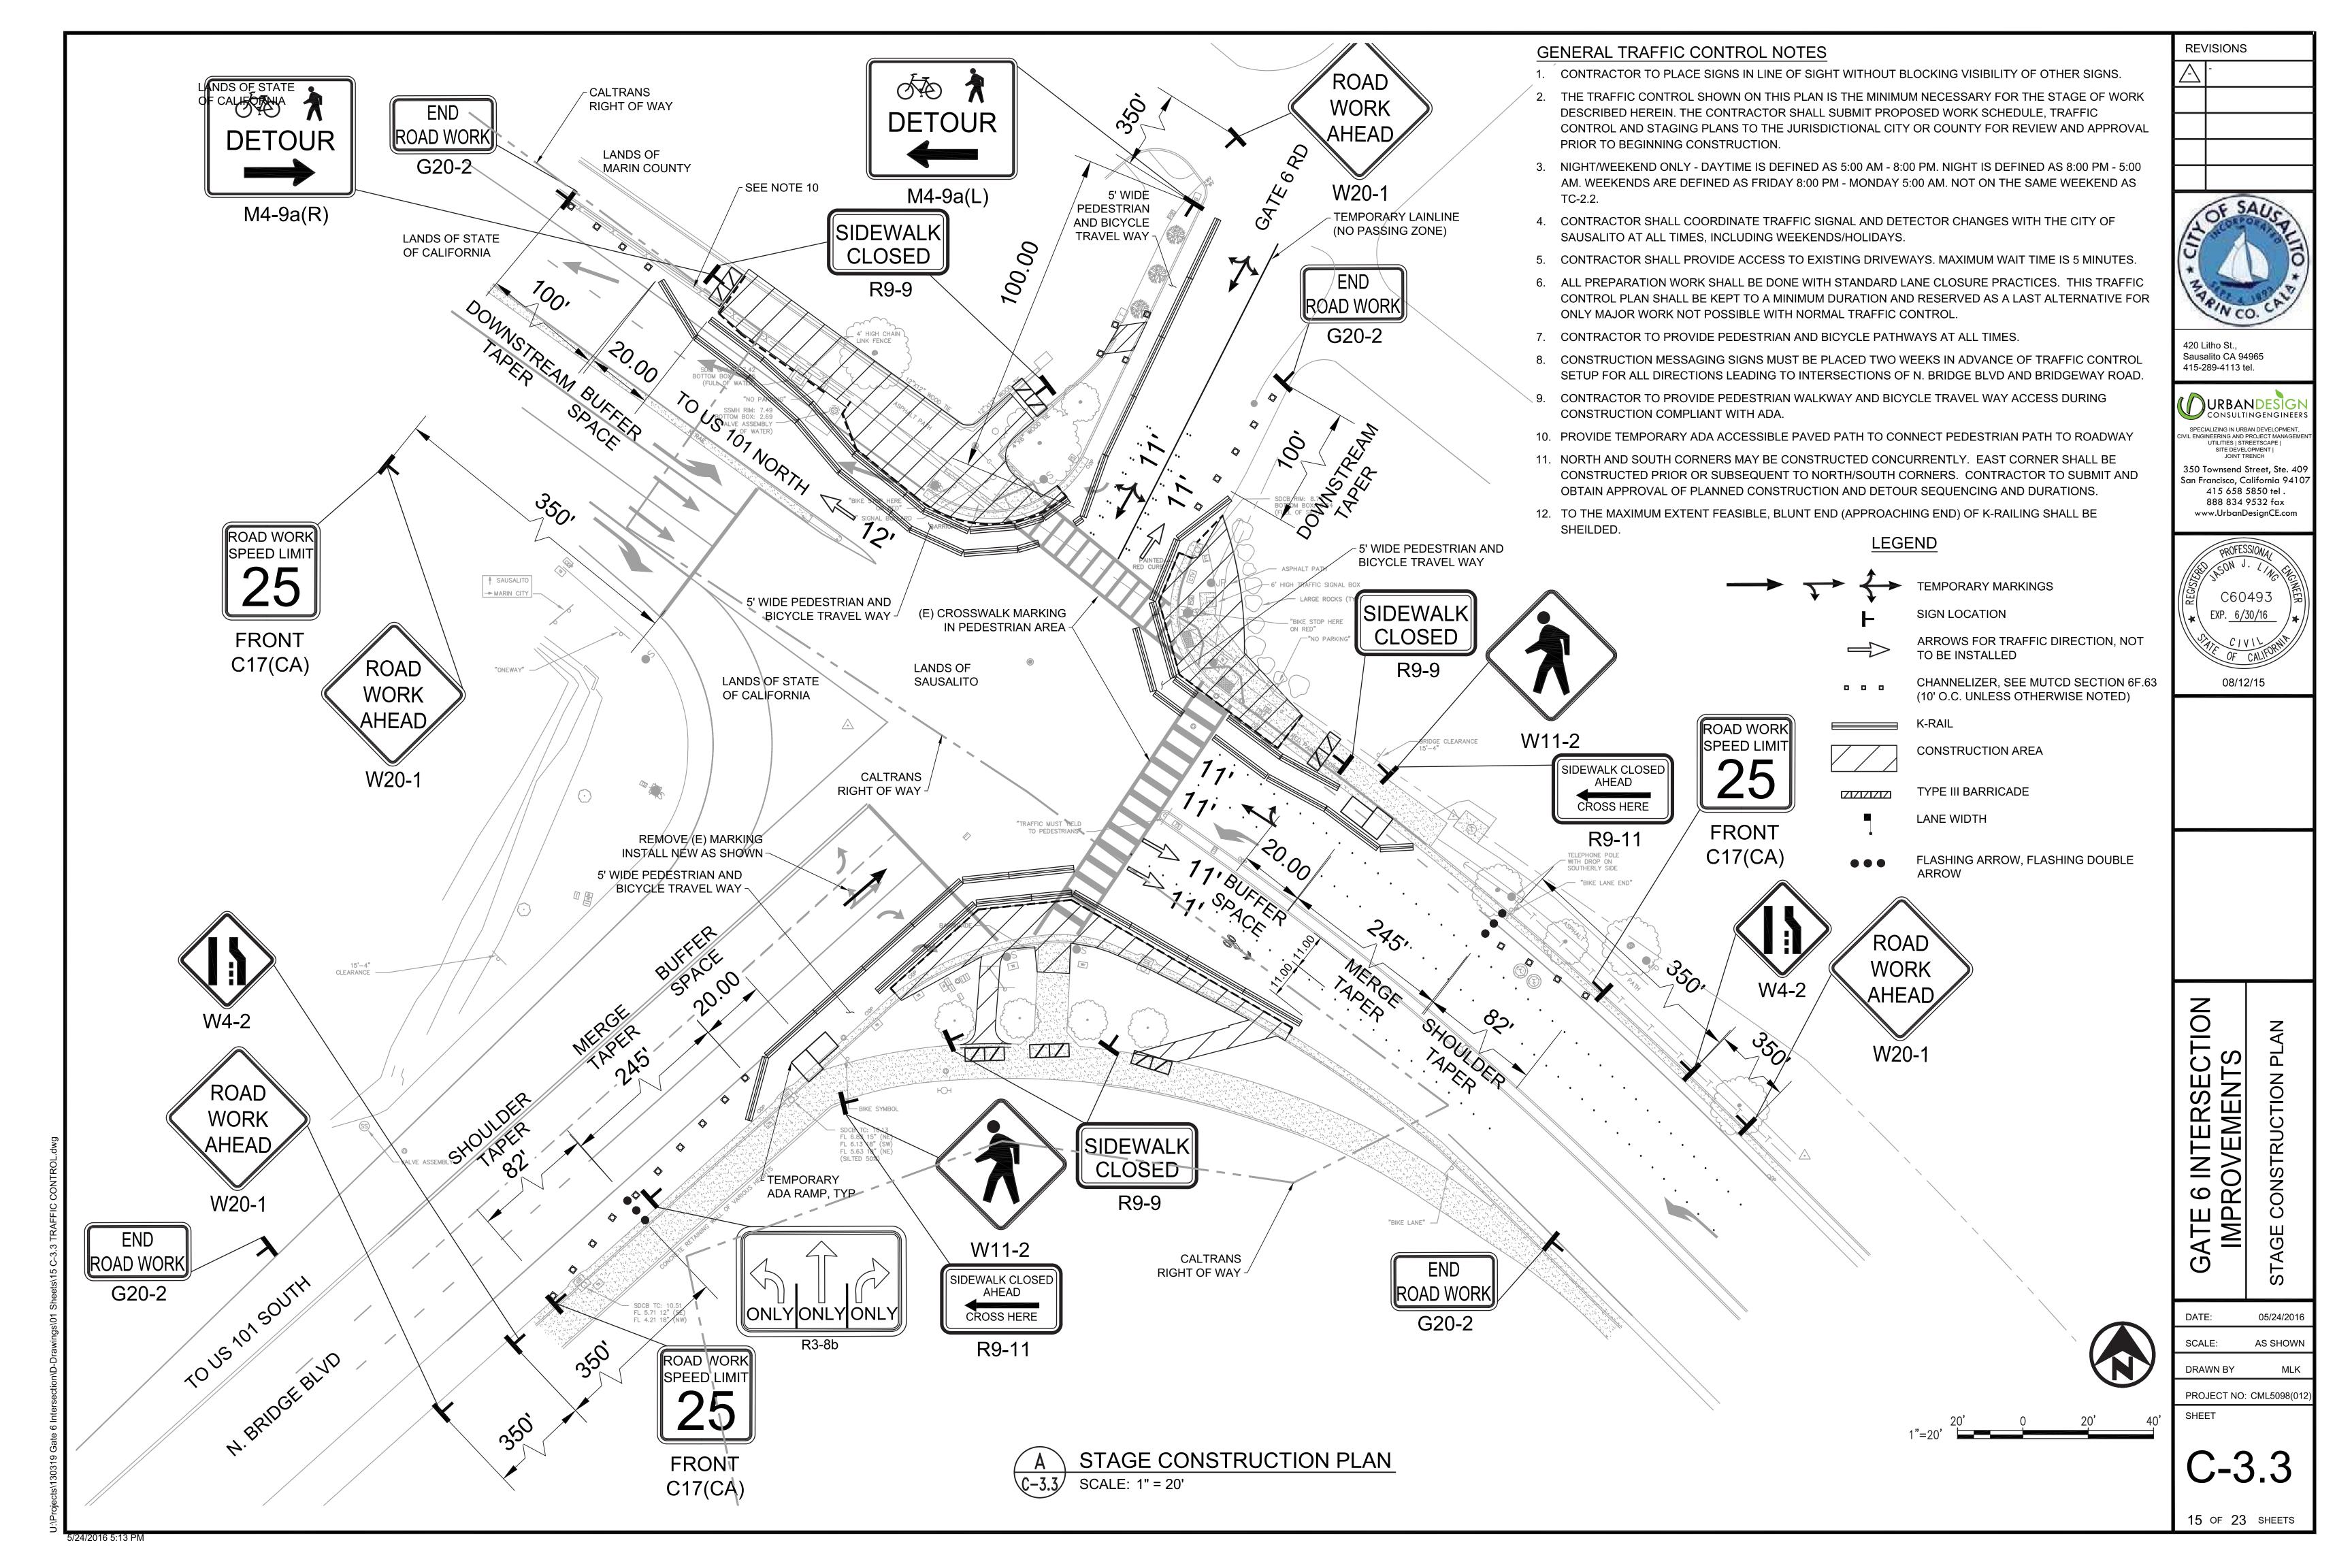
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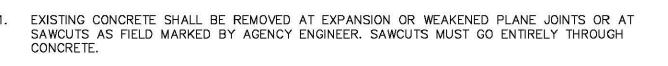
6-2.5










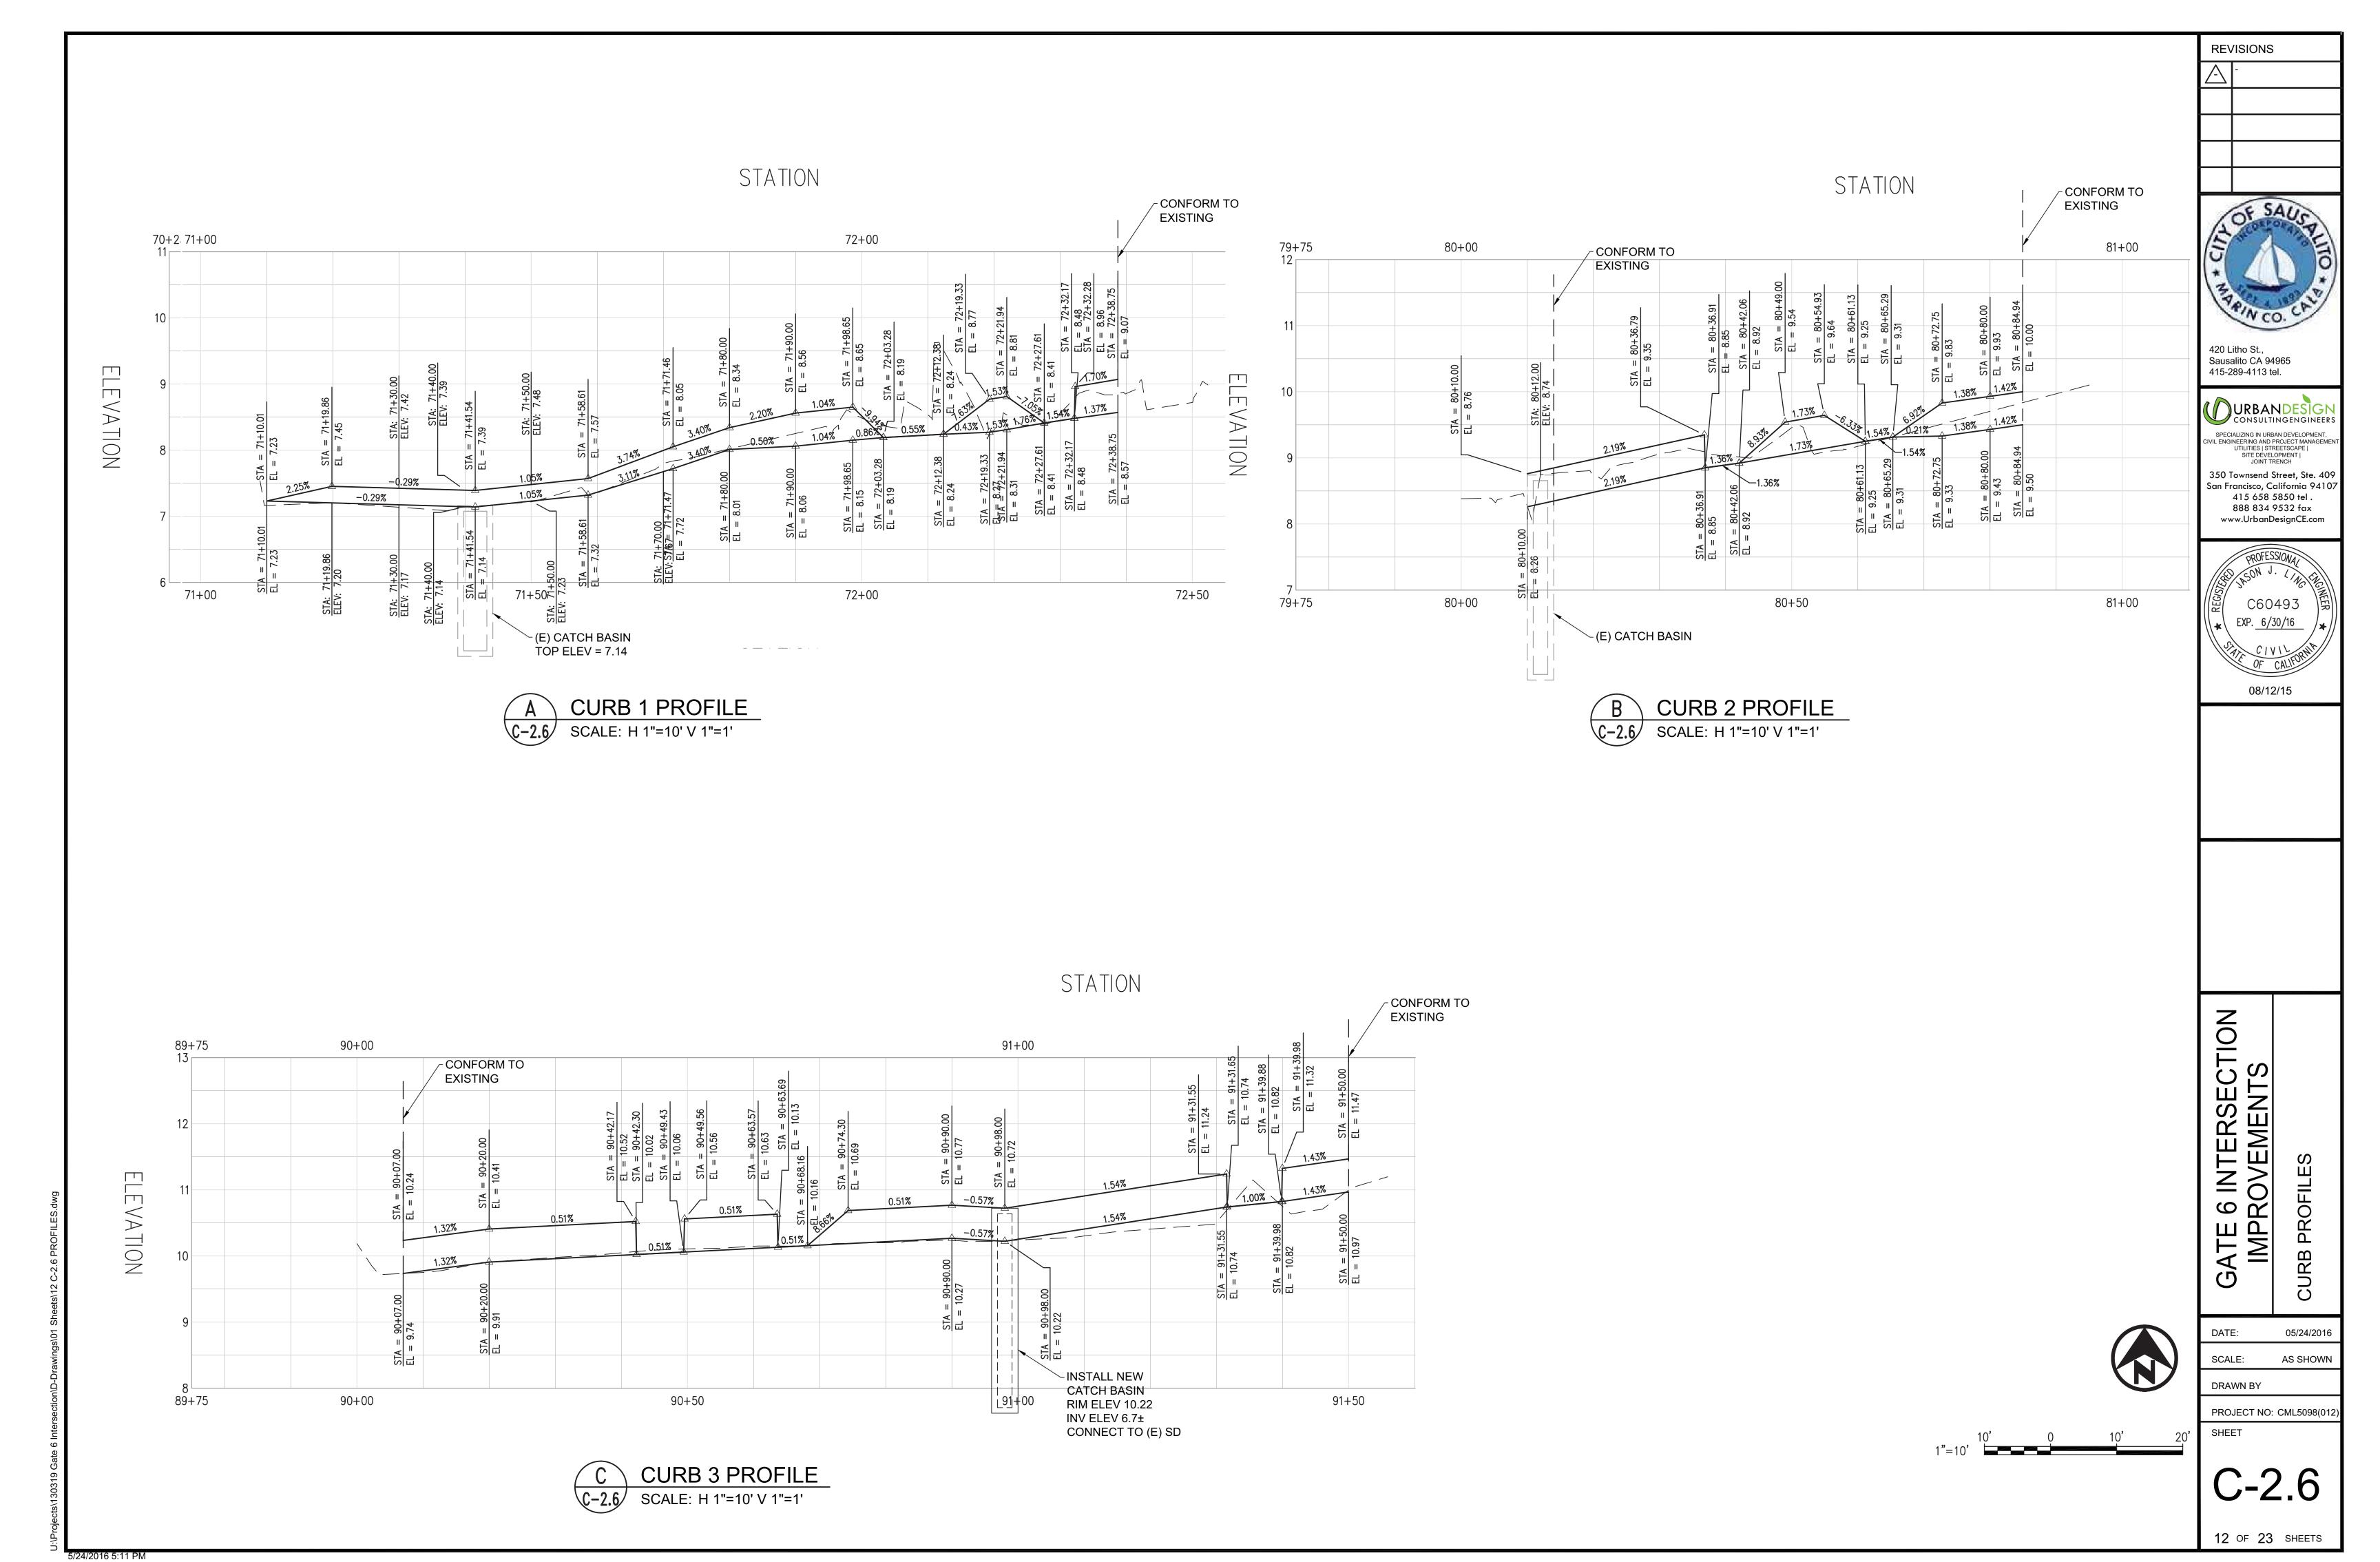

- FOR NEW DEVELOPMENT, NO UTILITY BOXES OR POLES WILL BE PERMITTED IN THE SIDEWALK AREA
- WHERE UNDERCUT SUBGRADE OR UNSUITABLE SUBGRADE MATERIAL IS ENCOUNTERED, THE AGENCY ENGINEER MAY REQUIRE REMEDIAL WORK TO BE DONE, INCLUDING OVER EXCAVATION AND BACKFILLING WITH CRUSHED ROCK AND, WHEN DIRECTED BY THE ENGINEER, PLACING GEOTEXTILE FABRIC BENEATH THE NEW CONCRETE SECTION.
- SUBGRADE SHALL BE COMPACTED TO AT LEAST 95% RELATIVE COMPACTION IN THE TOP SIX
- NEW WORK SHALL MATCH EXISTING AS CLOSELY AS POSSIBLE IN FINISH, SCORING AND COLOR. FOR NEW INSTALLATIONS PLACED ADJACENT TO EXISTING, 2LB. DAVIS BLACK #8084 (OR EQUIVALENT) PER CU. YD. CONCRETE SHALL BE ADDED TO MIX.
- 6. EXCEPT WHERE SPECIFIED OTHERWISE HEREIN, NO ADMIXTURES SHALL BE USED WITHOUT THE PERMISSION OF THE AGENCY ENGINEER.
- 7. FORMS SHALL MEET GRADE AND FORM FACES SHALL NOT VARY FROM THE DIMENSIONS SHOWN BY MORE THAN 1/2 INCH.
- 8. NO CONCRETE SHALL BE PLACED UNTIL THE AGENCY ENGINEER HAS INSPECTED AND APPROVED FORMS AND SUBGRADE/BASE.
- 9. SUBGRADE/BASE SHALL BE THOROUGHLY WETTED IMMEDIATELY PRIOR TO PLACING CONCRETE.
- 10. CONCRETE SHALL BE A MINIMUM CLASS B (5 SACK MIX) WITH 1 INCH MAXIMUM AGGREGATE FROM AN APPROVED MIXING PLANT. NO BAGGED MIX IS PERMITTED.
- 11. CONCRETE SHALL HAVE A SLUMP OF NOT MORE THAN FOUR INCHES.
- 12. FOR SIDEWALKS AND DRIVEWAY APPROACHES, 1/4 INCH DEEP SCORE LINES SHALL BE PLACED AT FOUR FEET ON CENTER OR AS DIRECTED BY THE AGENCY ENGINEER.
- WEAKENED PLANE JOINTS AT LEAST 3/4" DEEP SHALL BE PLACED AT A MINIMUM 16 FEET ON CENTER EXCEPT FOR SIDEWALKS AND DRIVEWAY APPROACHES WHICH SHALL BE A MINIMUM 5 FEET
- 14. 3/8 INCH THICK EXPANSION JOINTS SHALL BE PLACED ON BOTH SIDES OF DRIVEWAY APPROACHES, AT CURB AND SIDEWALK RETURN POINTS, DRAINAGE STRUCTURES AND OTHER LOCATIONS AS SHOWN ON THE PLANS.
- 15. ALL EXPOSED EDGES SHALL BE ROUNDED WITH 1/2 INCH RADIUS TOOL.
- 16. ALL FLAT SURFACES SHALL BE LIGHT BROOM FINISHED UNLESS OTHERWISE SPECIFIED BY AGENCY ENGINEER.
- 17. CURBS, SIDEWALKS AND DRIVEWAY APPROACHES SHALL HAVE FORMS REMOVED AND BE BACKFILLED WITHIN SEVEN DAYS AFTER POURING.
- 18. THE DESIGNATED DIMENSIONS AND SLOPES MAYBE MODIFIED TO ACCOMMODATE EXISTING ADJACENT FACILITIES SUBJECT TO THE APPROVAL OF THE AGENCY ENGINEER.

						County
UNIFORM STANDARDS ALL CITIES AND COUNTY OF MARIN	REQUIREMENTS FOR CONCRETE CURB, GUTTER, SIDEWALK, DRIVEWAY AND OTHER				MAY 2008 DWG. NO.	M:\Standards\
	"FLATWORK"	REV.	DATE	BY		

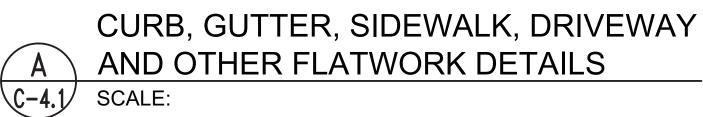



CURB, GUTTER

AND SIDEWALK

DETAILS

BATTER FLAT OR AS -

DIRECTED

(PAVEMENT)-

18"

F.C. (TYP.)

VARIES WIDTH AS PER PLAN

1. SEE DRAWING NO. 100 FOR

GENERAL REQUIREMENTS.

2. * 8" CURB HEIGHT UNLESS 6" HEIGHT APPROVED BY AGENCY

REV. DATE

SLOPE 2% MAX (1:50)

-1/2"ø x 12" STEEL DOWELS AT 4' O.C.

2008

DWG. NO.

BY

* 3% MAX. AT CURB RAMPS

FLAT OR AS DIRECTED

_____ 30" ____

—(PAVEMENT)

WIDTH AS PER PLAN

SLOPE 2% MAX (1:50)

A CONTRACTOR OF THE PARTY OF TH

- EXPANSION JOINT

TYPE "A" SIDEWALK


UNIFORM STANDARDS

ALL CITIES AND

COUNTY OF MARIN

POUR CURB & GUTTER

SEPARATELY FROM SIDEWALK

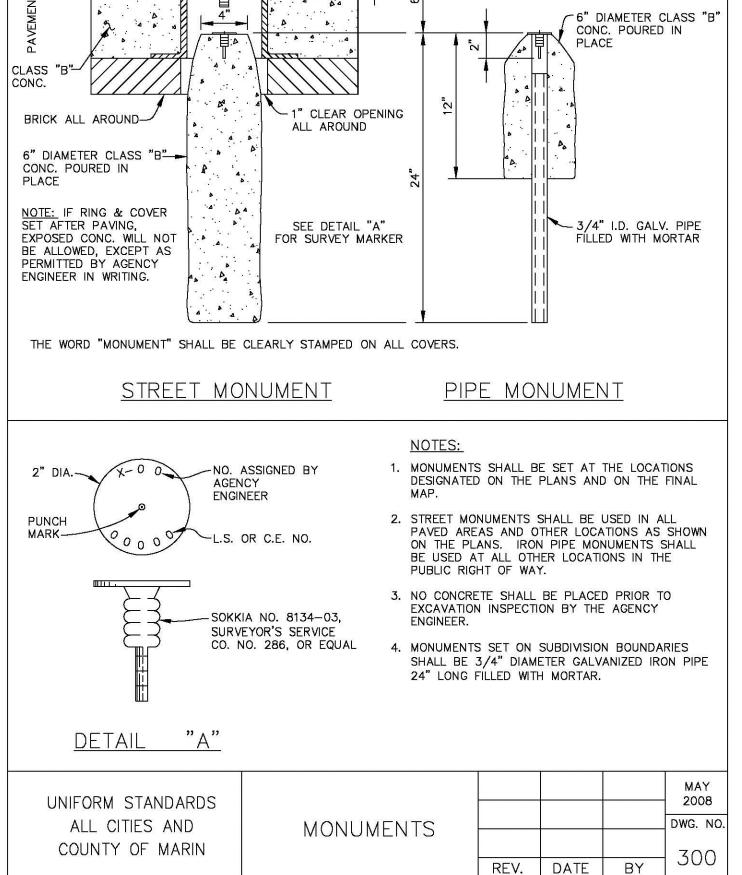


- EXISTING GROUND

BY


C.I. MONUMENT RING AND COVER, PHOENIX P-2001-E, OR ARTMARK APC-51, OR BROOKS 10-1/4" TRAFFIC BOX, OR AMERICAN BRASS AND IRON FOUNDRY

MONUMENT COVER OR FORNI CORPORATION "IRONSIDE" TYPE "A" BOX & LID OR




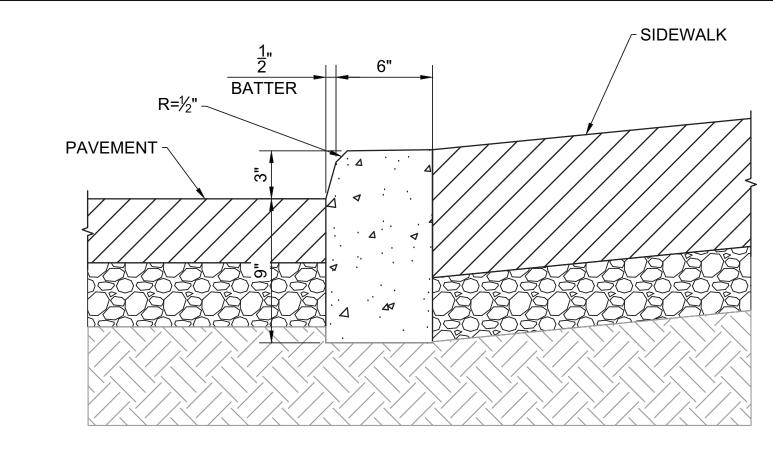





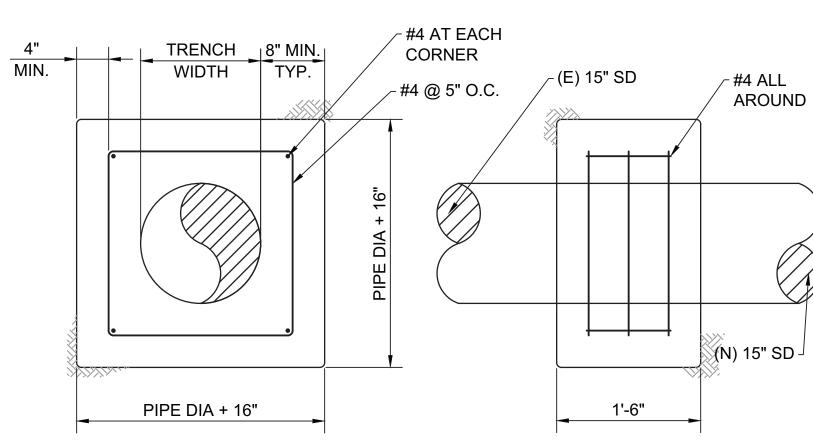



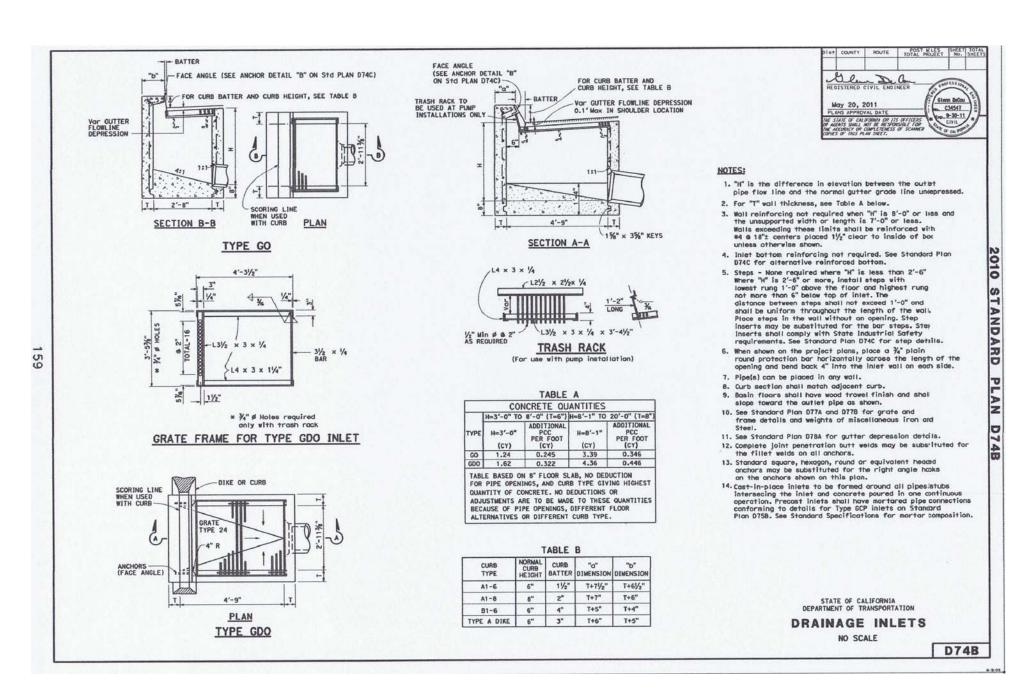

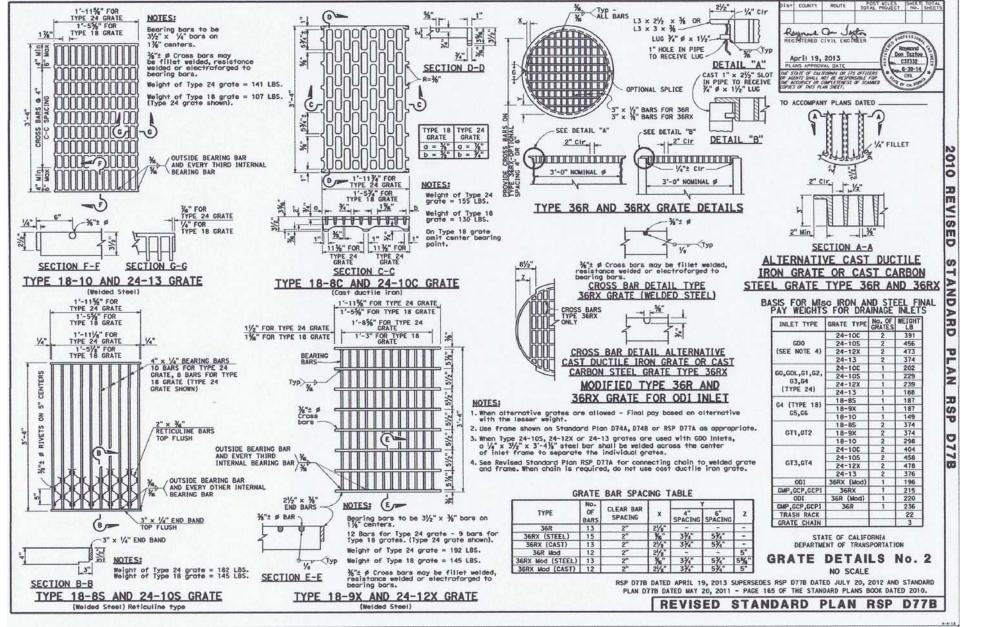

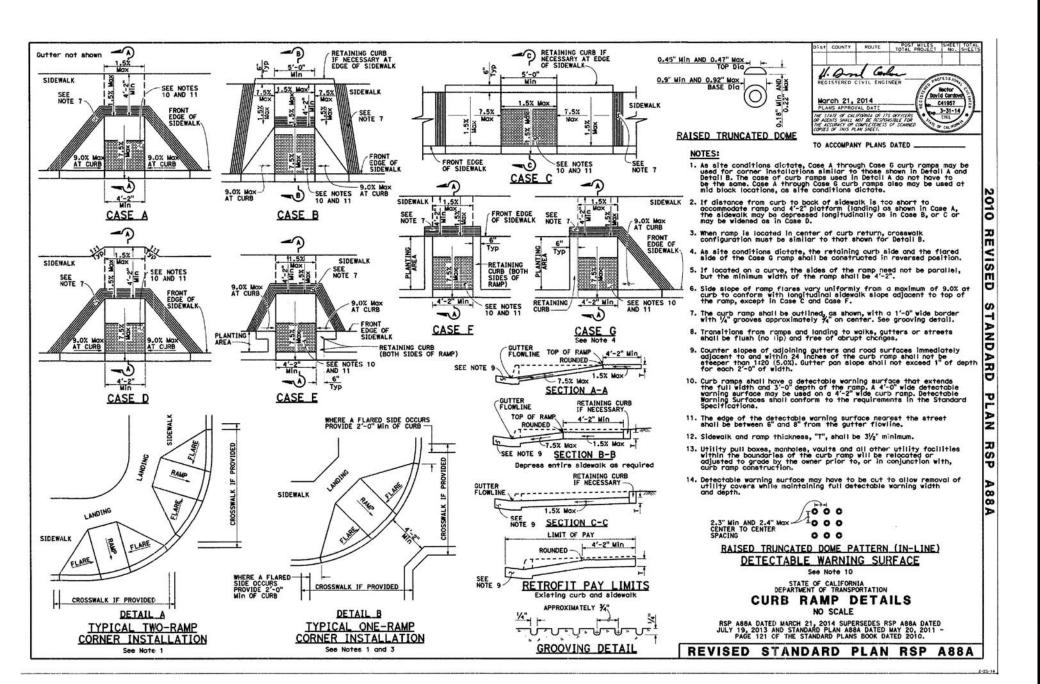







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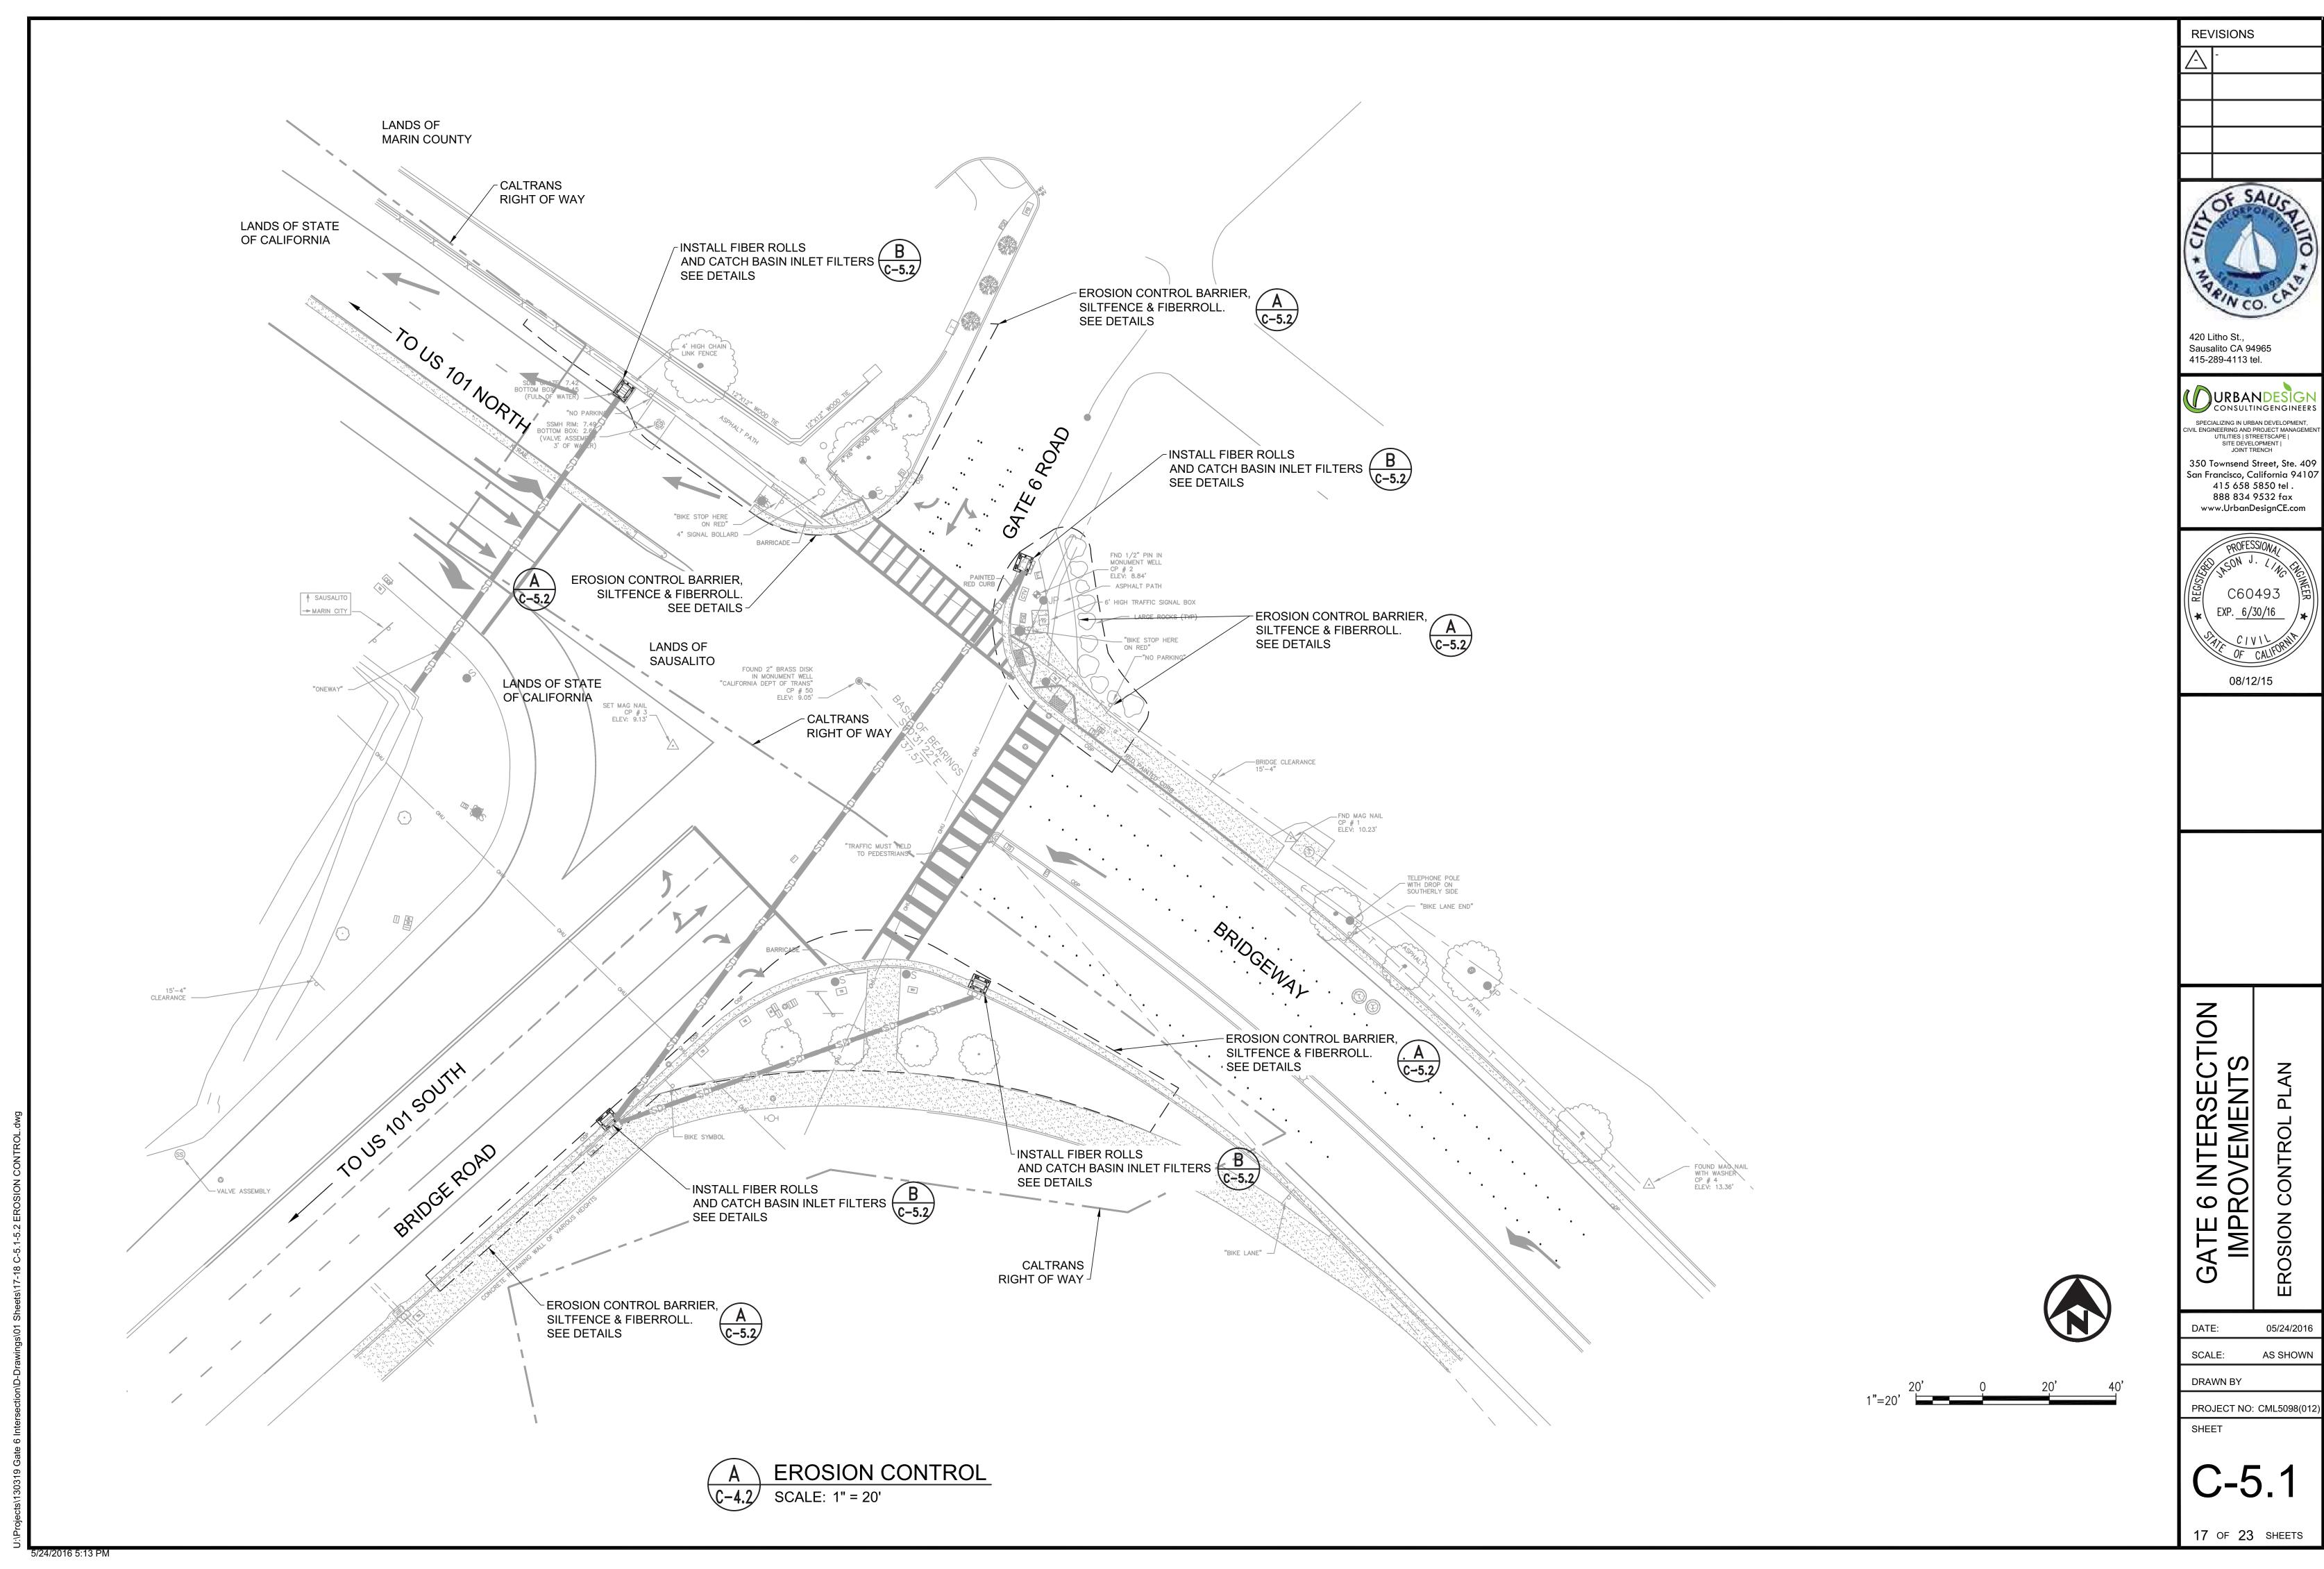
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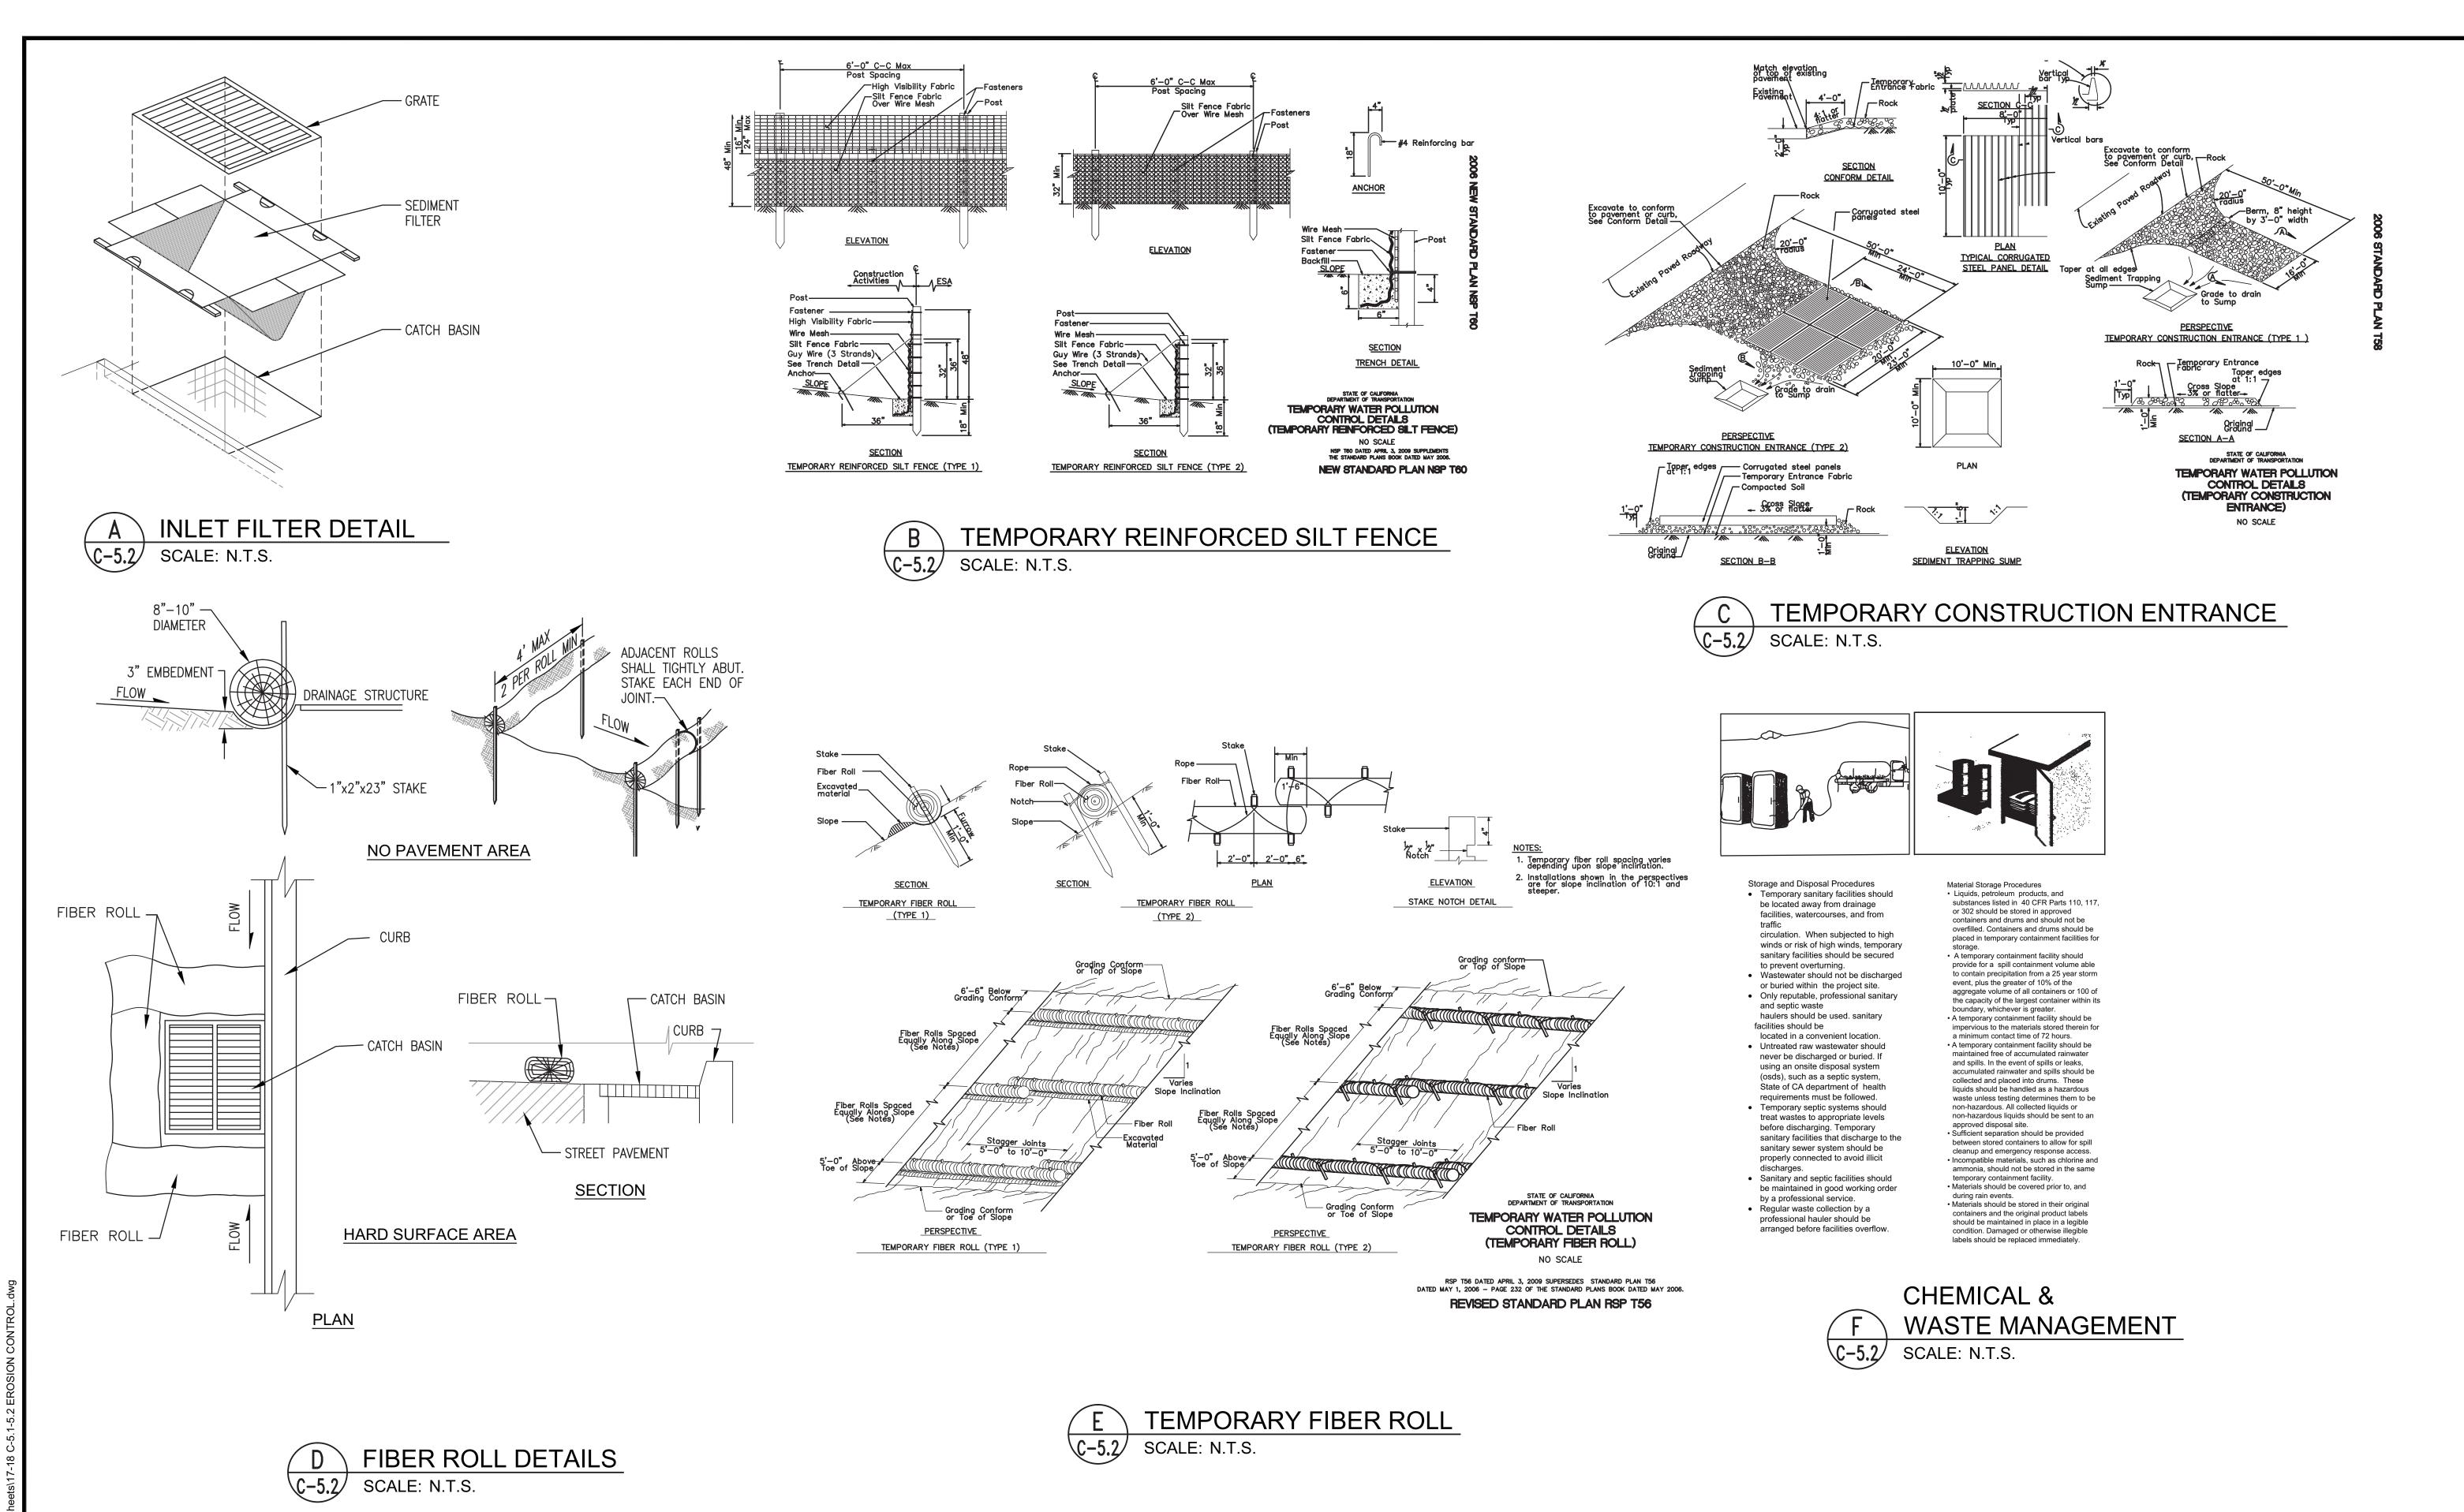
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DATE:

IMP CIVIL 05/24/2016 SCALE: AS SHOWN DRAWN BY

PROJECT NO: CML5098(01





DATE: 05/24/2016

SCALE: AS SHOWN

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EROSION

E 6 INTERSECTION PROVEMENTS

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C60493

EXP. 6/30/16

08/12/15

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DRAWN BY

PROJECT NO: CML5098(01)

C-5.2

ELECTRICAL INDEX

E-1 ELECTRICAL INDEX, NOTES, AND ABBREVIATIONS
E-2 TO E-4 SIGNAL AND LIGHTING
E-5 ELECTRICAL DETAILS

GENERAL NOTES

- 1. NO ABOVE GROUND ELECTRICAL WORK SHALL BE PERFORMED ON ANY SYSTEM WITHIN THE PROJECT SITE UNTIL ALL CONTRACTOR—FURNISHED ELECTRICAL MATERIALS FOR THAT INDIVIDUAL SYSTEM HAVE BEEN TESTED AND DELIVERED TO CONTRACTOR.
- 2. THE NEUTRAL CONDUCTOR SHALL RUN FROM THE SERVICE EQUIPMENT ENCLOSURE TO THE CONTROLLER CABINET WITHOUT SPLICING TO ANY OTHER NEUTRAL CONDUCTOR.
- 3. THE CLEARANCE BETWEEN THE BOTTOM OF THE LOWEST CIRCUIT BREAKER AND THE BOTTOM OF THE SERVICE EQUIPMENT ENCLOSURE FOR A TYPE III—A SERIES SHALL BE 24 INCHES MINIMUM
- 4. WHERE ONE OR MORE TRAFFIC SIGNAL DETECTOR(S) CONSIST OF A SEQUENCE OF 4 LOOPS IN A SINGLE LANE, THE FRONT LOOP CLOSEST TO THE LIMIT LINE OR CROSSWALK SHALL BE LOCATED 1 FOOT FROM THE LINE. THE SET OF 3 LOOPS OR 4 LOOPS ASSIGNED TO THE SAME LOOP DETECTOR LEAD—IN CABLE (DLC) SHALL BE CONNECTED IN SERIES FOR TRAFFIC SIGNAL SYSTEM ONLY AND NOT FOR RAMP METERING SYSTEM.
- 5. COLOR CODING OF TRAFFIC SIGNAL CONDUCTOR FOR OVERLAP PHASES, SEE DETAIL B ON SHEET E-4, "CONDUCTOR, POLE AND EQUIPMENT SCHEDULES".
- 6. AT LEAST THREE WORKING DAYS PRIOR TO PERFORMING ANY WORK ON EACH EXISTING SYSTEM, THE CONTRACTOR SHALL NOTIFY THE DEPARTMENT OF TRANSPORTATION, ELECTRICAL AND SIGNAL MAINTENANCE SUPERINTENDENT, PHONE (415) 330-6500.
- 7. COUPLING NUTS MUST BE USED ON TYPE 1-B STANDARD.
- 8. TRAFFIC SIGNAL MUST BE IN OPERATION DURING CONSTRUCTION, EXCEPT OTHERWISE NOTED ON THE PLANS OR SPECIAL PROVISIONS.
- 9. THE CITY REPRESENTATIVE SHALL BE PRESENT DURING THE MARKING OF LOCATION OF POLES, CABINETS, DETECTOR LOOPS AND ETC.
- 10. R3-1 ACTIVATED BLANK OUT SIGN SHALL BE MANUFACTURED BY MCCAIN, SIGN TECHNOLOGIES, TAPCO TRAFFIC AND PARKING CONTROL COMPANY OR APPROVED EQUAL.

ABBREVIATIONS

ADA AMERICANS WITH DISABILITIES ACT

AT&T AMERICAN TELEPHONE AND TELEGRAPH

CCU CAMERA CONTROL UNIT

PG&E PACIFIC GAS AND ELECTRIC

TOU TIME-OF-USE METER


PROJECT NOTES

- 1 FURNISH AND INSTALL TYPE III-AF SERVICE EQUIPMENT ENCLOSURE.
- RS MODEL 170E CONTROLLER UNIT. INSTALL STATE-FURNISHED MODEL 2070 CONTROLLER UNIT IN EXISTING MODEL 332 CABINET. INSTALL DEPARTMENT-FURNISHED LOAD SWITCH FOR Ø3 BIKE PHASE AND ONE LOOP DETECTOR SENSOR UNIT FOR Ø7.
- 3 INSTALL 3-SECTION BICYCLE SIGNAL HEAD. SEE DETAIL A ON E-3.
- 4 ADJUST EXISTING PULL BOX TO FINAL GRADE.
- 5 RC EXISTING PULL BOX. INSTALL A NEW PULL BOX IN EXISTING CONDUIT RUN.
- 6 EXISTING 2"C, 1 SIC.
- 7 2"C, INSTALL EXISTING 1 SIC.
- 8 2"C, 2#10 (120V, R3-1 ACTIVATED BLANKOUT SIGN).
- 9 RC EXISTING NON-ADA PBA. INSTALL NEW APS.
- FURNISH AND INSTALL R3-1 ACTIVATED BLANKOUT SIGN PER 2014 CA MUTCD REQUIREMENT. SEE GENERAL NOTE 10 ON THIS SHEET.
- 11 EXISTING 2"C, 2 DLC. REMOVE 2 DLC. ADD 2 DLC.
- 12 EXISTING 2"C, 4 DLC. REMOVE 4 DLC. ADD 4 DLC.
- 13 EXISTING 3"C, 7 DLC. REMOVE 7 DLC. ADD 8 DLC.
- 14 EXISTING 2"C, 3#2 (120/240V, SERVICE).
- 15 EXISTING 1"C, 1 DLC. REMOVE 1 DLC. ADD 1 DLC.
- 16 EXISTING 3"C, 6 DLC. REMOVE 6 DLC. ADD 6 DLC.
- 17 2"C, 3 DLC.
- PULL EXISTING SIC FROM THE EXISTING CONTROLLER CABINET TO THIS PULL BOX. REINSTALL AFTER THE INSTALLATION OF NEW CONDUITS.
- 19 2"C, 4 DLC.
- 20 2"C, 2#6 (120V, CONTROLLER), 2#8 (240V, LIGHTING), 3#14 (120V, PEU).
- 21 2°C, 3#2 (120/240V, SERVICE).
- 22 RC 3-SECTION VEHICLE SIGNAL HEAD (8"). INSTALL 3-SECTION VEHICLE SIGNAL HEAD (12").
- 23 2"C, 1 DLC.
- 24 EXISTING 2"C, INSTALL EXISTING 1 SIC.

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GATE 6 INTERSECTION IMPROVEMENTS

PROJECT NO:

DATE:

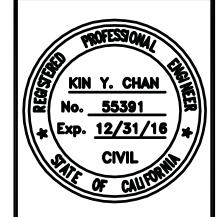
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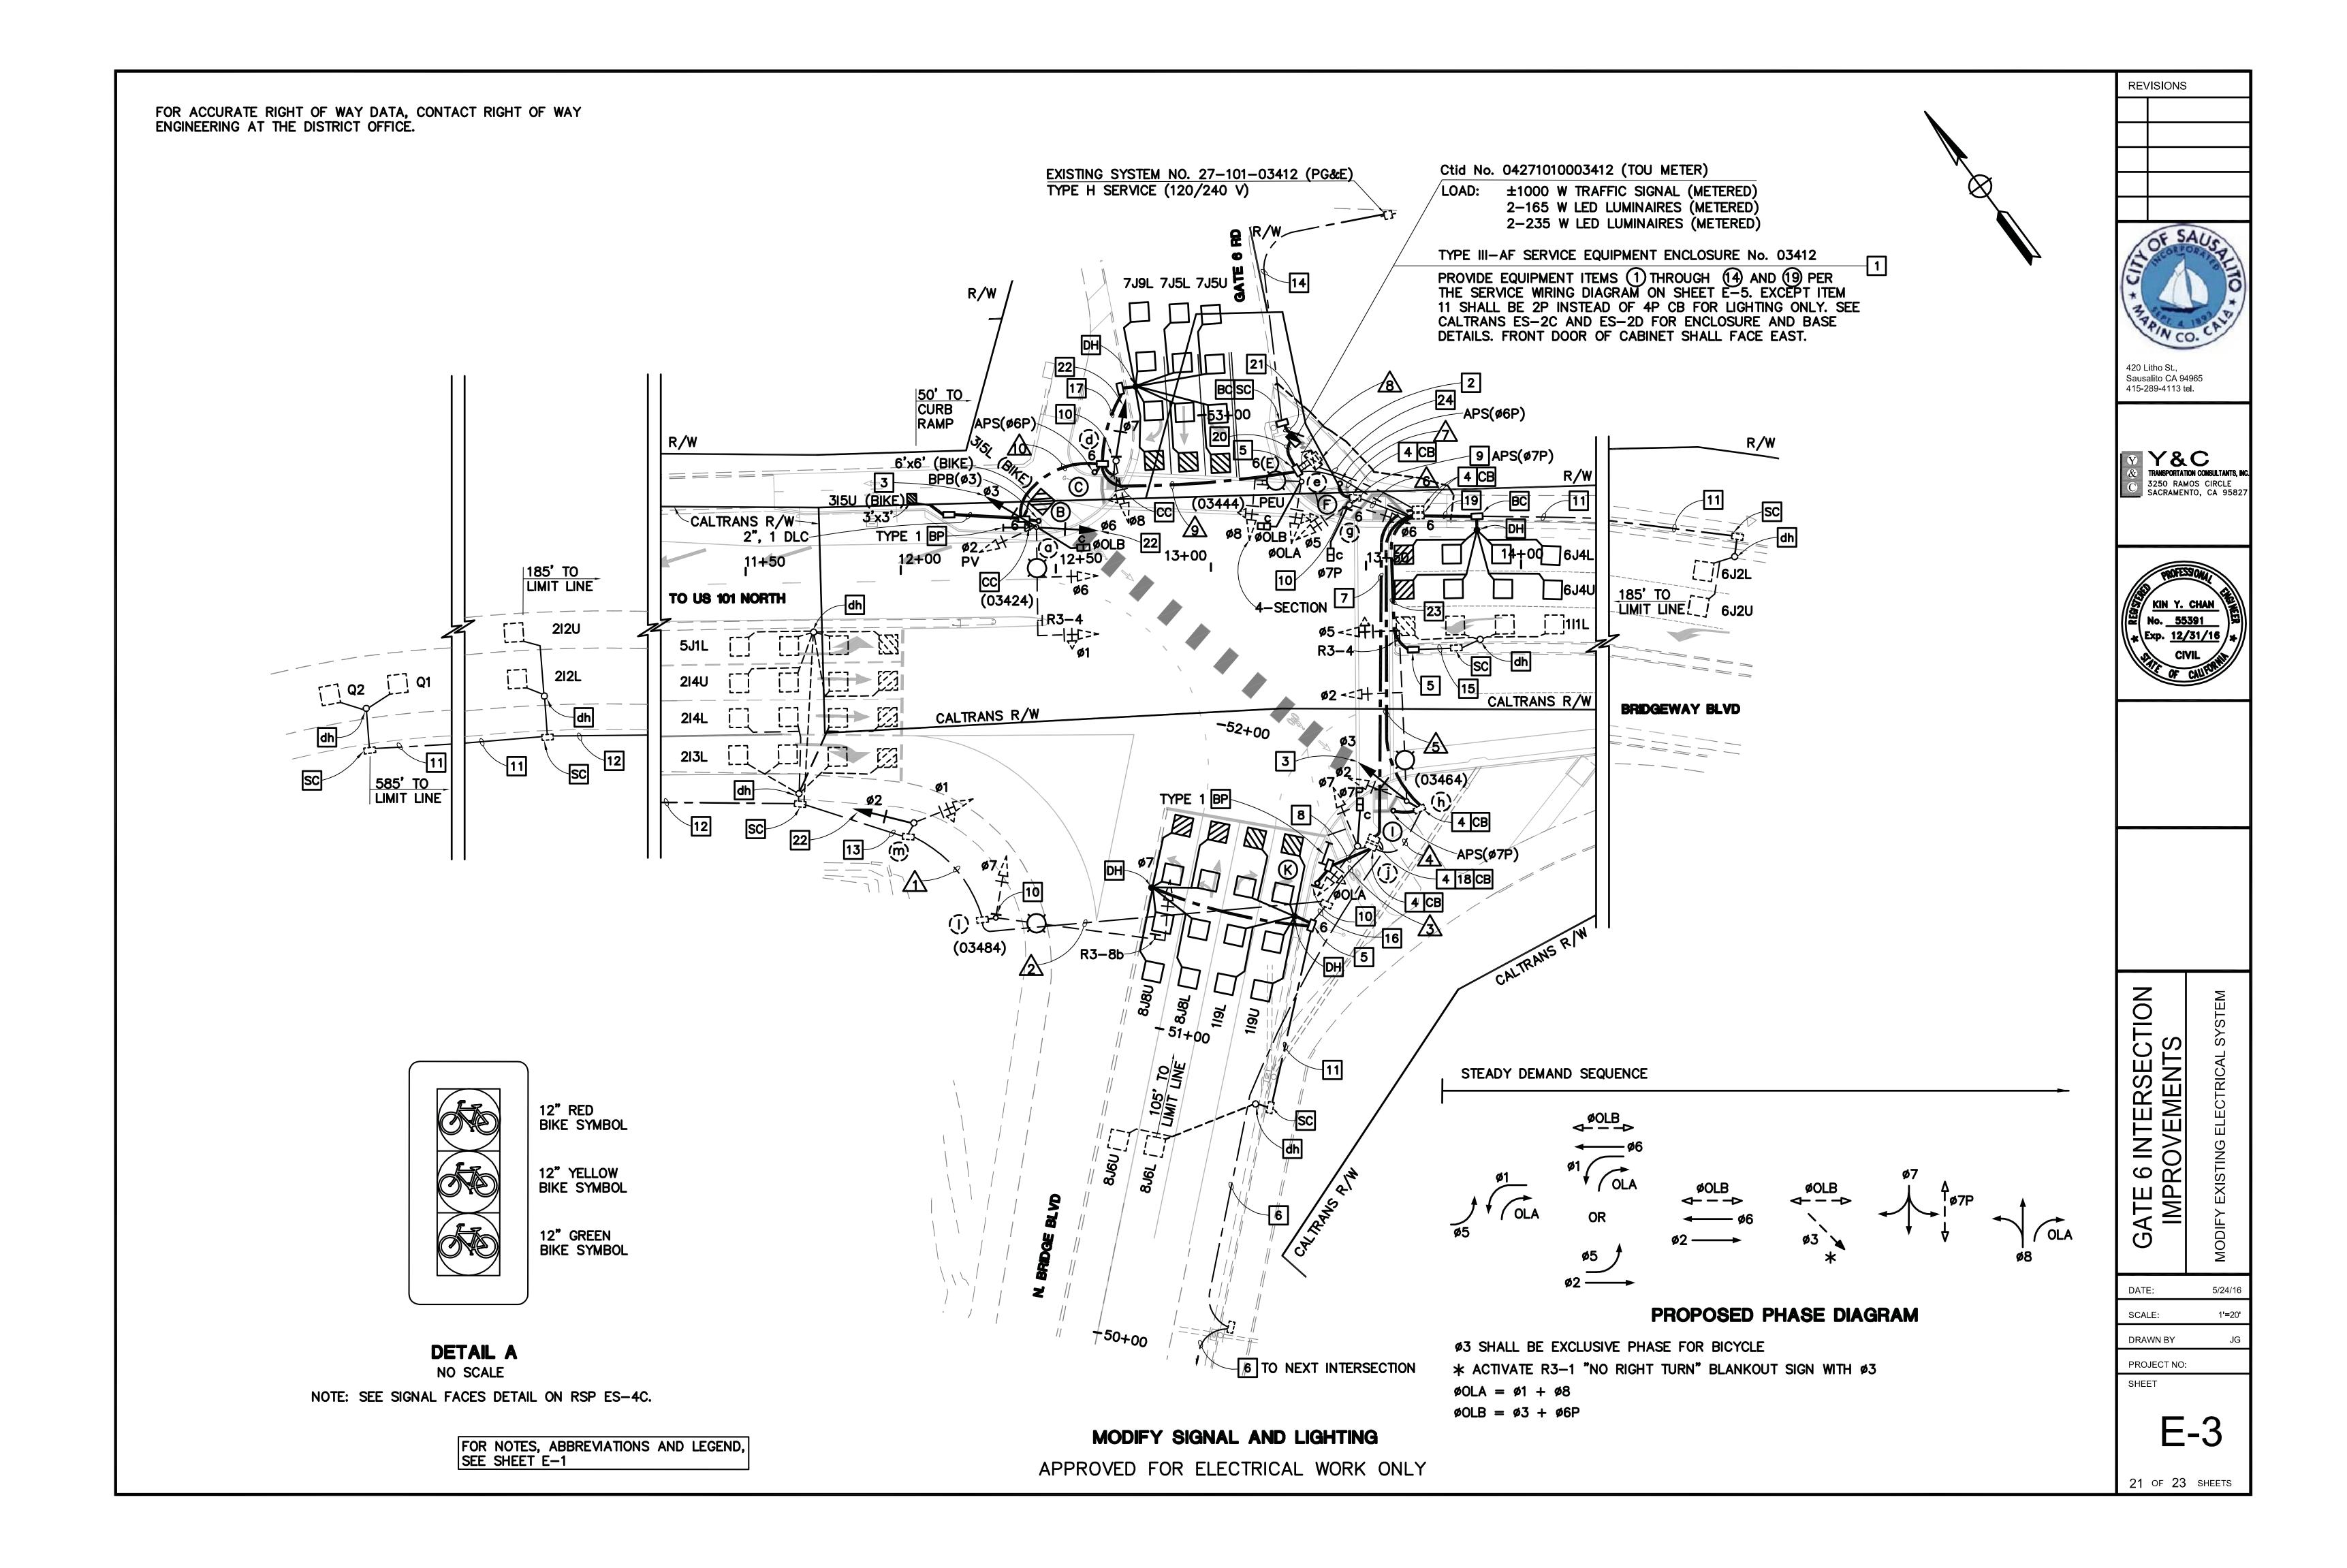
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E-1

NO SCALE

19 of 23 SHEETS



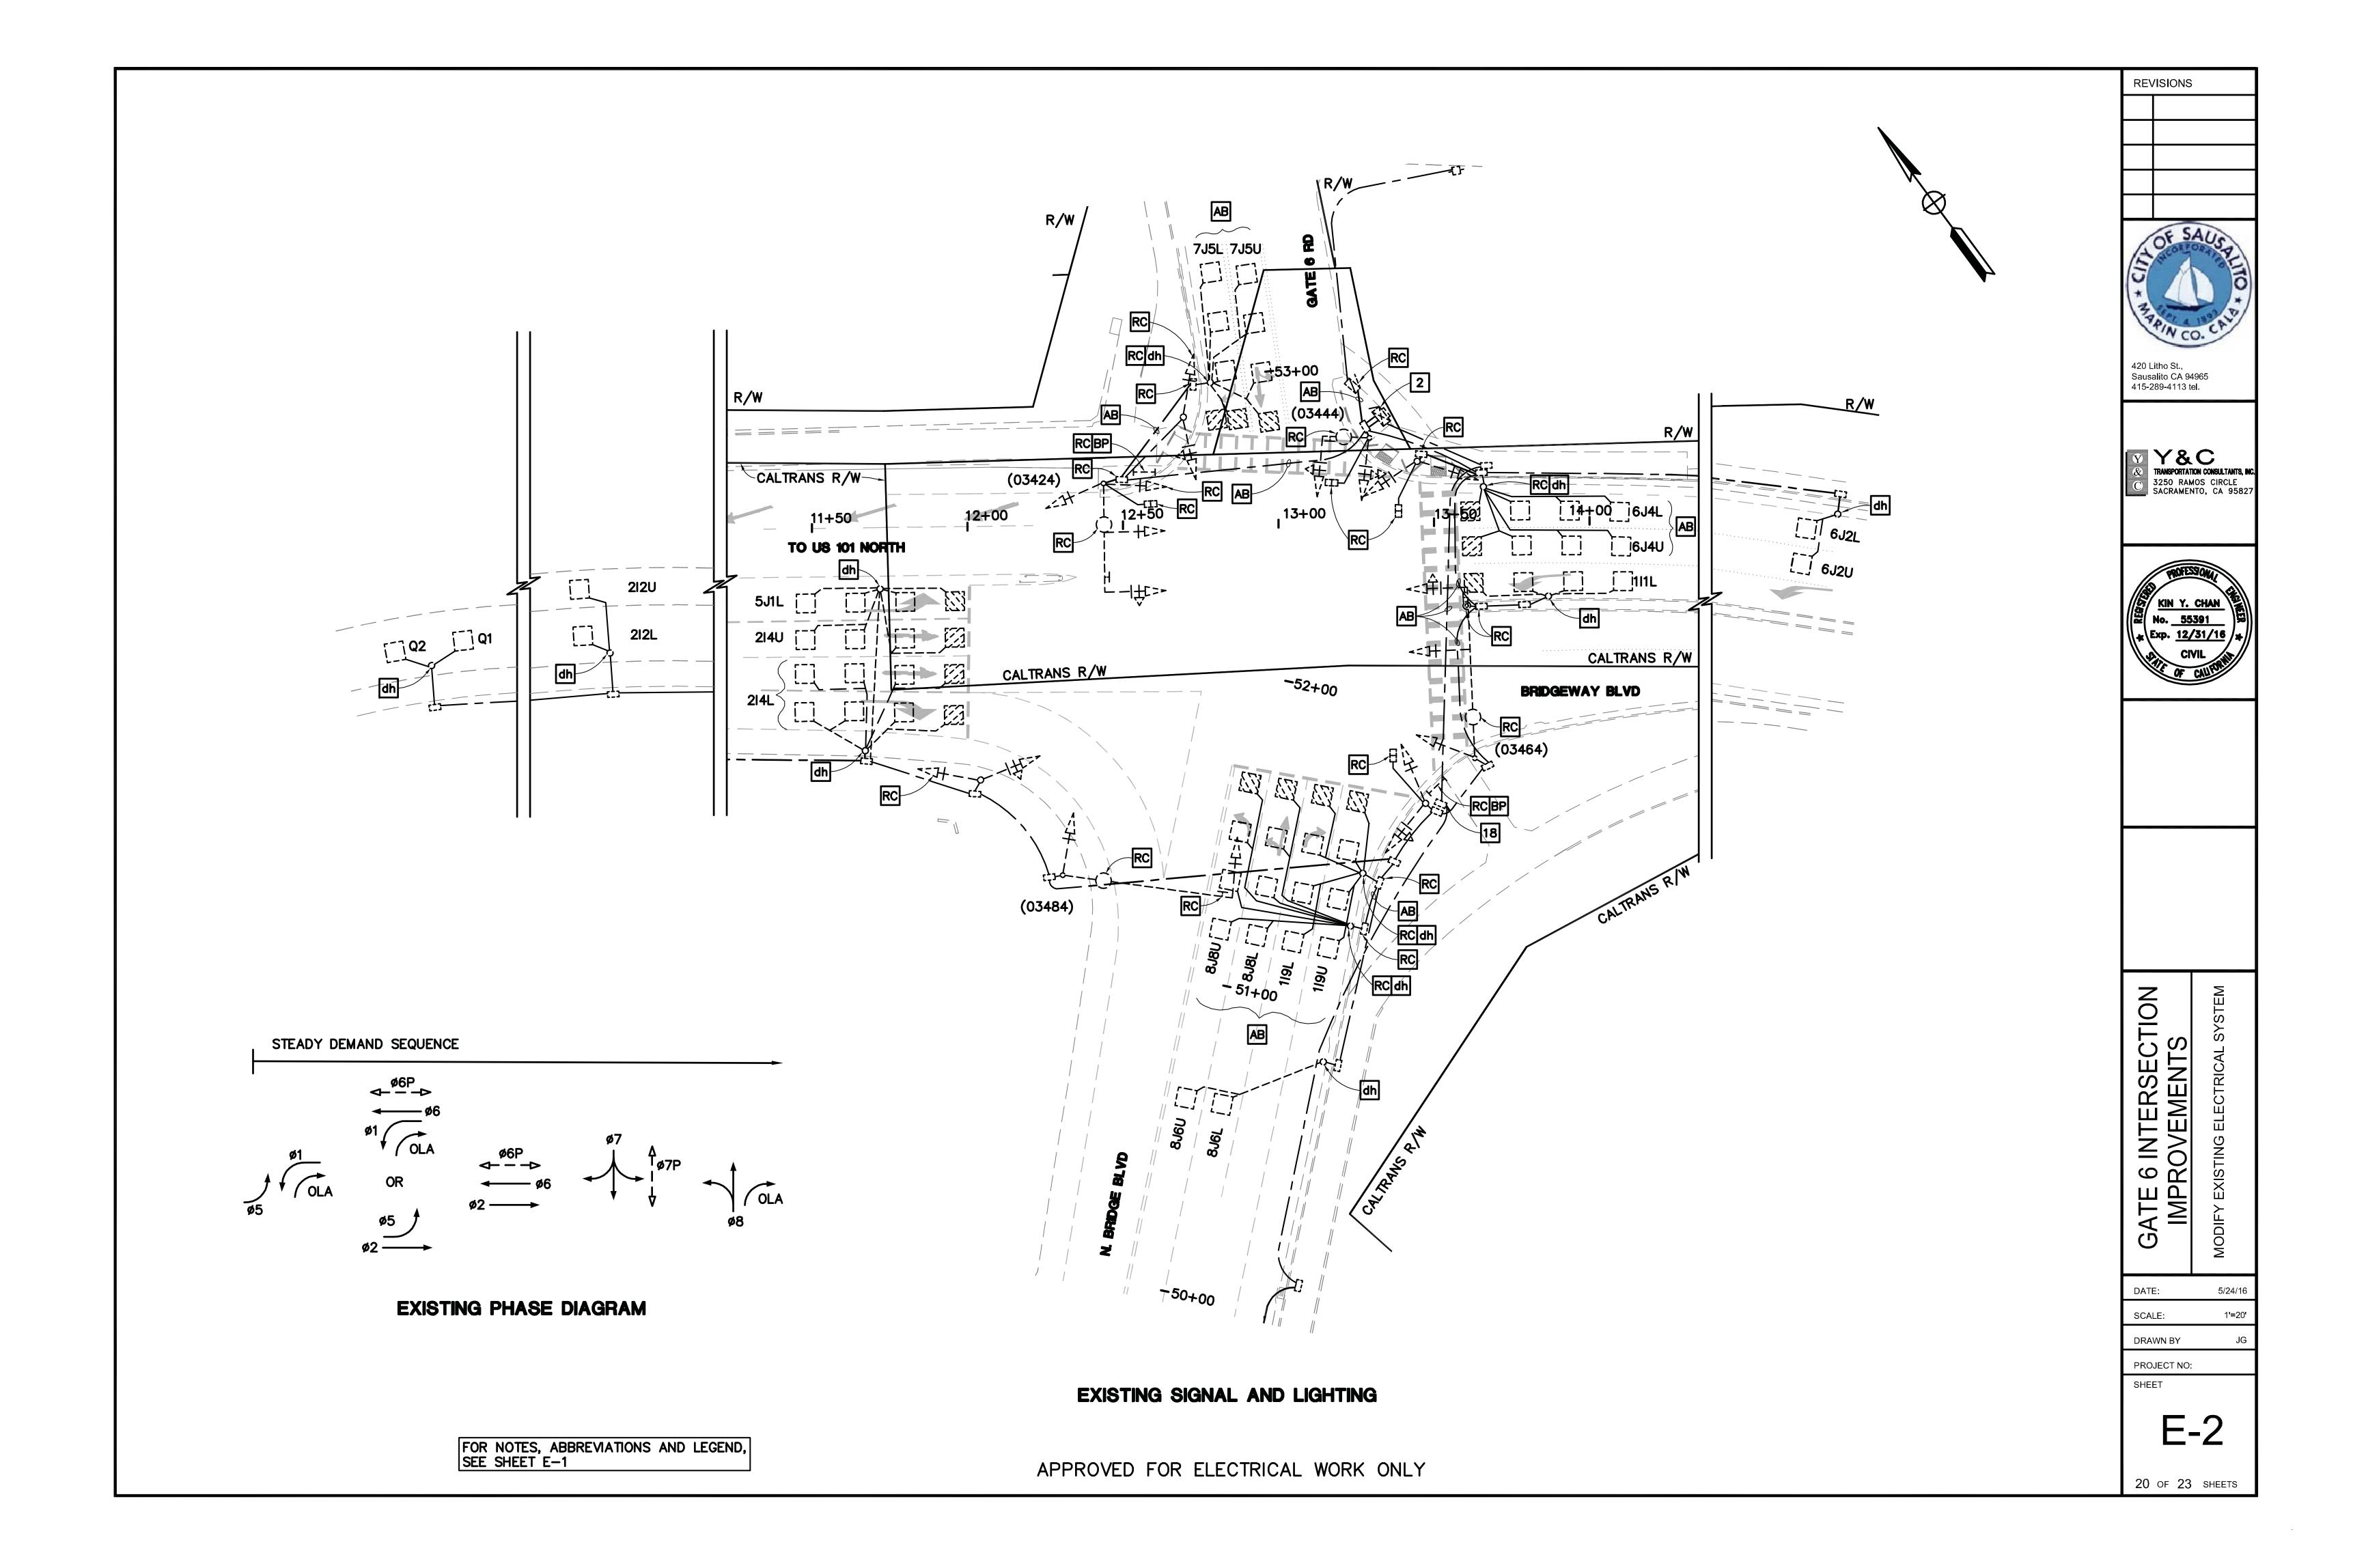

	CONDUIT RUN NUMBER									
CONDUCTOR SCHEDULE	Λ	<u></u>	3	4	<u>\$</u>	<u>6</u>	Λ	8	<u></u>	19
No. 14 CONDUCTORS										
ø1	3	3	3	3	3		3	6	3	3
ø2	3	3	3	3	3		3	6	3	3
ø3				3	3		3	6	3	3
ø5					3	3	6	6		Ť
ø6						3	3	6	3	3
ø7		3	3	3	3		3	6	3	H
		5	 	_)		 	6	3	
				5				5	-	
ØOLA				<u> </u>	5		5	4	2	2
ØOLB							<u> </u>	<u> </u>		
Ø7P				2	2		2	2		
APS (Ø6P)								4	2	
APS (Ø7P)	 				2	2	2	2	_	
BPB (ø3)								2	2	2
PEU	<u> </u>									
SPARE	3	3	3	3	3	3	3	6	3	3
TOTAL No. 14	9	12	12	22	27	11	33	67	27	19
N. 40 00NDUOTODO										
No. 10 CONDUCTORS			_							
ACTIVATED BLANKOUT SIGN		2	2	2	2	2	2	4	2	
No. 8 CONDUCTORS										
LIGHTING (240V)		2	2	2	2		2		2	2
SIGNAL NEUTRAL	1	1	1	1	1	1	1	2	1	1
TOTAL No. 8	1	3	3	3	3	1	3	2	3	3
TOTAL NO. 0	'	3		_	5	·	<u> </u>			-
No. 6 CONDUCTORS										
CONTROLLER (120V)								2		
APS CABLE				1						1
LOOP DETECTOR LEAD-IN CABLE (DLC)										
Q1/Q2	2	2	2	2	2		2	2		
111L							1	1		
119U/119L			2	2	2		2	2		
212U/212L	2	2	2	2	2		2	2		
213L/214U/214L	3	3	3	3	3		3	3		
315L (BIKE) /315U (BIKE)								2	2	2
5J1L	1	1	1	1	1		1	1		
6J2U/6J2L							2	2		
6J4U/6J4L							2	2		
7J5U/7J5L/7J9L								3	3	
8J6U/8J6L			2	2	2		2	2		
8J8U/8J8L			2	2	2		2	2		
		8	14	14	14		19	24	5	2
TOTAL LOOP DETECTOR LEAD-IN CABLE	8	0							_	
	8	0	• •	•••			,,,			
	8 E	E	E	E	N	E	E	N	N	N


[&]quot;-" REMOVE ALL EXISTING CONDUCTORS/CABLES. INSTALL NEW.

	POLE AND EQUIPMENT SCHEDULE												
Na	STAN	DARD		VEH	SIG MTG	PED *	Al	PS**		BPB (NEW)	*** LED LUMINAIRE	SDECIAL DEGLIDEMENTS	
No.	TYPE	SMA (FEET)	LMA (FEET)	MAST ARM	POLE	SIGNAL MTG	Ø	ARROW	ø	ARROW	LUMINAIRE	SPECIAL REQUIREMENTS	
(6)	EXISTING 24-3-70	35	15	MAS MAS	NEW SV-2-TA SV-1-T	SP-1-T					165W	SEE PROJECT NOTE 3 AND 22.	
B	PBA POST								3	←			
0	1-B (7')						6P						
(g)	EXISTING 1-B				NEW TV-3-T							SEE PROJECT NOTE 10 AND 22. SEE DETAIL C ON THIS SHEET.	
(e)	EXISTING 19-3-70	15	12	MAS-4B	SV-1-T	SP-1-T					235W		
(F)	1-B (7')						6P	—					
(g)	EXISTING 1-B				NEW TV-3-T	SP-1-T	7P	\				SEE PROJECT NOTE 9 AND 10. SEE DETAIL B ON THIS SHEET.	
(£)	EXISTING 29-5-70	55	15	MAS MAS	NEW SV-2-TB						165W	SEE PROJECT NOTE 3.	
0	1-B (7')						7P	+					
(j)	EXISTING 1-B				TV-2-T	SP-1-T							
K	1-B				TV-1-T							SEE PROJECT NOTE 10. SEE DETAIL E.	
(i)	EXISTING 29-5-70	55	15	MAS	NEW SV-2-TA						235W	RC EXISTING R61-7 SIGN. IS R3-8b SIGN. SEE PROJECT NOTE 10. SEE DETAIL D ON THIS SHEET.	
(j)	EXISTING 1-B				NEW TV-2-T							SEE PROJECT NOTE 22.	

- * RC EXISTING PEDESTRIAN SIGNAL HEAD. INSTALL NEW LED COUNT-DOWN PEDESTRIAN SIGNAL HEAD.
- ** RC EXISTING PBA. INSTALL NEW APS.
- *** RC EXISTING HPS LUMINAIRE. INSTALL NEW LED LUMINAIRE.

DETAIL C

NO SCALE

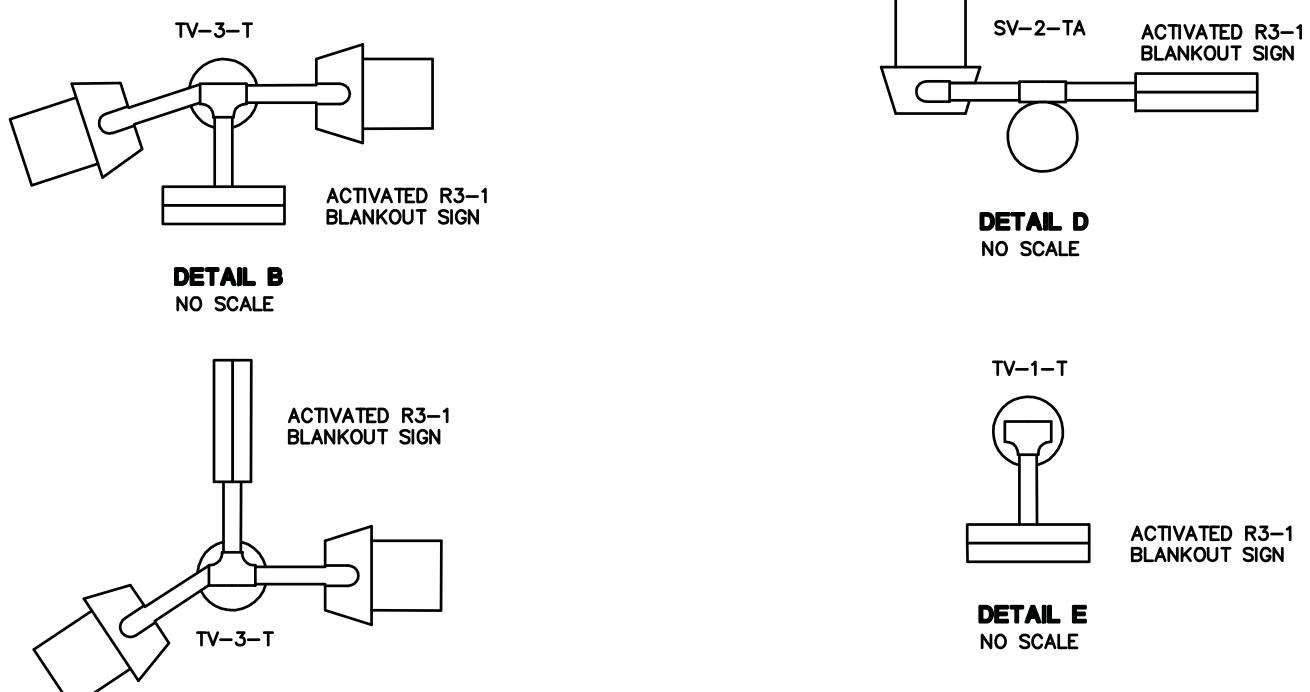

TRAFFIC SIGNAL CONDUCTORS FOR PHASE OVERLAPS SHALL BE DOUBLE STRIPED AS FOLLOWS:

SIGNAL PHASE OLA OLB OLC OLD

BASE COLOR RE, YE, BRN RE, YE, BRN RE, YE, BRN RE, YE, BRN DOUBLE STRIPE COLOR
BLACK/BLUE
BLACK/ORANGE
BLACK/PURPLE
BLACK/GRAY


DETAIL F

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TRANSPORTATION CONSULTANTS, NC.
3250 RAMOS CIRCLE
SACRAMENTO, CA 95827



GATE 6 INTERSECTION IMPROVEMENTS

DATE: 5/24/16

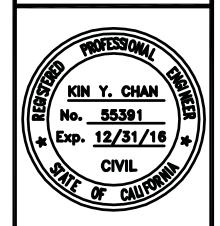
SCALE: 1'=20'

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PROJECT NO:

SHEET

E-4

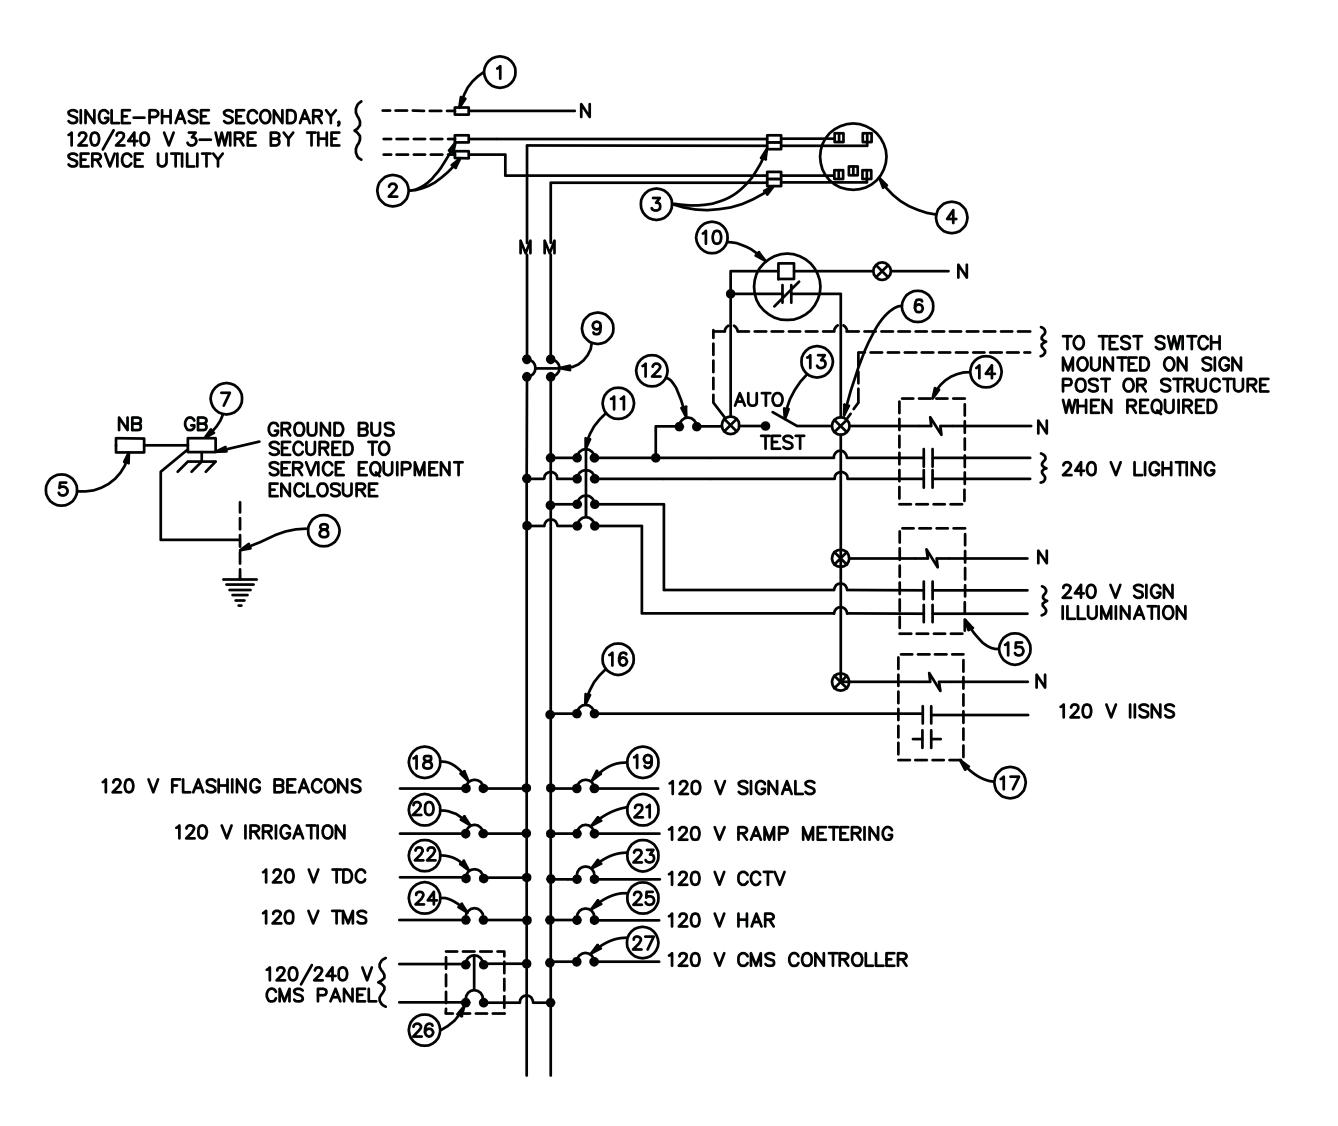


120/240 V SERVICE WIRING DIAGRAM (TYPICAL)

		TYPE III-A SERVICE EQUIPMENT	ENCLSO	URE LEGEND (120/240 \	V)
ITEM No.	COMPONENT	NAME PLATE DESCRIPTION	ITEM No.	COMPONENT	NAME PLATE DESCRIPTION
1	NEUTRAL LUG		(5)	30 A, 2P, NO CONTACTOR	
2	LANDING LUG		16	15 A, 120 V, 1P, CB	IISNS
<u>3</u>	TEST BYPASS FACILITY		\bigcirc	30 A, 2P, NO CONTACTOR	
	METER SOCKET AND SUPPORT		18	15 A, 120 V, 1P, CB	FLASHING BEACON
<u>(5)</u>	NEUTRAL BUS		(19)	50 A, 120 V, 1P, CB	SIGNALS
	TERMINAL BLOCK		20	20 A. 120 V. 1P. CB	IRRIGATION
	GROUND BUS		(21)	30 A. 120 V. 1P. CB	RAMP METERING
	GROUNDING ELECTRODE		2 3	15 A. 120 V. 1P. CB	TELEPHONE DEMARCATION CABINET
	100 A, 240 V, 2P, CB	MAIN BREAKER	23	30 A, 120 V, 1P, CB	CCTV
	PHOTOELECTRIC UNIT (NOTE 7)		24	30 A, 120 V, 1P, CB	TMS
	30 A, 240 V, 4P, CB	LIGHTING AND SIGN ILLUMINATION	2 9	30 A, 120 V, 1P, CB	HAR
	15 A, 120 V, 1P, CB	LIGHTING AND SIGN ILLUMINATION CONTROL	26	30 A, 120 V, 1P, CB	CMS PANEL
	15 A, 120 V, 1P, TEST SWITCH	TEST SWITCH	(7)	30 A, 240 V, 2P, CB	CMS CONTROLLER
(14)	60 A, 2P, NO CONTACTOR				

NOTES: (FOR SERVICE EQUIPMENT)


- 1. VOLTAGE RATINGS OF SERVICE EQUIPMENT SHALL CONFORM TO THE SERVICE VOLTAGES INDICATED ON THE PLANS.
- 2. UNLESS OTHERWISE INDICATED ON THE PLANS, SERVICE EQUIPMENT ITEMS SHALL BE PROVIDED FOR EACH SERVICE EQUIPMENT ENCLOSURE AS SHOWN.
- 3. CONNECT TO REMOTE TEST SWITCH MOUNTED ON SIGN POST OR STRUCTURE WHEN REQUIRED.
- 4. ITEM No. 1 AND No. 5 SHALLBE ISOLATED FROM THE CABINET.
- 5. METER SOCKETS SHALL MEET SERVICE UTILITY REQUIREMENTS.
- 6. THE LANDING LUG SHALL BE SUITABLE FOR MULTIPLE CONDUCTORS.
- 7. PHOTOELECTRIC CONTROL SHALL BE TYPE II.
- 8. SERVICE UTILITY WILL INSTALL THE TIME-OF-USE METER IF APPLICABLE.
- 9. UNLESS OTHERWISE NOTED, THE MAXIMUM NUMBER OF SINGLE-POLE CIRCUIT BREAKERS SPACES IN THE ENCLOSURE IS FOURTEEN.
- 10. SEE STANDARD PLANS ES-2D FOR OTHER DETAILS.

REVISIONS

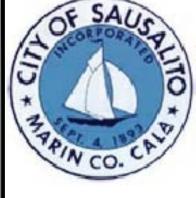

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GATE 6 INTERSECTION IMPROVEMENTS

DATE: 5/24/16

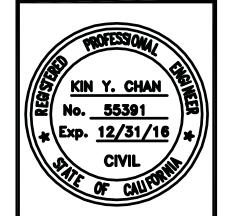SCALE: NO SCALE

DRAWN BY JG

PROJECT NO:

SHEET

E-5