SHADED AREAS COUNTED AS IMPERVIOUS SURFACES APN: PROPERTY LINE 138.14' 34' 36' 38' 40' 42' 44' 46' 48' 50' 52' **IMPERVIOUS SURFACE CALCULATION:** ALLOWABLE AREA OF IMPERVIOUS SURFACES = 75.0% OF SITE AREA OWNER: TOTAL AREA OF IMPERVIOUS SURFACES = 18,973 SQFT 40' 50. SITE AREA = 25,461 SQFT MEL LEE 18,973 SQFT / 25,461 SQFT = 74.5% = PROPOSED AREA OF IMPERVIOUS SURFACES 26' 28' 30' 32' 34' 36' 38' CA 94109 42' PROPERTY LINE 150.10' **BUILDING #1** 46' BUILDING #2 8 P O G E Z P L PROPERTY LINE 123.83' 30' 32' 34' 44' 46' 50' 52' 54' SCALE:

LEGEND:

BRIDGEWAY

COMMONS

160 FILBERT AVE, 1745 & 1757 BRIDGEWAY SAUSALITO, CA 94920

0 6 4 - 1 5 1 - 0 2 0 6 4 - 1 5 1 - 0 3

SY JARDINES LOOKOUT, LLC

OWNERS REP:

1035 VAN NESS SAN FRANCISCO.





NOTE:
THE SCHEMATIC PLANS PROVIDED BY THE
DESIGN ARCHITECT, MILES BERGER, AIA, ARE FOR
GENERAL DESIGN INTENT ONLY. NO
GENERAL DESIGN INTENT ONLY. NO
REPRESENTATION IS MADE THAT THEY MEET ALL
CODE, ACCESSIBILITY, EGRESS OR BUILDING
REQUIREMENTS. THE PREPARATION OF ONLY
OF CONSTRUCTION DOCUMENTS WILL REQUIRE
FOR THE PROPERTY OF THE PROPERTY OF CONSTRUCTION DOCUMENTS WILL REQUIRE
REVIEW AND POSSIBLE REDESIGN OF CODE
COMPULANCE, ACCESSIBILITY, EGRESS, FIRE
PREVENTION MEASURES AND ALL OTHER
APPLICABLE CODES AND REGULATION.

MILES BERGER, AIA

14 RACCOON LANE TIBURON, CA94920 4 1 5 . 4 3 5 . 4 6 6 3 WWW . MB - AIA . COM

MILES @ MB - AIA . COM


SHEET TITLEMPERVIOUS SURFACES DIAGRAM **ROOF LEVEL**

NTS

DATE:

A5.3a

08.16.15

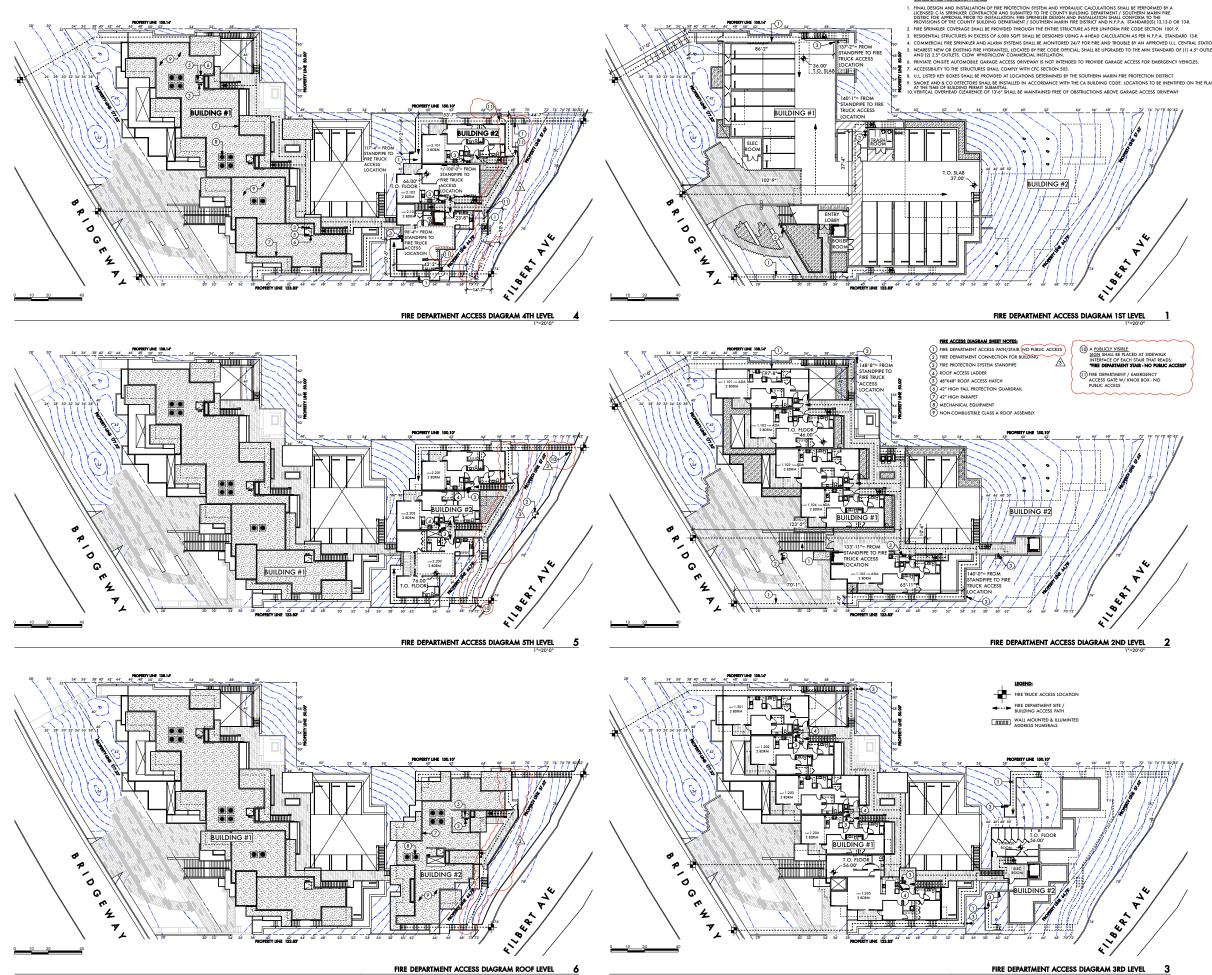

COMMONS

160 FILBERT AVE, 1745 & 1757 BRIDGEWAY S A U S A L I T O

0 6 4 - 1 5 1 - 0 2 0 6 4 - 1 5 1 - 0 3

OWNER:

SY JARDINES LOOKOUT, LLC

OWNERS REP:

MEL LEE 1035 VAN NESS SAN FRANCISCO, CA 94109






MILES BERGER , AIA


14 RACCOON LANE TIBURON, CA 94920 415.435.4663 WWW.MB - AIA.COM MILES@MB - AIA.COM

SHEET TITLE: FIRE DEPT ACCESS DIAGRAMS

,,,,,,,,,,,,,,,,,,,,,,,,,,,,,,,,,,,,,,,	
SCALE:	1"=20'
DRAWN BY:	SV
ROJECT No.:	1302
DATE: 08.12.15	A5 4
	,

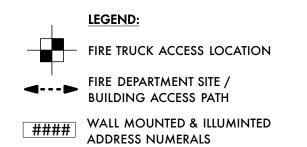

- 1. FINAL DESIGN AND INSTALLATION OF FIRE PROTECTION SYSTEM AND HYDRAULIC CALCULATIONS SHALL BE PERFORMED BY A LICENSED C-16 SPRINLKER CONTRACTOR AND SUBMITTED TO THE COUNTY BUILDING DEPARTMENT / SOUTHERN MARIN FIRE DISTRIC FOR APPROVAL PRIOR TO INSTALLATION. FIRE SPRINKLER DESIGN AND INSTALLATION SHALL CONFORM TO THE PROVISIONS OF THE COUNTY BUILDING DEPARTMENT / SOUTHERN MARIN FIRE DISTRICT AND N.F.P.A. STANDARD(S) 13,13-D OR 13-R.
- FIRE SPRINKLER COVERAGE SHALL BE PROVIDED THROUGH THE ENTIRE STRUCTURE AS PER UNIFORM FIRE CODE SECTION 1001.9.
- 3. RESIDENTIAL STRUCTURES IN EXCESS OF 6,000 SQFT SHALL BE DESIGNED USING A 4-HEAD CALCULATION AS PER N.F.P.A. STANDARD 13-R.
- 4. COMMERCIAL FIRE SPRINKLER AND ALARM SYSTEMS SHALL BE MONITORED 24/7 FOR FIRE AND TROUBLE BY AN APPROVED U.L. CENTRAL STATION.
- 5. NEAREST NEW OR EXISTING FIRE HYDRANT(S), LOCATED BY FIRE CODE OFFICIAL, SHALL BE UPGRADED TO THE MIN STANDARD OF (1) 4.5" OUTLET AND (2) 2.5" OUTLETS. CLOW #FHD76CLOW COMMERCIAL INSTLLATION.
- 6. PRIVIATE ON-SITE AUTOMOBILE GARAGE ACCESS DRIVEWAY IS NOT INTENDED TO PROVIDE GARAGE ACCESS FOR EMERGENCY VEHICLES.
- 7. ACCESSIBILITY TO THE STRUCTURES SHALL COMPLY WITH CFC SECTION 503.
- 8. U.L. LISTED KEY BOXES SHALL BE PROVIDED AT LOCATIONS DETERMINED BY THE SOUTHERN MARIN FIRE PROTECTION DISTRICT.

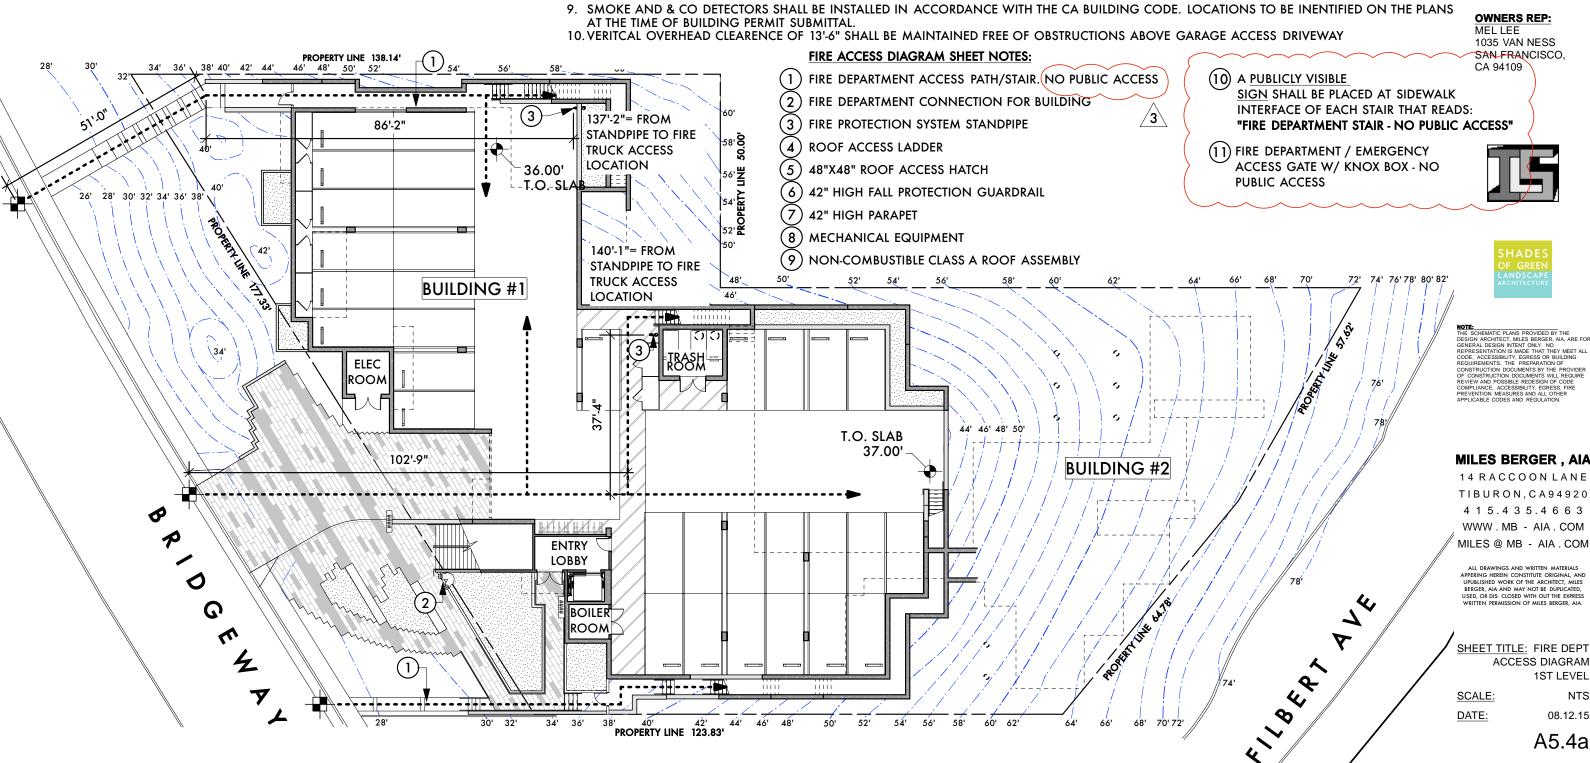

BRIDGEWAY

COMMONS

160 FILBERT AVE, 1745 & 1757 BRIDGEWAY SAUSALITO, CA 94920

APN:

0 6 4 - 1 5 1 - 0 2 0 6 4 - 1 5 1 - 0 3

> OWNER: SY JARDINES LOOKOUT, LLC

THE SCHEMATIC PLANS PROVIDED BY THE DESIGN ARCHITECT, MILES BERGER, AIA, ARE FOR GENERAL DESIGN INTENT ONLY. NO REPRESENTATION IS MADE THAT THEY MEET ALL CODE. ACCESSIBILITY, EGRESS OR BUILDING REQUIREMENTS. THE PREPARATION OF CONSTRUCTION DOCUMENTS BY THE PROVIDER OF CONSTRUCTION DOCUMENTS WILL REQUIRE REVIEW AND POSSIBLE REDESIGN OF CODE


WWW . MB - AIA . COM

MILES @ MB - AIA . COM

UPUBLISHED WORK OF THE ARCHITECT. MILES USED. OR DIS- CLOSED WITH OUT THE EXPRESS

ACCESS DIAGRAM 1ST LEVEL

A5.4a

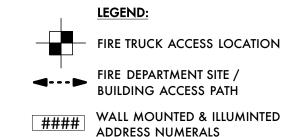

- 1. FINAL DESIGN AND INSTALLATION OF FIRE PROTECTION SYSTEM AND HYDRAULIC CALCULATIONS SHALL BE PERFORMED BY A LICENSED C-16 SPRINLKER CONTRACTOR AND SUBMITTED TO THE COUNTY BUILDING DEPARTMENT / SOUTHERN MARIN FIRE DISTRIC FOR APPROVAL PRIOR TO INSTALLATION, FIRE SPRINKLER DESIGN AND INSTALLATION SHALL CONFORM TO THE PROVISIONS OF THE COUNTY BUILDING DEPARTMENT / SOUTHERN MARIN FIRE DISTRICT AND N.F.P.A. STANDARD(S) 13.13-D OR 13-R.
- 2. FIRE SPRINKLER COVERAGE SHALL BE PROVIDED THROUGH THE ENTIRE STRUCTURE AS PER UNIFORM FIRE CODE SECTION 1001.9.
- 3. RESIDENTIAL STRUCTURES IN EXCESS OF 6,000 SQFT SHALL BE DESIGNED USING A 4-HEAD CALCULATION AS PER N.F.P.A. STANDARD 13-R.
- 4. COMMERCIAL FIRE SPRINKLER AND ALARM SYSTEMS SHALL BE MONITORED 24/7 FOR FIRE AND TROUBLE BY AN APPROVED U.L. CENTRAL STATION.
- 5. NEAREST NEW OR EXISTING FIRE HYDRANT(S), LOCATED BY FIRE CODE OFFICIAL, SHALL BE UPGRADED TO THE MIN STANDARD OF (1) 4.5" OUTLET AND (2) 2.5" OUTLETS. CLOW #FHD76CLOW COMMERCIAL INSTLLATION.
- 6. PRIVIATE ON-SITE AUTOMOBILE GARAGE ACCESS DRIVEWAY IS NOT INTENDED TO PROVIDE GARAGE ACCESS FOR EMERGENCY VEHICLES.
- 7. ACCESSIBILITY TO THE STRUCTURES SHALL COMPLY WITH CFC SECTION 503.
- 8. U.L. LISTED KEY BOXES SHALL BE PROVIDED AT LOCATIONS DETERMINED BY THE SOUTHERN MARIN FIRE PROTECTION DISTRICT.
- 9. SMOKE AND & CO DETECTORS SHALL BE INSTALLED IN ACCORDANCE WITH THE CA BUILDING CODE. LOCATIONS TO BE INENTIFIED ON THE PLANS AT THE TIME OF BUILDING PERMIT SUBMITTAL



BRIDGEWAY

COMMONS

160 FILBERT AVE,

1745 & 1757 BRIDGEWAY

SAUSALITO, CA 94920

0 6 4 - 1 5 1 - 0 2 0 6 4 - 1 5 1 - 0 3

SY JARDINES

LOOKOUT, LLC

APN:

OWNER:



NOTE:
THE SCHEMATIC PLANS PROVIDED BY THE
DESIGN ARCHITECT, MILES BERGER, AIA, ARE FOR
GENERAL DESIGN INTENT ONLY. NO
REPRESENTATION IS MADE THAT THEY MEET ALL
CODE. ACCESSIBILITY, EGRESS OR BUILDING
REQUIREMENTS. THE MEET ANATOMIC FOR OVER
CONSTRUCTION DOCUMENTS WILL REQUIRE
FEVIEW AND POSSIBLE REPOSION OF CODE
COMPLIANCE, ACCESSIBILITY, EGRESS, FIRE
PREVENTED MAD MEASURES AND ALL OTHER
APPLICABLE CODES AND REGULATION.

14 RACCOON LANE

4 1 5 . 4 3 5 . 4 6 6 3 WWW.MB - AIA.COM


MILES @ MB - AIA . COM


ALL DRAWINGS AND WRITTEN MATERIALS APPERING HEREIN CONSTITUTE ORIGINAL, AND UPUBLISHED WORK OF THE ARCHITECT, MILES BERCER, AIA AND MAY NOT BE DUPLICATED, USED, OR DIS. CLOSED WITH OUT THE EXPRESS WRITTEN PERMISSION OF MILES BERCER, AIA.

SHEET TITLE: FIRE DEPT ACCESS DIAGRAM 2ND LEVEL

> NTS 08.12.15

A5.4b

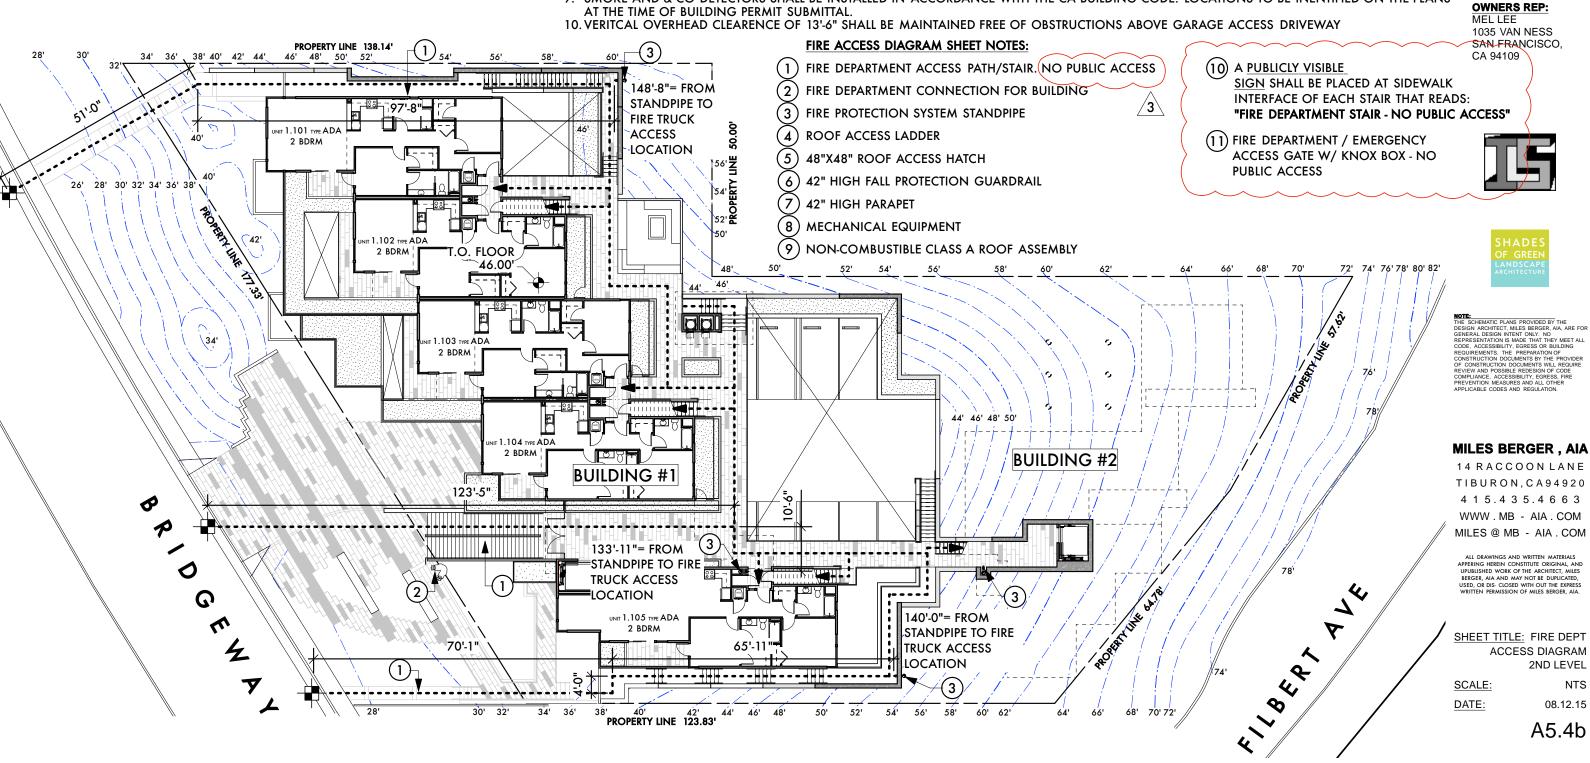

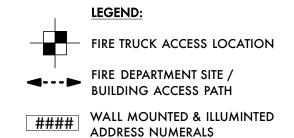

- 1. FINAL DESIGN AND INSTALLATION OF FIRE PROTECTION SYSTEM AND HYDRAULIC CALCULATIONS SHALL BE PERFORMED BY A LICENSED C-16 SPRINKER CONTRACTOR AND SUBMITTED TO THE COUNTY BUILDING DEPARTMENT / SOUTHERN MARIN FIRE DISTRIC FOR APPROVAL PRIOR TO INSTALLATION. FIRE SPRINKLER DESIGN AND INSTALLATION SHALL CONFORM TO THE PROVISIONS OF THE COUNTY BUILDING DEPARTMENT / SOUTHERN MARIN FIRE DISTRICT AND N.F.P.A. STANDARD(S) 13,13-D OR 13-R.
- 2. FIRE SPRINKLER COVERAGE SHALL BE PROVIDED THROUGH THE ENTIRE STRUCTURE AS PER UNIFORM FIRE CODE SECTION 1001.9.
- 3. RESIDENTIAL STRUCTURES IN EXCESS OF 6,000 SQFT SHALL BE DESIGNED USING A 4-HEAD CALCULATION AS PER N.F.P.A. STANDARD 13-R.
- 4. COMMERCIAL FIRE SPRINKLER AND ALARM SYSTEMS SHALL BE MONITORED 24/7 FOR FIRE AND TROUBLE BY AN APPROVED U.L. CENTRAL STATION.

BRIDGEWAY

COMMONS

160 FILBERT AVE,

1745 & 1757 BRIDGEWAY

SAUSALITO, CA 94920

0 6 4 - 1 5 1 - 0 2 0 6 4 - 1 5 1 - 0 3

SY JARDINES

OWNERS REP:


LOOKOUT, LLC


APN:

OWNER:


MEL LEE

- 5. NEAREST NEW OR EXISTING FIRE HYDRANT(S), LOCATED BY FIRE CODE OFFICIAL, SHALL BE UPGRADED TO THE MIN STANDARD OF (1) 4.5" OUTLET AND (2) 2.5" OUTLETS. CLOW #FHD76CLOW COMMERCIAL INSTILLATION.
- 6. PRIVIATE ON-SITE AUTOMOBILE GARAGE ACCESS DRIVEWAY IS NOT INTENDED TO PROVIDE GARAGE ACCESS FOR EMERGENCY VEHICLES.
- 7. ACCESSIBILITY TO THE STRUCTURES SHALL COMPLY WITH CFC SECTION 503.
- 8. U.L. LISTED KEY BOXES SHALL BE PROVIDED AT LOCATIONS DETERMINED BY THE SOUTHERN MARIN FIRE PROTECTION DISTRICT.
- 9. SMOKE AND & CO DETECTORS SHALL BE INSTALLED IN ACCORDANCE WITH THE CA BUILDING CODE. LOCATIONS TO BE INENTIFIED ON THE PLANS AT THE TIME OF BUILDING PERMIT SUBMITTAL.
- 10. VERITCAL OVERHEAD CLEARENCE OF 13'-6" SHALL BE MAINTAINED FREE OF OBSTRUCTIONS ABOVE GARAGE ACCESS DRIVEWAY

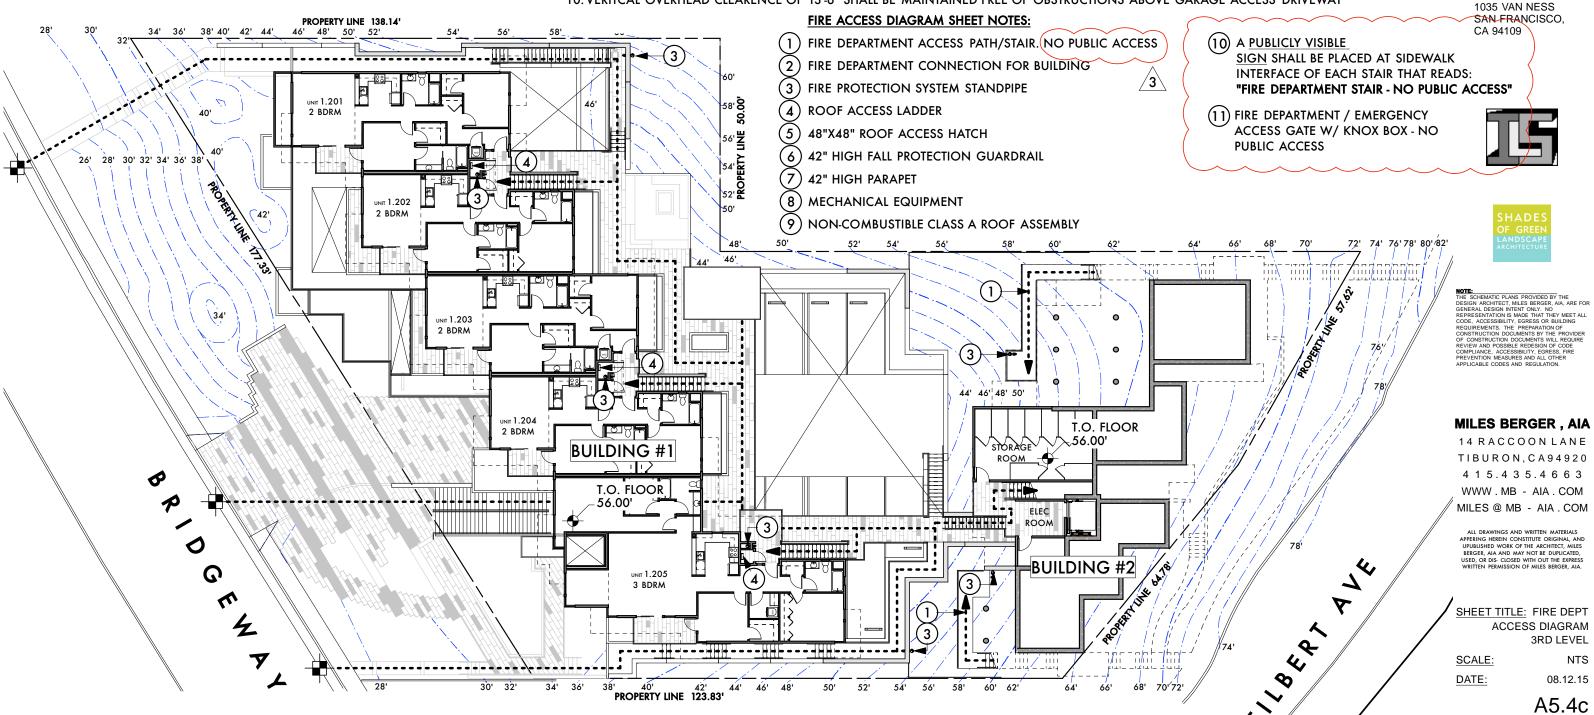

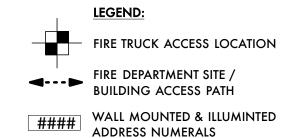

- 1. FINAL DESIGN AND INSTALLATION OF FIRE PROTECTION SYSTEM AND HYDRAULIC CALCULATIONS SHALL BE PERFORMED BY A LICENSED C-16 SPRINLKER CONTRACTOR AND SUBMITTED TO THE COUNTY BUILDING DEPARTMENT / SOUTHERN MARIN FIRE DISTRIC FOR APPROVAL PRIOR TO INSTALLATION, FIRE SPRINKLER DESIGN AND INSTALLATION SHALL CONFORM TO THE PROVISIONS OF THE COUNTY BUILDING DEPARTMENT / SOUTHERN MARIN FIRE DISTRICT AND N.F.P.A. STANDARD(S) 13.13-D OR 13-R.
- 2. FIRE SPRINKLER COVERAGE SHALL BE PROVIDED THROUGH THE ENTIRE STRUCTURE AS PER UNIFORM FIRE CODE SECTION 1001.9.
- 3. RESIDENTIAL STRUCTURES IN EXCESS OF 6,000 SQFT SHALL BE DESIGNED USING A 4-HEAD CALCULATION AS PER N.F.P.A. STANDARD 13-R.
- 4. COMMERCIAL FIRE SPRINKLER AND ALARM SYSTEMS SHALL BE MONITORED 24/7 FOR FIRE AND TROUBLE BY AN APPROVED U.L. CENTRAL STATION.
- 5. NEAREST NEW OR EXISTING FIRE HYDRANT(S), LOCATED BY FIRE CODE OFFICIAL, SHALL BE UPGRADED TO THE MIN STANDARD OF (1) 4.5" OUTLET AND (2) 2.5" OUTLETS. CLOW #FHD76CLOW COMMERCIAL INSTLLATION.
- 6. PRIVIATE ON-SITE AUTOMOBILE GARAGE ACCESS DRIVEWAY IS NOT INTENDED TO PROVIDE GARAGE ACCESS FOR EMERGENCY VEHICLES.
- 7. ACCESSIBILITY TO THE STRUCTURES SHALL COMPLY WITH CFC SECTION 503.
- 8. U.L. LISTED KEY BOXES SHALL BE PROVIDED AT LOCATIONS DETERMINED BY THE SOUTHERN MARIN FIRE PROTECTION DISTRICT.
- 9. SMOKE AND & CO DETECTORS SHALL BE INSTALLED IN ACCORDANCE WITH THE CA BUILDING CODE. LOCATIONS TO BE INENTIFIED ON THE PLANS AT THE TIME OF BUILDING PERMIT SUBMITTAL.

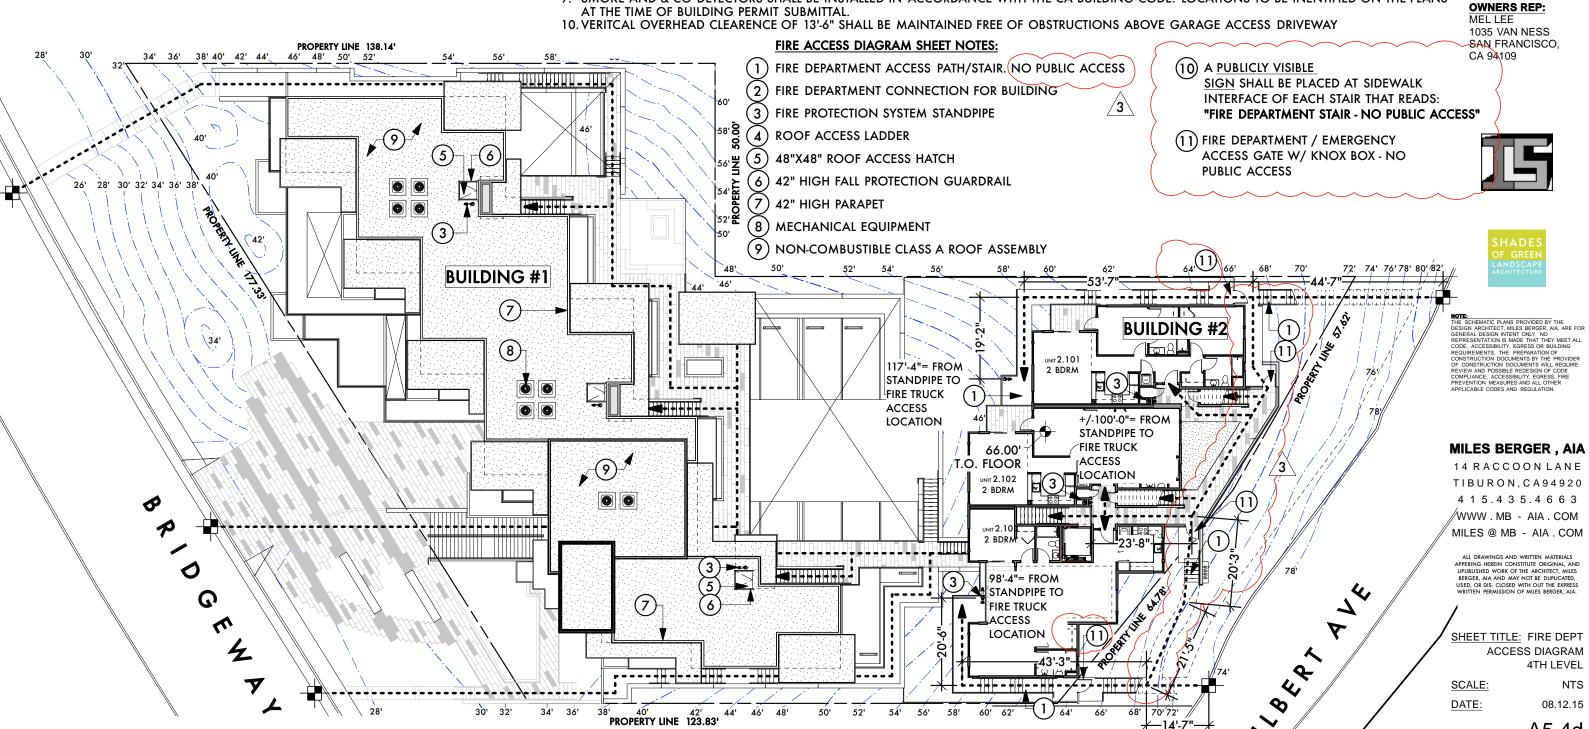

BRIDGEWAY

COMMONS

160 FILBERT AVE, 1745 & 1757 BRIDGEWAY SAUSALITO, CA 94920

APN:

0 6 4 - 1 5 1 - 0 2 0 6 4 - 1 5 1 - 0 3


OWNER: SY JARDINES LOOKOUT, LLC

MILES @ MB - AIA . COM


ACCESS DIAGRAM 4TH LEVEL

NTS

A5.4d

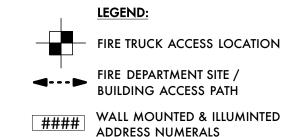

- 1. FINAL DESIGN AND INSTALLATION OF FIRE PROTECTION SYSTEM AND HYDRAULIC CALCULATIONS SHALL BE PERFORMED BY A LICENSED C-16 SPRINLKER CONTRACTOR AND SUBMITTED TO THE COUNTY BUILDING DEPARTMENT / SOUTHERN MARIN FIRE DISTRIC FOR APPROVAL PRIOR TO INSTALLATION, FIRE SPRINKLER DESIGN AND INSTALLATION SHALL CONFORM TO THE PROVISIONS OF THE COUNTY BUILDING DEPARTMENT / SOUTHERN MARIN FIRE DISTRICT AND N.F.P.A. STANDARD(S) 13.13-D OR 13-R.
- 2. FIRE SPRINKLER COVERAGE SHALL BE PROVIDED THROUGH THE ENTIRE STRUCTURE AS PER UNIFORM FIRE CODE SECTION 1001.9.
- 3. RESIDENTIAL STRUCTURES IN EXCESS OF 6,000 SQFT SHALL BE DESIGNED USING A 4-HEAD CALCULATION AS PER N.F.P.A. STANDARD 13-R.
- 4. COMMERCIAL FIRE SPRINKLER AND ALARM SYSTEMS SHALL BE MONITORED 24/7 FOR FIRE AND TROUBLE BY AN APPROVED U.L. CENTRAL STATION.
- 5. NEAREST NEW OR EXISTING FIRE HYDRANT(S), LOCATED BY FIRE CODE OFFICIAL, SHALL BE UPGRADED TO THE MIN STANDARD OF (1) 4.5" OUTLET AND (2) 2.5" OUTLETS. CLOW #FHD76CLOW COMMERCIAL INSTLLATION.
- 6. PRIVIATE ON-SITE AUTOMOBILE GARAGE ACCESS DRIVEWAY IS NOT INTENDED TO PROVIDE GARAGE ACCESS FOR EMERGENCY VEHICLES.
- 7. ACCESSIBILITY TO THE STRUCTURES SHALL COMPLY WITH CFC SECTION 503.
- 8. U.L. LISTED KEY BOXES SHALL BE PROVIDED AT LOCATIONS DETERMINED BY THE SOUTHERN MARIN FIRE PROTECTION DISTRICT.
- 9. SMOKE AND & CO DETECTORS SHALL BE INSTALLED IN ACCORDANCE WITH THE CA BUILDING CODE. LOCATIONS TO BE INENTIFIED ON THE PLANS AT THE TIME OF BUILDING PERMIT SUBMITTAL

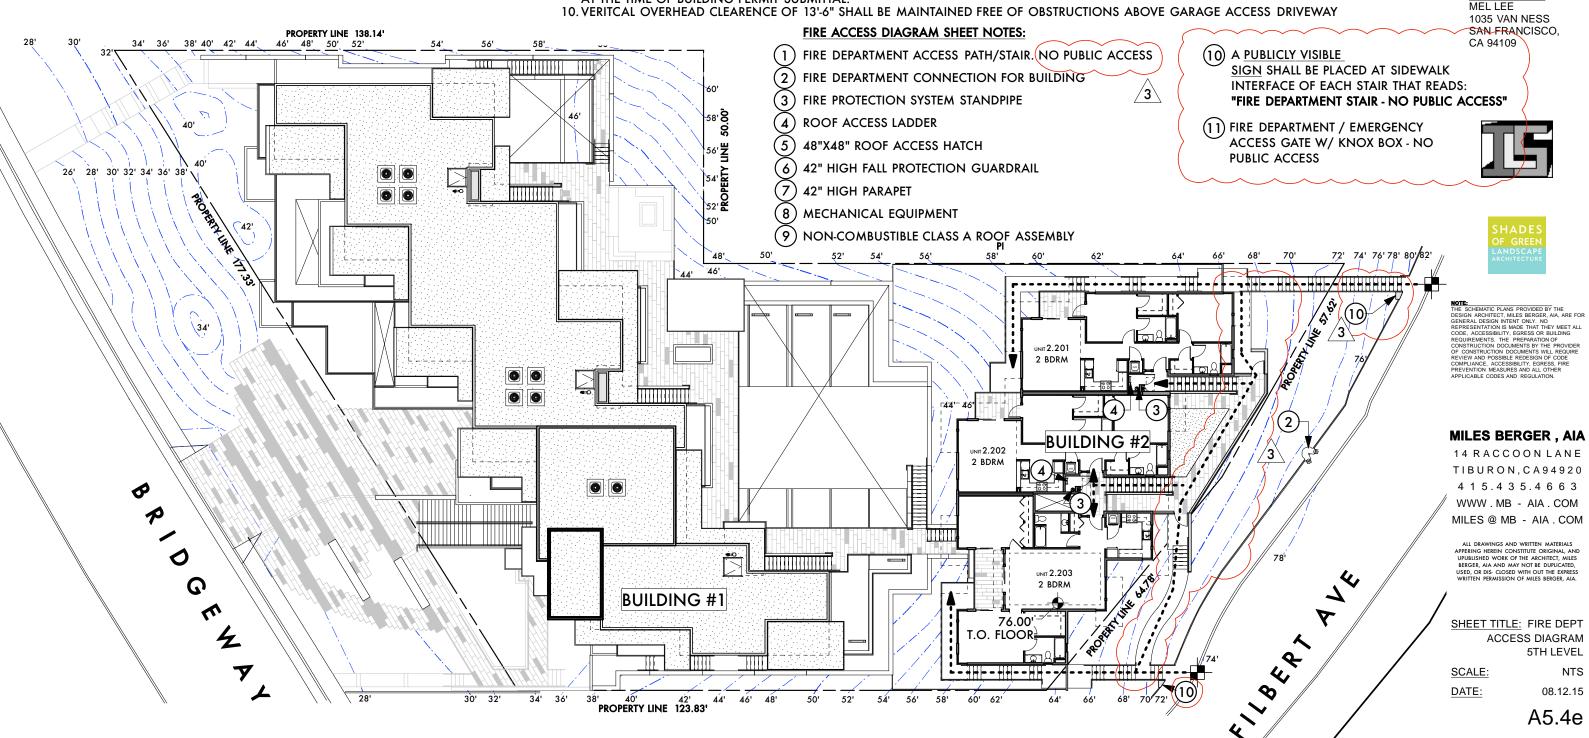

BRIDGEWAY

COMMONS

160 FILBERT AVE, 1745 & 1757 BRIDGEWAY SAUSALITO, CA 94920

APN:

0 6 4 - 1 5 1 - 0 2 0 6 4 - 1 5 1 - 0 3

OWNER: SY JARDINES LOOKOUT, LLC

OWNERS REP:

MEL LEE


14 RACCOON LANE

4 1 5 . 4 3 5 . 4 6 6 3


MILES @ MB - AIA . COM

ACCESS DIAGRAM 5TH LEVEL

NTS

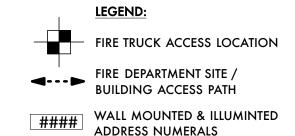

- 1. FINAL DESIGN AND INSTALLATION OF FIRE PROTECTION SYSTEM AND HYDRAULIC CALCULATIONS SHALL BE PERFORMED BY A LICENSED C-16 SPRINLKER CONTRACTOR AND SUBMITTED TO THE COUNTY BUILDING DEPARTMENT / SOUTHERN MARIN FIRE DISTRIC FOR APPROVAL PRIOR TO INSTALLATION, FIRE SPRINKLER DESIGN AND INSTALLATION SHALL CONFORM TO THE PROVISIONS OF THE COUNTY BUILDING DEPARTMENT / SOUTHERN MARIN FIRE DISTRICT AND N.F.P.A. STANDARD(S) 13.13-D OR 13-R.
- 2. FIRE SPRINKLER COVERAGE SHALL BE PROVIDED THROUGH THE ENTIRE STRUCTURE AS PER UNIFORM FIRE CODE SECTION 1001.9.
- 3. RESIDENTIAL STRUCTURES IN EXCESS OF 6,000 SQFT SHALL BE DESIGNED USING A 4-HEAD CALCULATION AS PER N.F.P.A. STANDARD 13-R.
- 4. COMMERCIAL FIRE SPRINKLER AND ALARM SYSTEMS SHALL BE MONITORED 24/7 FOR FIRE AND TROUBLE BY AN APPROVED U.L. CENTRAL STATION.
- 5. NEAREST NEW OR EXISTING FIRE HYDRANT(S), LOCATED BY FIRE CODE OFFICIAL, SHALL BE UPGRADED TO THE MIN STANDARD OF (1) 4.5" OUTLET AND (2) 2.5" OUTLETS. CLOW #FHD76CLOW COMMERCIAL INSTLLATION.
- 6. PRIVIATE ON-SITE AUTOMOBILE GARAGE ACCESS DRIVEWAY IS NOT INTENDED TO PROVIDE GARAGE ACCESS FOR EMERGENCY VEHICLES.
- 7. ACCESSIBILITY TO THE STRUCTURES SHALL COMPLY WITH CFC SECTION 503.
- 8. U.L. LISTED KEY BOXES SHALL BE PROVIDED AT LOCATIONS DETERMINED BY THE SOUTHERN MARIN FIRE PROTECTION DISTRICT.
- 9. SMOKE AND & CO DETECTORS SHALL BE INSTALLED IN ACCORDANCE WITH THE CA BUILDING CODE. LOCATIONS TO BE INENTIFIED ON THE PLANS AT THE TIME OF BUILDING PERMIT SUBMITTAL

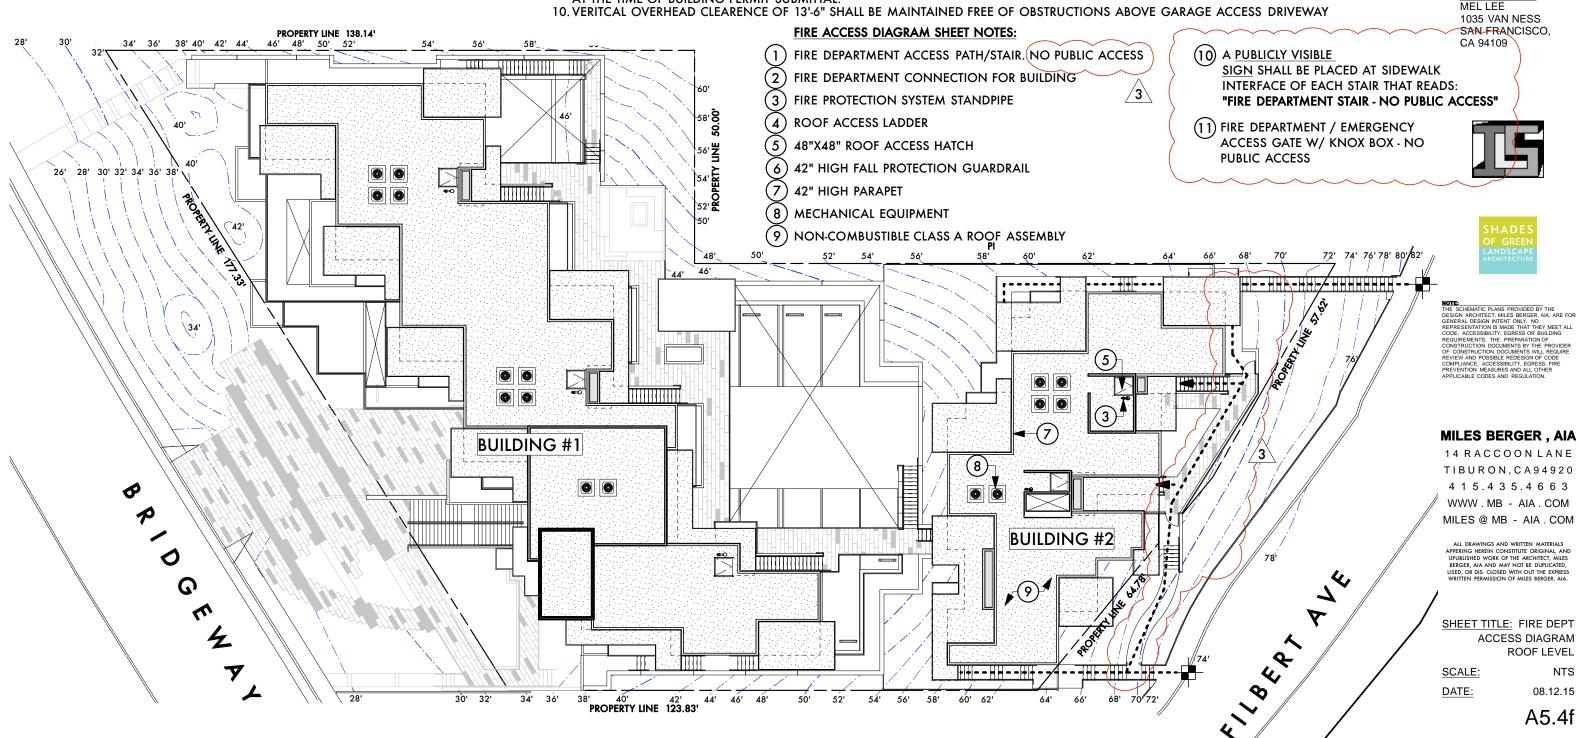

BRIDGEWAY

COMMONS

160 FILBERT AVE, 1745 & 1757 BRIDGEWAY SAUSALITO, CA 94920

APN:

0 6 4 - 1 5 1 - 0 2 0 6 4 - 1 5 1 - 0 3

OWNER: SY JARDINES


LOOKOUT, LLC **OWNERS REP:**

MEL LEE

MILES @ MB - AIA . COM

ACCESS DIAGRAM **ROOF LEVEL**

NTS

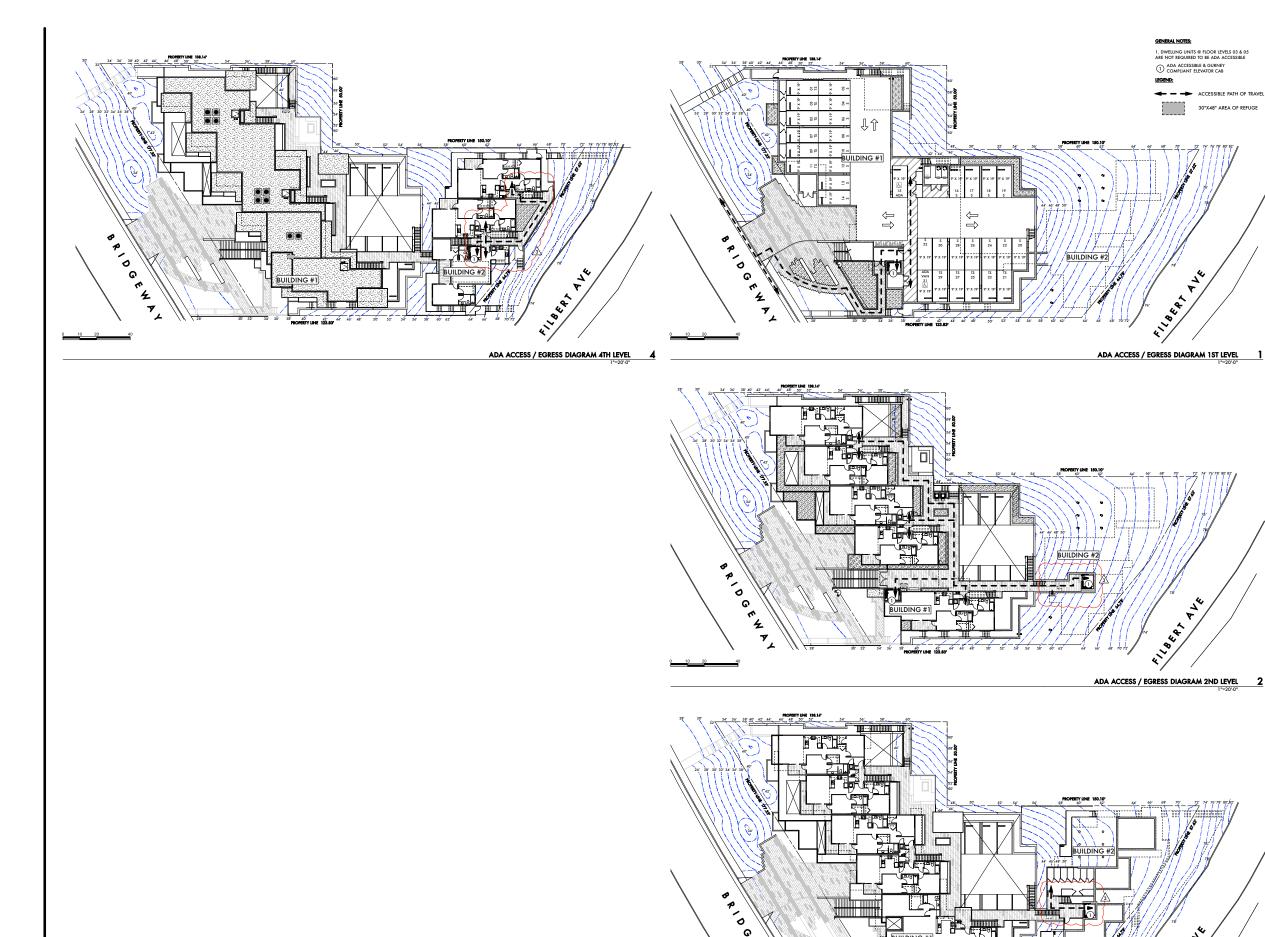

COMMONS

160 FILBERT AVE, 1745 & 1757 BRIDGEWAY S A U S A L I T O

A P N: 0 6 4 - 1 5 1 - 0 2 0 6 4 - 1 5 1 - 0 3

OWNER:

SY JARDINES LOOKOUT, LLC

OWNERS REP:

MEL LEE 1035 VAN NESS SAN FRANCISCO, CA 94109

THE MEMORY FANDS PROVIDED BY THE DESIGN INCHIFECT MISS ROPEGE ALL, AS REGISTED, AS THE DESIGN INCHIFECT MISS ROPEGE ALL, AS THE MEMORY FANDS THE MEMORY FOR THE MEMORY FOR





MILES BERGER , AIA


14 RACCOON LANE TIBURON, CA 94920 4 1 5 . 4 3 5 . 4 6 6 3 WWW.MB - AIA.COM MILES@MB - AIA.COM

ALL DRAWINGS AND WRITTEN MATERIALS APPERING HE CONSTITUTE ORIGINAL, AND UPUBLISHED WORK OF T ARCHITECT, MILES BERGER, AIA AND MAY NOT BE DUPLIC USED, OR DIS -CLOSED WITH OUT THE EXPRESS WRITTE

SHEET TITLE:	ADA DIAGRAM
SCALE:	1"=2
DRAWN BY:	
PROJECT No.	.: 13

DATE: 08.12.15 A5.5

ADA ACCESS / EGRESS DIAGRAM 3RD LEVEL 3

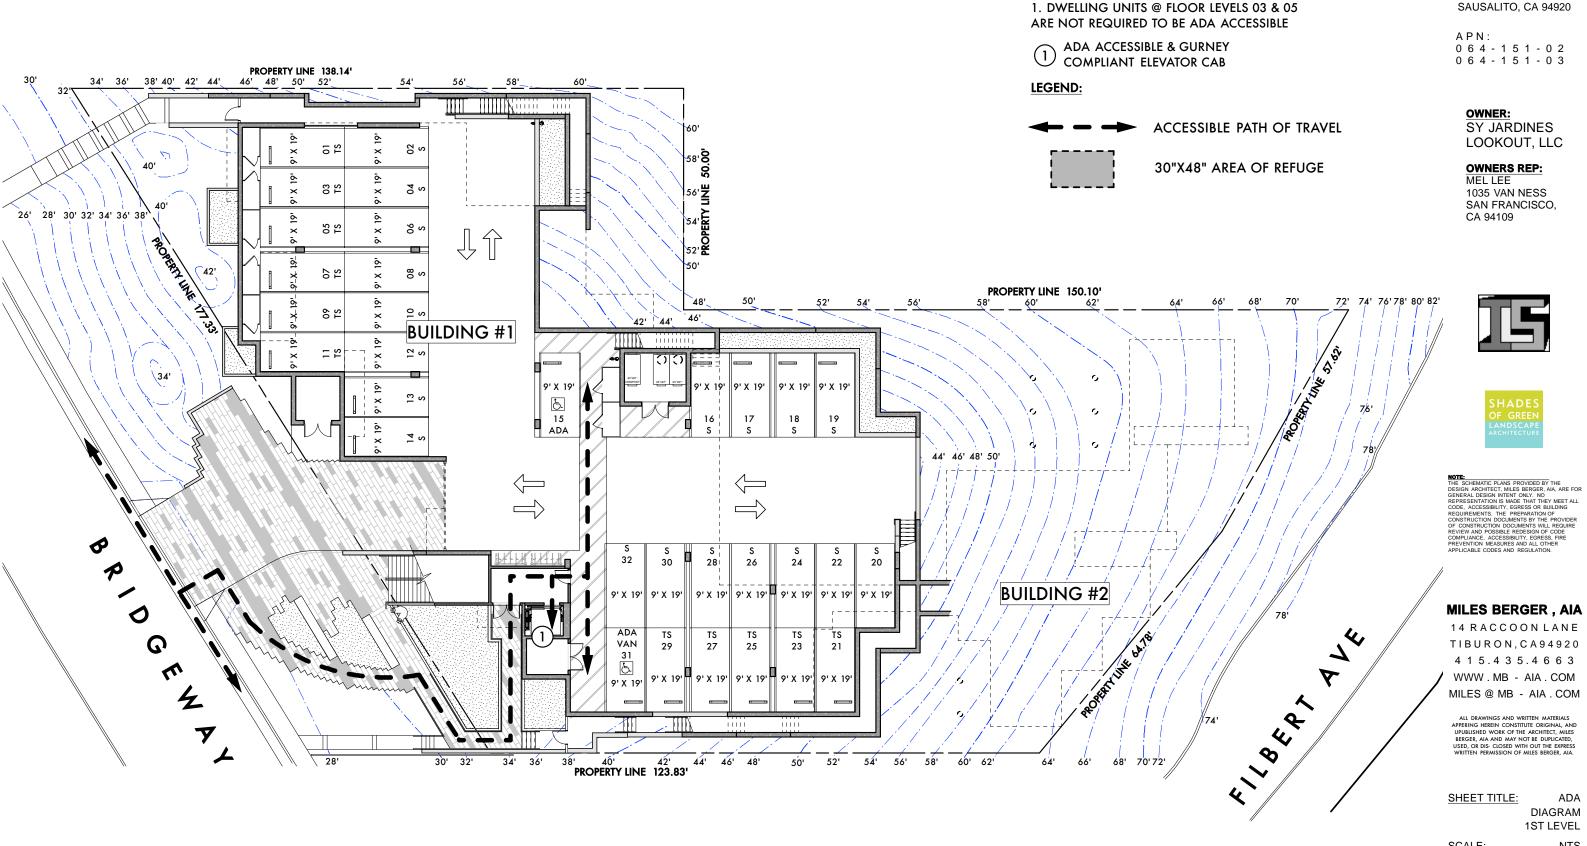

BRIDGEWAY


COMMONS

160 FILBERT AVE, 1745 & 1757 BRIDGEWAY SAUSALITO, CA 94920

SCALE: NTS

DATE:

A5.5.a

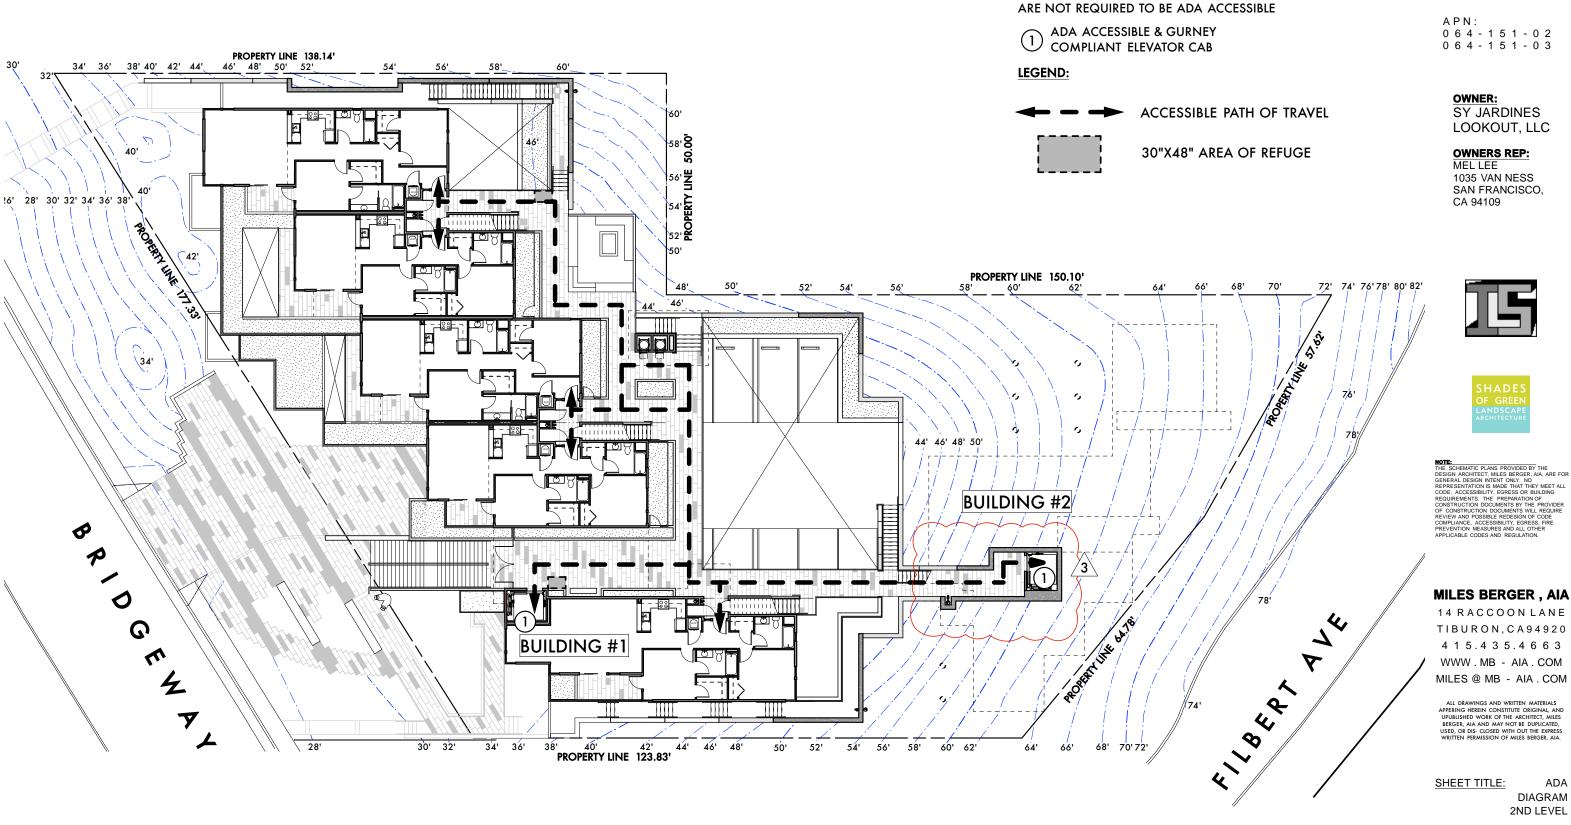

1. DWELLING UNITS @ FLOOR LEVELS 03 & 05

BRIDGEWAY

COMMONS

160 FILBERT AVE, 1745 & 1757 BRIDGEWAY SAUSALITO, CA 94920

> SY JARDINES LOOKOUT, LLC

OWNERS REP:

1035 VAN NESS SAN FRANCISCO.





NOTE:
THE SCHEMATIC PLANS PROVIDED BY THE
DESIGN ARCHITECT, MILES BERGER, AIA, ARE FOR
GENERAL DESIGN INTENT ONLY. NO
REPRESENTATION IS MADE THAT THEY MEET ALL
CODE, ACCESSIBILITY, EGRESS OR BUILDING
REQUIREMENTS DECLINERARION FOR ONLY
OF CONSTRUCTION DOCUMENTS WILL REQUIRE
REVIEW AND POSSIBLE REDESIGN OF CODE
COMPULANCE, ACCESSIBILITY, EGRESS, FIRE
PREVENTION MEASURES AND ALL OTHER
APPLICABLE CODES AND REGULATION.

TIBURON, CA94920 4 1 5 . 4 3 5 . 4 6 6 3 WWW . MB - AIA . COM

MILES @ MB - AIA . COM


DIAGRAM 2ND LEVEL

ADA

SCALE: NTS

DATE:

A5.5b

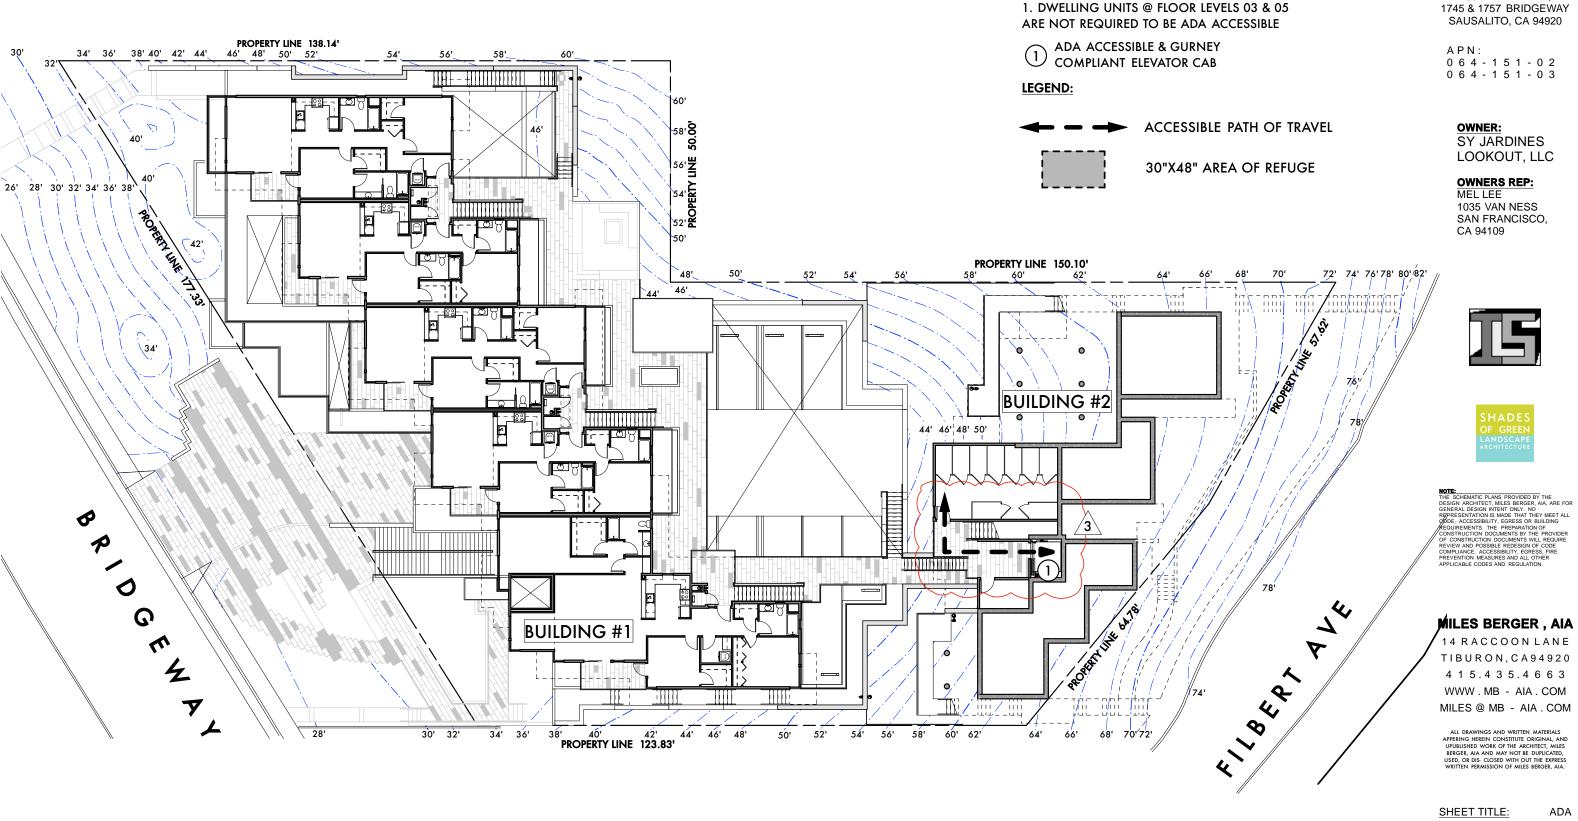

BRIDGEWAY

COMMONS


160 FILBERT AVE, 1745 & 1757 BRIDGEWAY

DIAGRAM 3RD LEVEL

SCALE: NTS

DATE:

A5.5.c

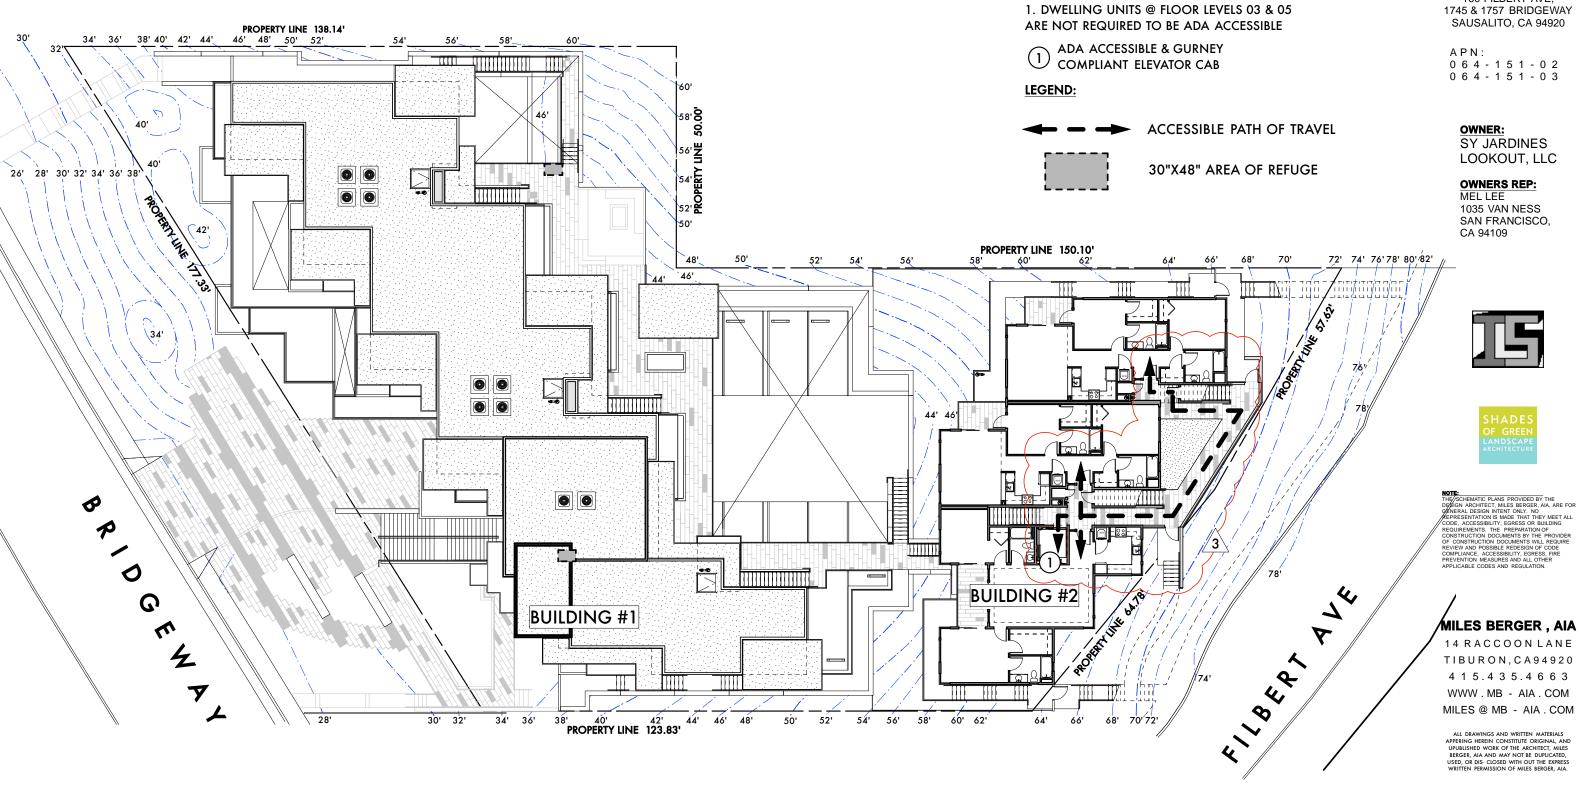

BRIDGEWAY

COMMONS

160 FILBERT AVE,

SHEET TITLE:


DIAGRAM 4th LEVEL

ADA

SCALE: NTS

DATE:

A5.5d

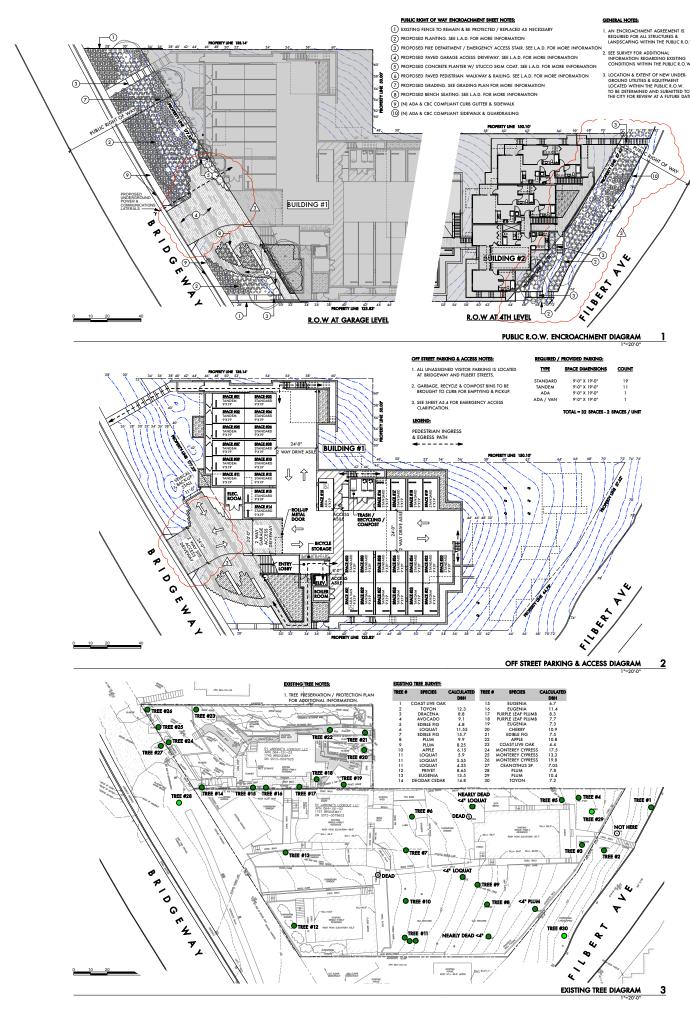

 $\mathsf{C} \mathsf{O} \mathsf{M} \mathsf{M} \mathsf{O} \mathsf{N} \mathsf{S}$

160 FILBERT AVE, 1745 & 1757 BRIDGEWAY S A U S A L I T O

A P N: 064-151-02 064-151-03

OWNER:

SY JARDINES LOOKOUT, LLC

OWNERS REP:

MEL LEE 1035 VAN NESS SAN FRANCISCO, CA 94109





MILES BERGER , AIA

14 RACCOON LANE TIBURON, CA 94920 415.435.4663 WWW.MB - AIA.COM MILES@MB - AIA.COM

SHEET TITLE: R.O.W, OFF STREET PARKING & EXISTING TREE DIAGRAMS

SCALE: DRAWN BY: SV

1302 PROJECT No.: DATE: 08.12.15 A5.6

PUBLIC RIGHT OF WAY ENCROACHMENT SHEET NOTES:

- (1) EXISTING FENCE TO REMAIN & BE PROTECTED / REPLACED AS NECESSARY
- (2) PROPOSED PLANTING. SEE L.A.D. FOR MORE INFORMATION
- (3) PROPOSED FIRE DEPARTMENT / EMERGENCY ACCESS STAIR. SEE L.A.D. FOR MORE INFORMATION
- (4) PROPOSED PAVED GARAGE ACCESS DRIVEWAY. SEE L.A.D. FOR MORE INFORMATION
- (5) PROPOSED CONCRETE PLANTER W/ STUCCO SKIM COAT. SEE L.A.D. FOR MORE INFORMATION

R.O.W AT 4TH LEVEL

- (6) PROPOSED PAVED PEDISTRIAN WALKWAY & RAILING. SEE L.A.D. FOR MORE INFORMATION
- (7) PROPOSED GRADING. SEE GRADING PLAN FOR MORE INFORMATION
- (8) PROPOSED BENCH SEATING. SEE L.A.D. FOR MORE INFORMATION

PROPERTY LINE 138.14'

46' 48' 50' 52'

38' 40' 42' 44'

(3)

GENERAL NOTES:

- 1. AN ENCROACHMENT AGREEMENT IS **REQUIRED FOR ALL STRUCTURES &** LANDSCAPING WITHIN THE PUBLIC R.O.W.
- 2. SEE SURVEY FOR ADDITIONAL INFORMATION REGARDING EXISTING CONDITIONS WITHIN THE PUBLIC R.O.W.
- 3. LOCATION & EXTENT OF NEW UNDER-**GROUND UTILITIES & EQUITPMENT** LOCATED WITHIN THE PUBLIC R.O.W. TO BE DETERMINED AND SUBMITTED TO THE CITY FOR REVIEW AT A FUTURE DATE.

BRIDGEWAY

COMMONS


160 FILBERT AVE, 1745 & 1757 BRIDGEWAY SAUSALITO, CA 94920

APN: 0 6 4 - 1 5 1 - 0 2 0 6 4 - 1 5 1 - 0 3

OWNER: SY JARDINES LOOKOUT, LLC

OWNERS REP:

MEL LEE 1035 VAN NESS SAN FRANCISCO. CA 94109

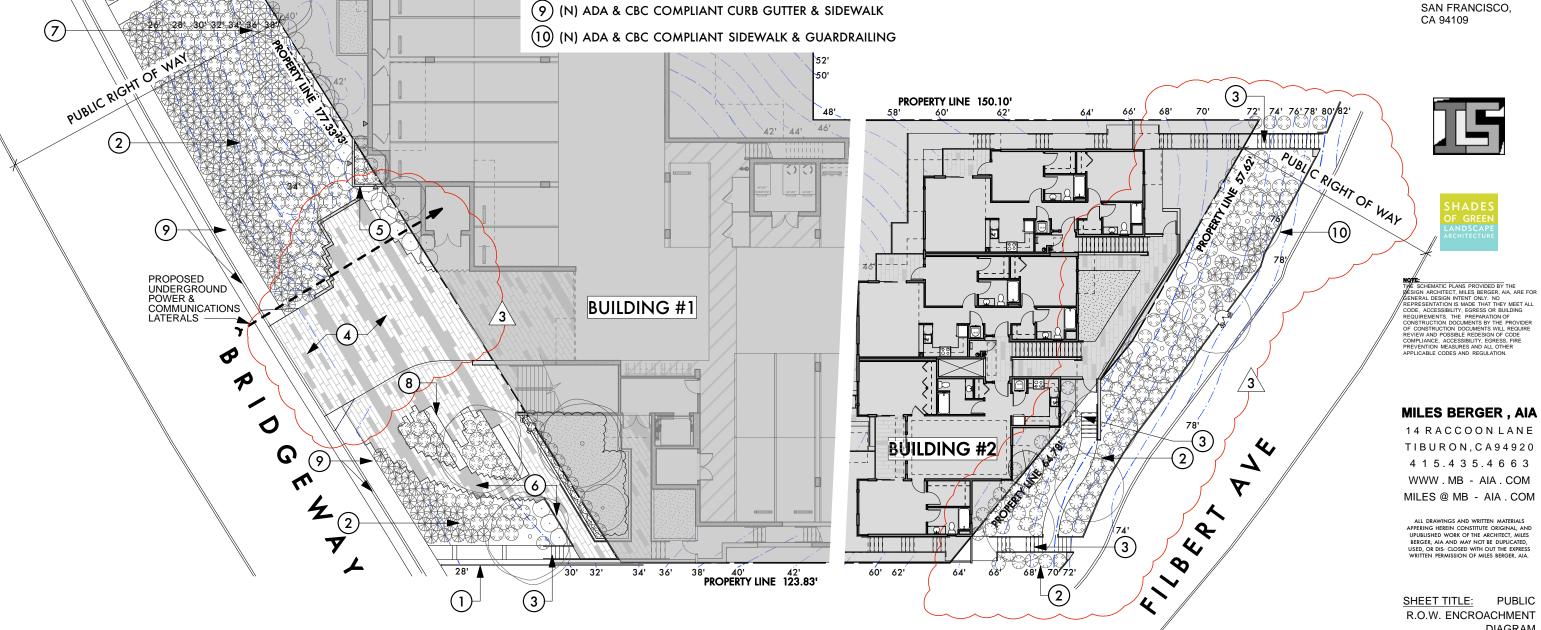

R.O.W AT GARAGE LEVEL

SHEET TITLE: R.O.W. ENCROACHMENT

DIAGRAM

SCALE: DATE:

08.12.15

A5.6a

PUBLIC

NTS

COMMONS

160 FILBERT AVE, 1745 & 1757 BRIDGEWAY SAUSALITO, CA 94920

APN: 0 6 4 - 1 5 1 - 0 2 0 6 4 - 1 5 1 - 0 3

OWNER: SY JARDINES

REQUIRED / PROVIDED PARKING:

LOOKOUT, LLC

OWNERS REP: MEL LEE

1035 VAN NESS SAN FRANCISCO. CA 94109





NOTE:
THE SCHEMATIC PLANS PROVIDED BY THE
DESIGN ARCHITECT, MILES BERGER, AIA, ARE FOR
GENERAL DESIGN INTENT ONLY. NO
CONSTRUCTION DOCUMENTS WILL REQUIRE
FOR DESIGN OF CODE
COMPLIANCE, ACCESSIBILITY, EGRESS, FIRE
PREVENT AND MEASURES AND ALL OTHER
APPLICABLE CODES AND REGULATION.

MILES BERGER, AIA

14 RACCOON LANE TIBURON, CA94920 4 1 5 . 4 3 5 . 4 6 6 3 WWW . MB - AIA . COM MILES @ MB - AIA . COM


SHEET TITLEOFF STREET PARKING & ACCESS DIAGRAM

SCALE:

DATE:

A5.6b


NTS 07.06.15

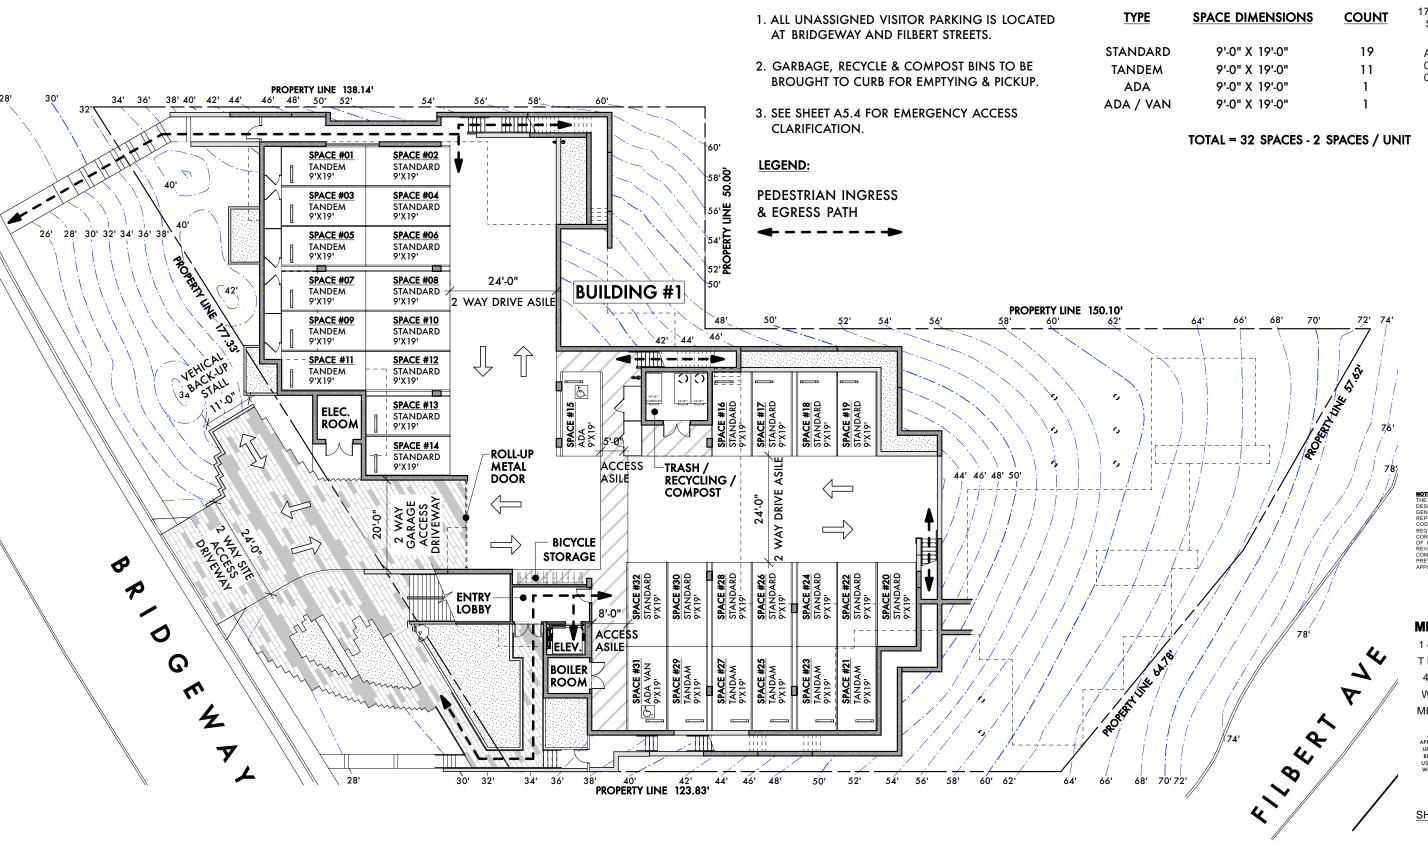

OFF STREET PARKING & ACCESS NOTES:

COMMONS

160 FILBERT AVE, 1745 & 1757 BRIDGEWAY SAUSALITO, CA 94920

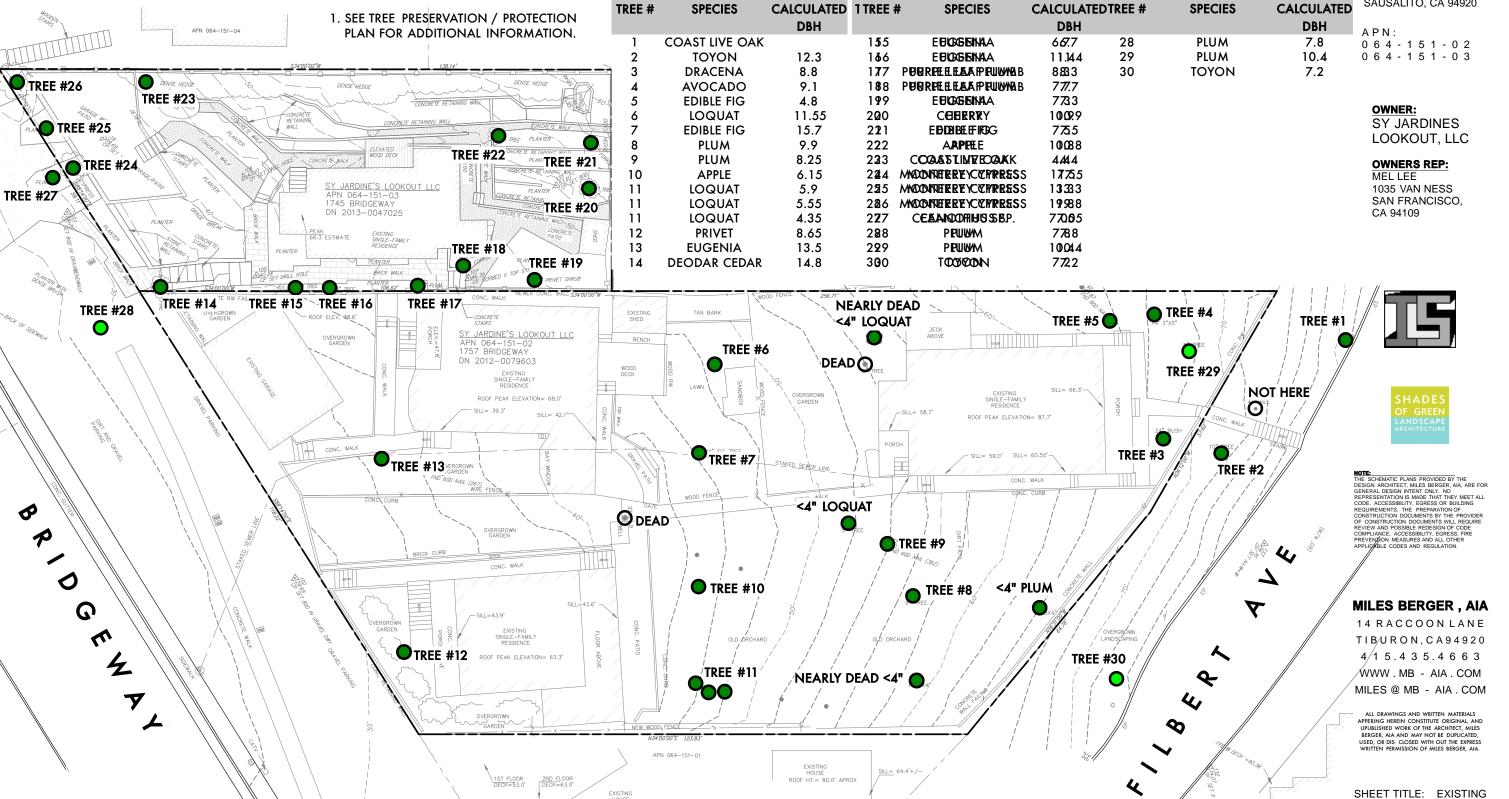

EXISTING TREE SURVEY:

EXISTING TREE NOTES:

HEET TITLE: EXISTING TREE


DIAGRAM SCALE: NTS

DATE:

07.06.15 **A5.6c**



CLEAR WESTERN RED CEDAR W/ CLEAR STAIN - SEALER WOOD SLAT PRIVACY FENCE

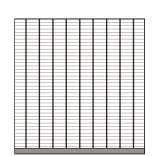


DARK GRAY / BROWN POWDER COATED STEEL FRAME, BARS & HARDWARE ROLL-UP METAL GARAGE GATE & RESIDENT **ENTRY / SECURITY GATES**



BENJAMIN MOORE #228 'SHAKESPEARE TAN' OR SIM

WOOD (FIBER CEMENT) SHINGLES - PAINTED

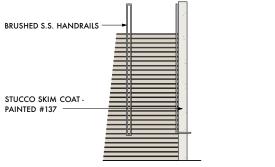

INTEGRAL COLOR CONCRETE TREADS & RISERS -CHROMIX #5130 'SPRING BEIGE' OR SIM MONUMENTAL ENTRY STAIR W/ COLORED CONCRETE




FINISH BY MANUFACTURER DARK BRONZE ANODIZED FINISH @

WINDOWS, DOORS & SUN SHADES



BENJAMIN MOORE #984 'STONE HEARTH' OR SIM

STUCCO SKIM COAT @ PLANTERS - PAINTED

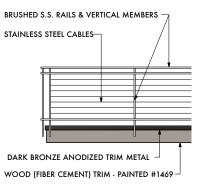

BRUSHED STAINLESS STEEL CABLE GUARDRAILS



BENJAMIN MOORE #1469 'EAGLE ROCK' OR SIM



WOOD (FIBER CEMENT) SIDING - PAINTED



BENJAMIN MOORE #137 'SEBRING WHITE' OR SIM

STUCCO SKIM COAT @ CONCRETE WALLS -PAINTED

BRIDGEWAY

160 FILBERT AVE, 1745 & 1757 BRIDGEWAY S A U S A L I T O C A 9 4 9 6 5

0 6 4 - 1 5 1 - 0 2 0 6 4 - 1 5 1 - 0 3

OWNER:

SY JARDINES LOOKOUT, LLC

OWNERS REP:

MEL LEE 1035 VAN NESS SAN FRANCISCO, CA 94109





MILES BERGER , AIA


14 RACCOON LANE TIBURON, CA 94920 415.435.4663 WWW.MB - AIA.COM MILES@MB - AIA.COM


SHEET TITLE:


COLORS & MATERIALS

SCALE: NTS SV DRAWN BY: 1302 PROJECT No.:

DATE: 07.06.15 A6.1

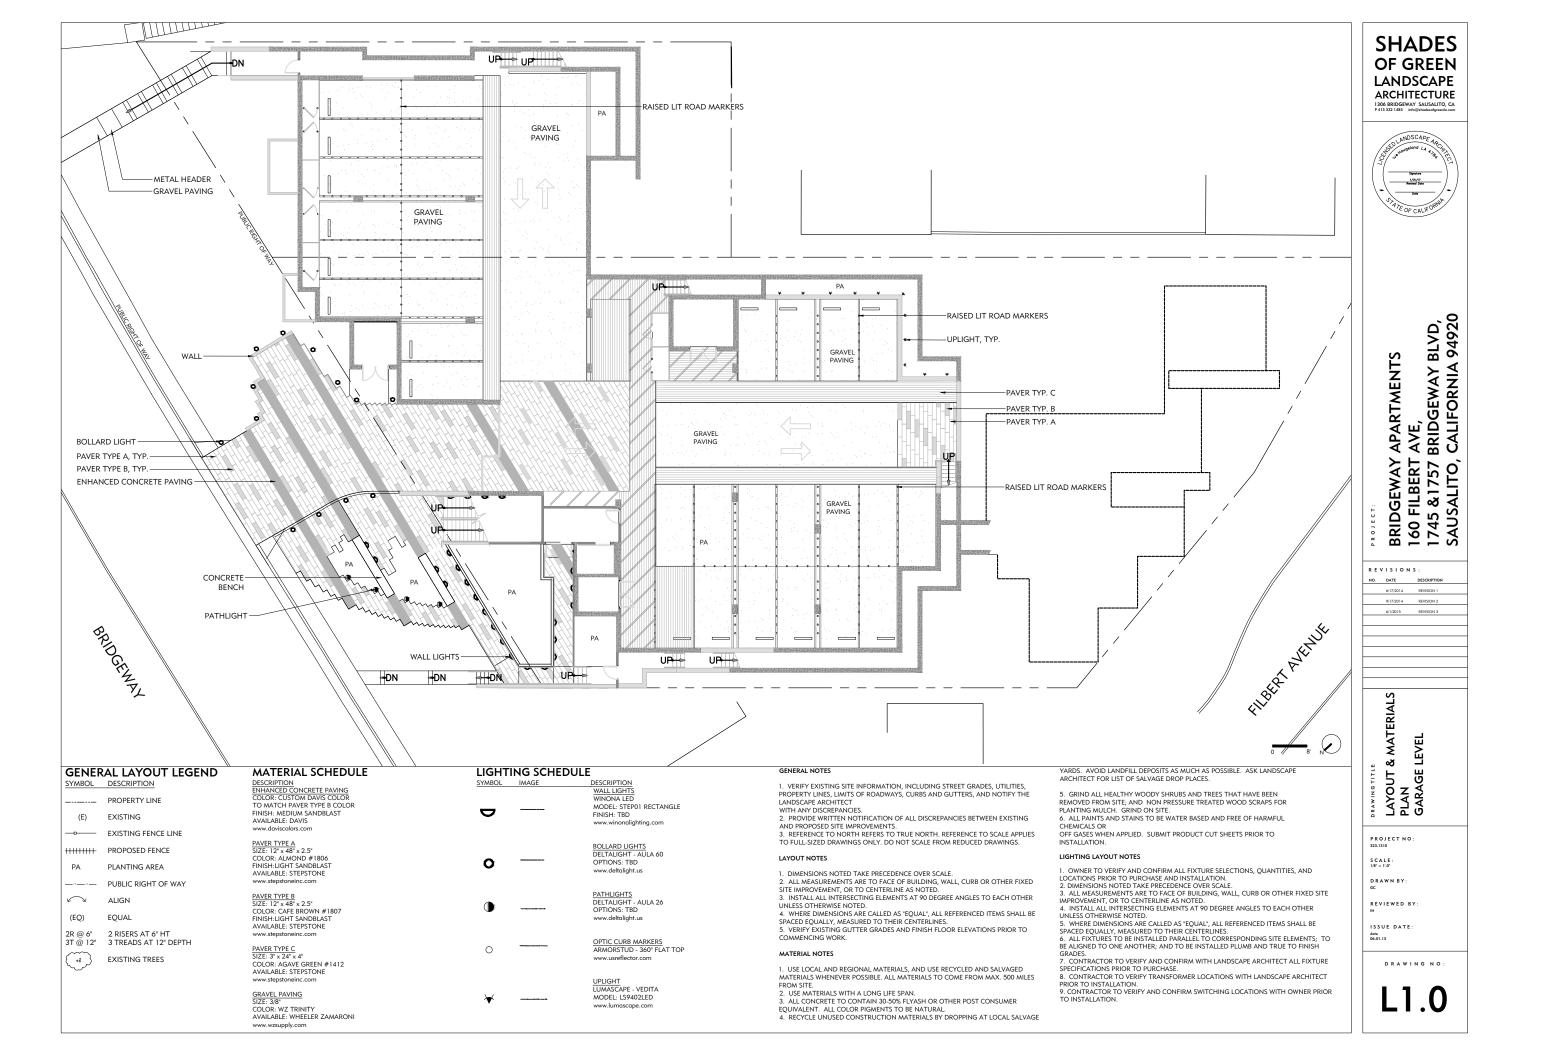

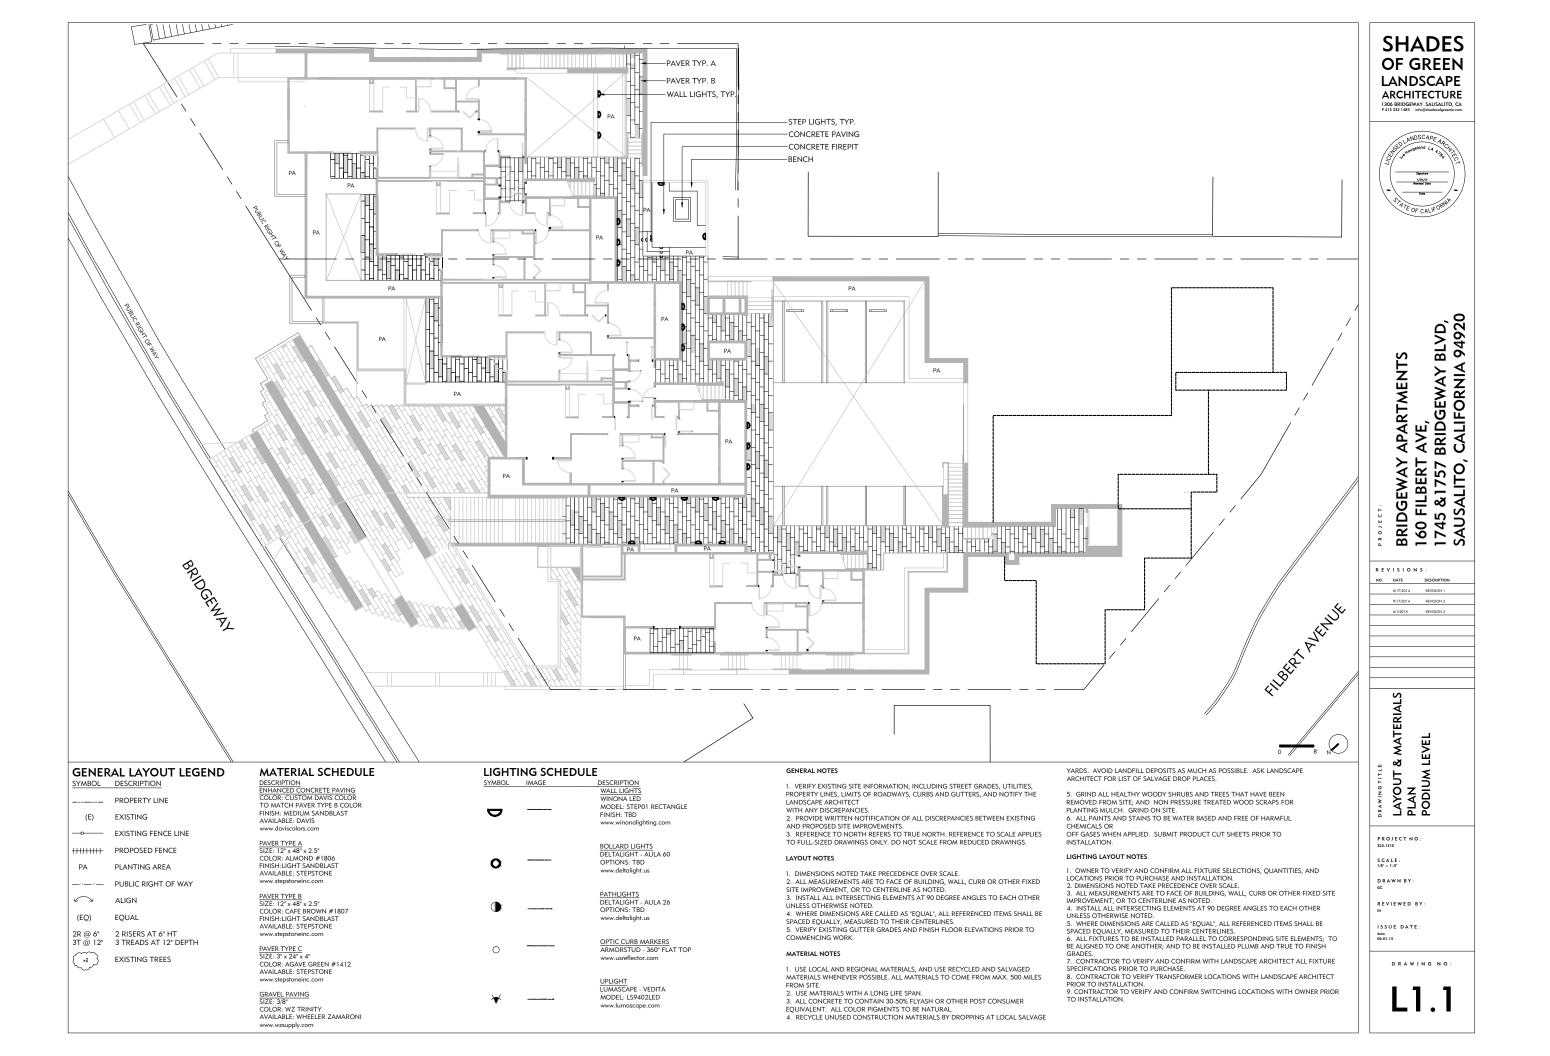

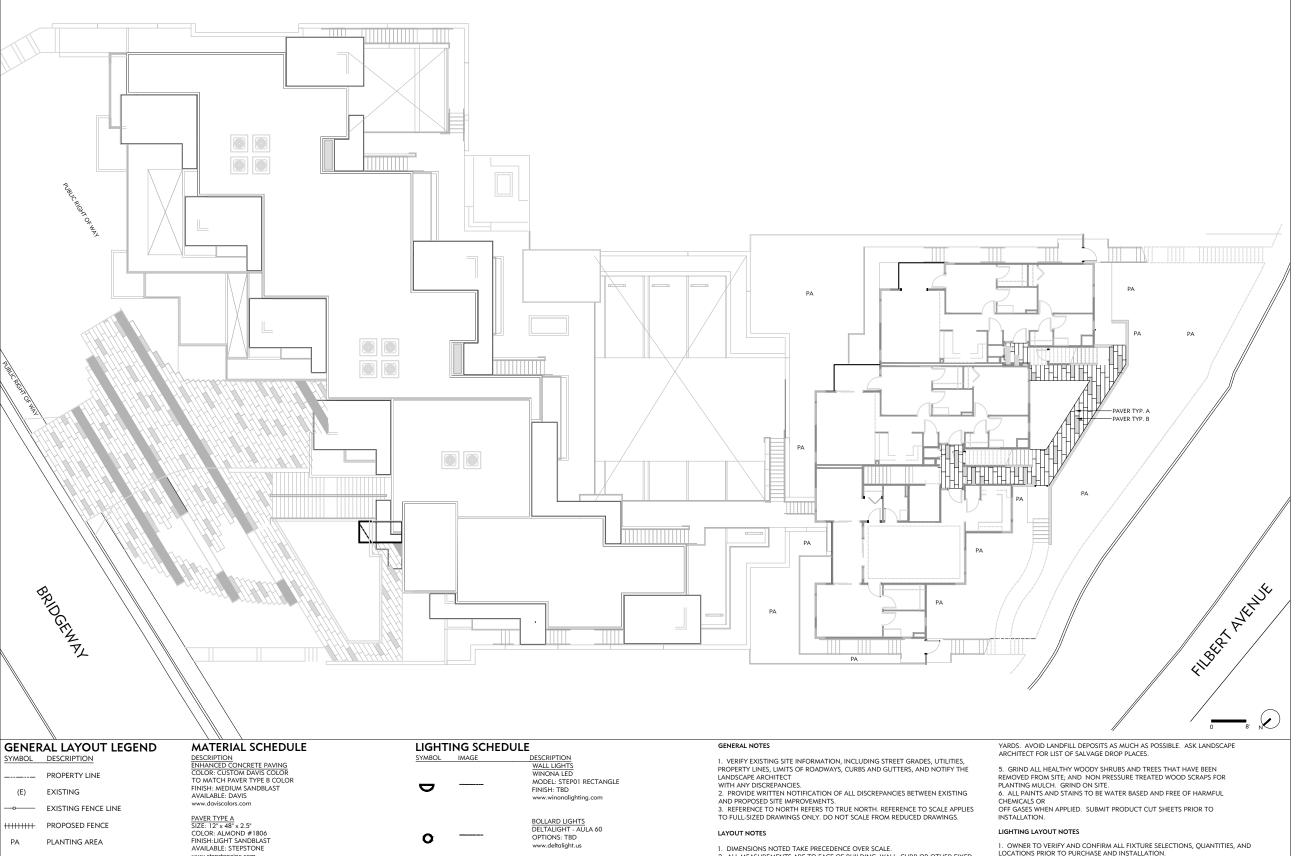

OPTIONS: TBD www.deltalight.us

www.deltalight.us

PATHLIGHTS
DELTALIGHT - AULA 26
OPTIONS: TBD

<u>UPLIGHT</u> LUMASCAPE - VEDITA

MODEL: LS9402LED

www.lumascape.com

OPTIC CURB MARKERS ARMORSTUD - 360° FLAT TOP www.usreflector.com

PA

(EQ)

٠٠]

PLANTING AREA

2 RISERS AT 6" HT

EXISTING TREES

3 TREADS AT 12" DEPTH

ALIGN

EOUAL

PUBLIC RIGHT OF WAY

PAVER TYPE B SIZE: 12" x 48" x 2.5" COLOR: CAFE BROWN #1807 FINISH:LIGHT SANDBLAST AVAILABLE: STEPSTONE

PAVER TYPE C SIZE: 3" x 24" x 4" COLOR: AGAVE GREEN #1412 AVAILABLE: STEPSTONE

COLOR: WZ TRINITY AVAILABLE: WHEELER ZAMARONI

GRAVEL PAVING SIZE: 3/8"

www.wzsupply.com

LAYOUT NOTES

1. DIMENSIONS NOTED TAKE PRECEDENCE OVER SCALE.

FROM SITE.

2. USE MATERIALS WITH A LONG LIFE SPAN.

2. ALL MEASUREMENTS ARE TO FACE OF BUILDING, WALL, CURB OR OTHER FIXED

2. ALE MICROSCHINT SACTORIC OF THE CONTROL OF STREET MALE, CORD OR OTHER TIMES SITE IMPROVEMENT, OR TO CENTERLINE AS NOTED.

3. INSTALL ALL INTERSECTING ELEMENTS AT 90 DEGREE ANGLES TO EACH OTHER UNLESS OTHERWISE NOTED.

4. WHERE DIMENSIONS ARE CALLED AS "EQUAL". ALL REFERENCED ITEMS SHALL BE

5. VERIFY EXISTING GUTTER GRADES AND FINISH FLOOR ELEVATIONS PRIOR TO COMMENCING WORK.

1. USE LOCAL AND REGIONAL MATERIALS, AND USE RECYCLED AND SALVAGED

3. ALL CONCRETE TO CONTAIN 30-50% FLYASH OR OTHER POST CONSUMER

MATERIALS WHENEVER POSSIBLE. ALL MATERIALS TO COME FROM MAX. 500 MILES

EQUIVALENT. ALL COLOR PIGMENTS TO BE NATURAL.
4. RECYCLE UNUSED CONSTRUCTION MATERIALS BY DROPPING AT LOCAL SALVAGE

OF GREEN LANDSCAPE **ARCHITECTURE**

SHADES



BRIDGEWAY APARTMENTS 160 FILBERT AVE, 1745 &1757 BRIDGEWAY BLVD, SAUSALITO, CALIFORNIA 94920

& MATERIALS LAYOUT & MATE PLAN FOURTH LEVEL

R E V I S I O N S : 6/17/2014 REVISION 1 9/17/2014 REVISION 2 6/1/2015 REVISION 3

PROJECT NO: S C A L E : DRAWN BY: REVIEWED BY

LIGHTING LAYOUT NOTES

1. OWNER TO VERIFY AND CONFIRM ALL FIXTURE SELECTIONS, QUANTITIES, AND

2. DIMENSIONS NOT LED TAKE PRECEDENCE OVER SCALE.
3. ALL MEASUREMENTS ARE TO FACE OF BUILDING, WALL, CURB OR OTHER FIXED SITE IMPROVEMENT, OR TO CENTERLINE AS NOTED.
4. INSTALL ALL INTERSECTING ELEMENTS AT 90 DEGREE ANGLES TO EACH OTHER UNLESS OTHERWISE NOTED.
5. WHERE DIMENSIONS ARE CALLED AS "EQUAL", ALL REFERENCED ITEMS SHALL BE

5. WHERE DIMENSIONS ARE CALLED AS "EQUAL", ALL REFERENCED HEMS SHALL BE SPACED EQUALLY, MEASURED TO THEIR CENTERLINES.

6. ALL FIXTURES TO BE INSTALLED PARALLEL TO CORRESPONDING SITE ELEMENTS; TO BE ALIGNED TO ONE ANOTHER; AND TO BE INSTALLED PLUMB AND TRUE TO FINISH GRADES.

7. CONTRACTOR TO VERIFY AND CONFIRM WITH LANDSCAPE ARCHITECT ALL FIXTURE SPECIFICATIONS PRIOR TO PURCHASE.

8. CONTRACTOR TO VERIFY TRANSFORMER LOCATIONS WITH LANDSCAPE ARCHITECT


9. CONTRACTOR TO VERIFY AND CONFIRM SWITCHING LOCATIONS WITH OWNER PRIOR


LOCATIONS PRIOR TO PURCHASE AND INSTALLATION.


2. DIMENSIONS NOTED TAKE PRECEDENCE OVER SCALE


ISSUE DATE date 06-01-15

DRAWING NO

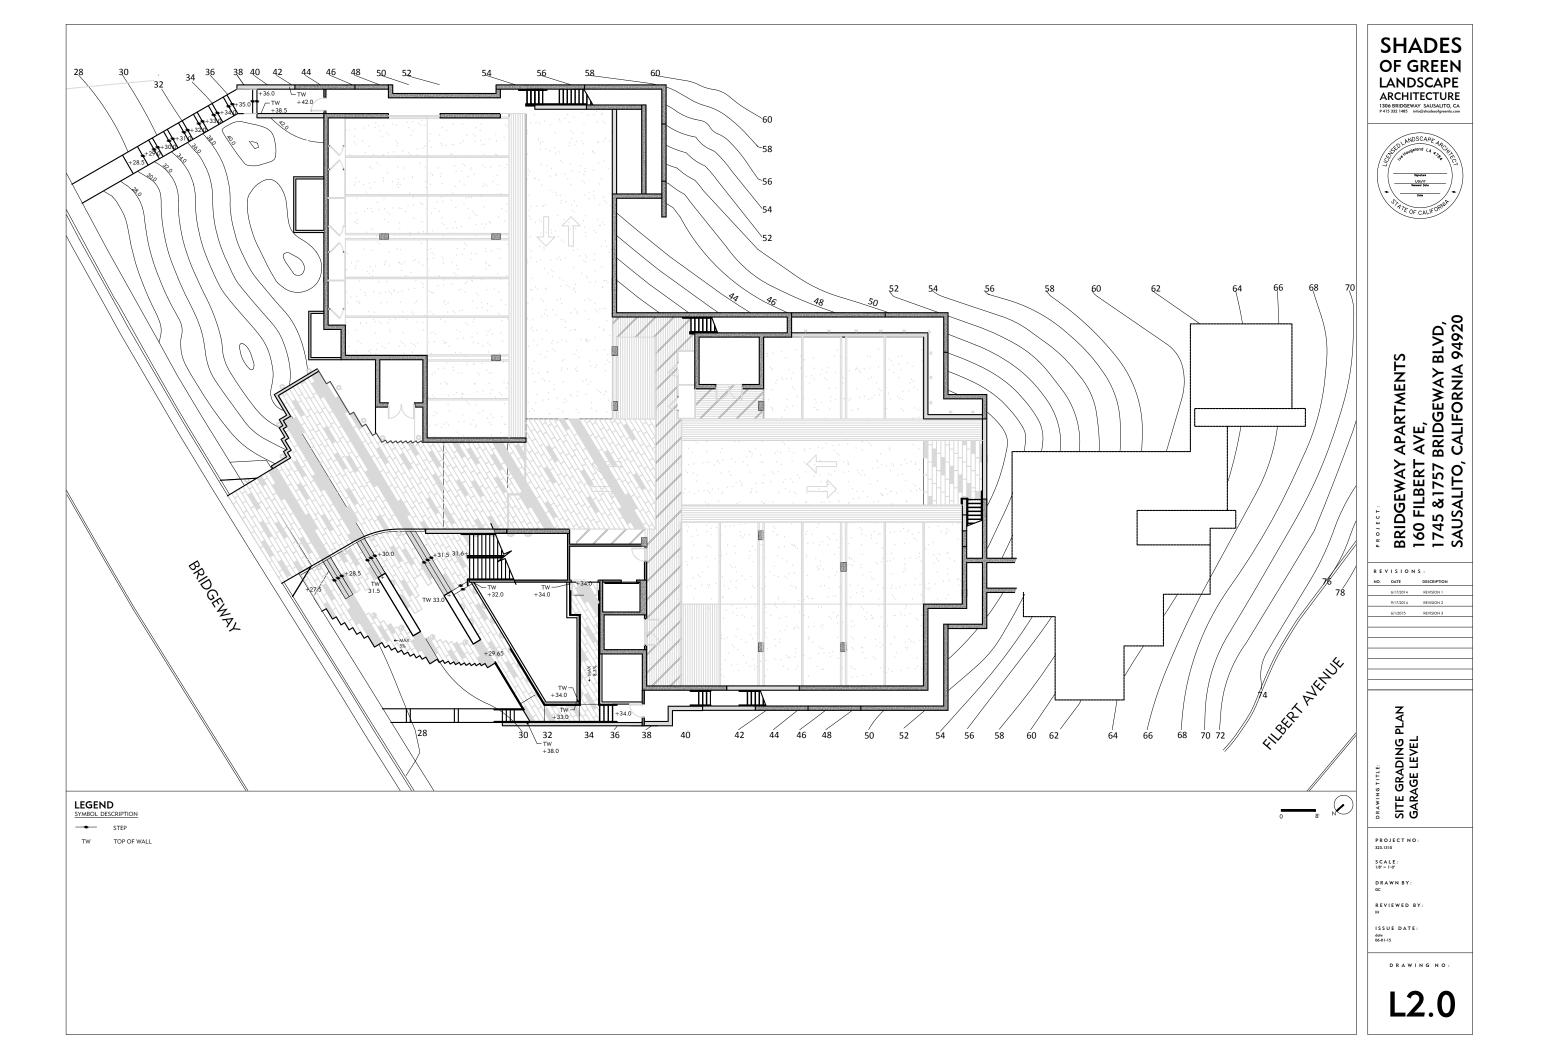

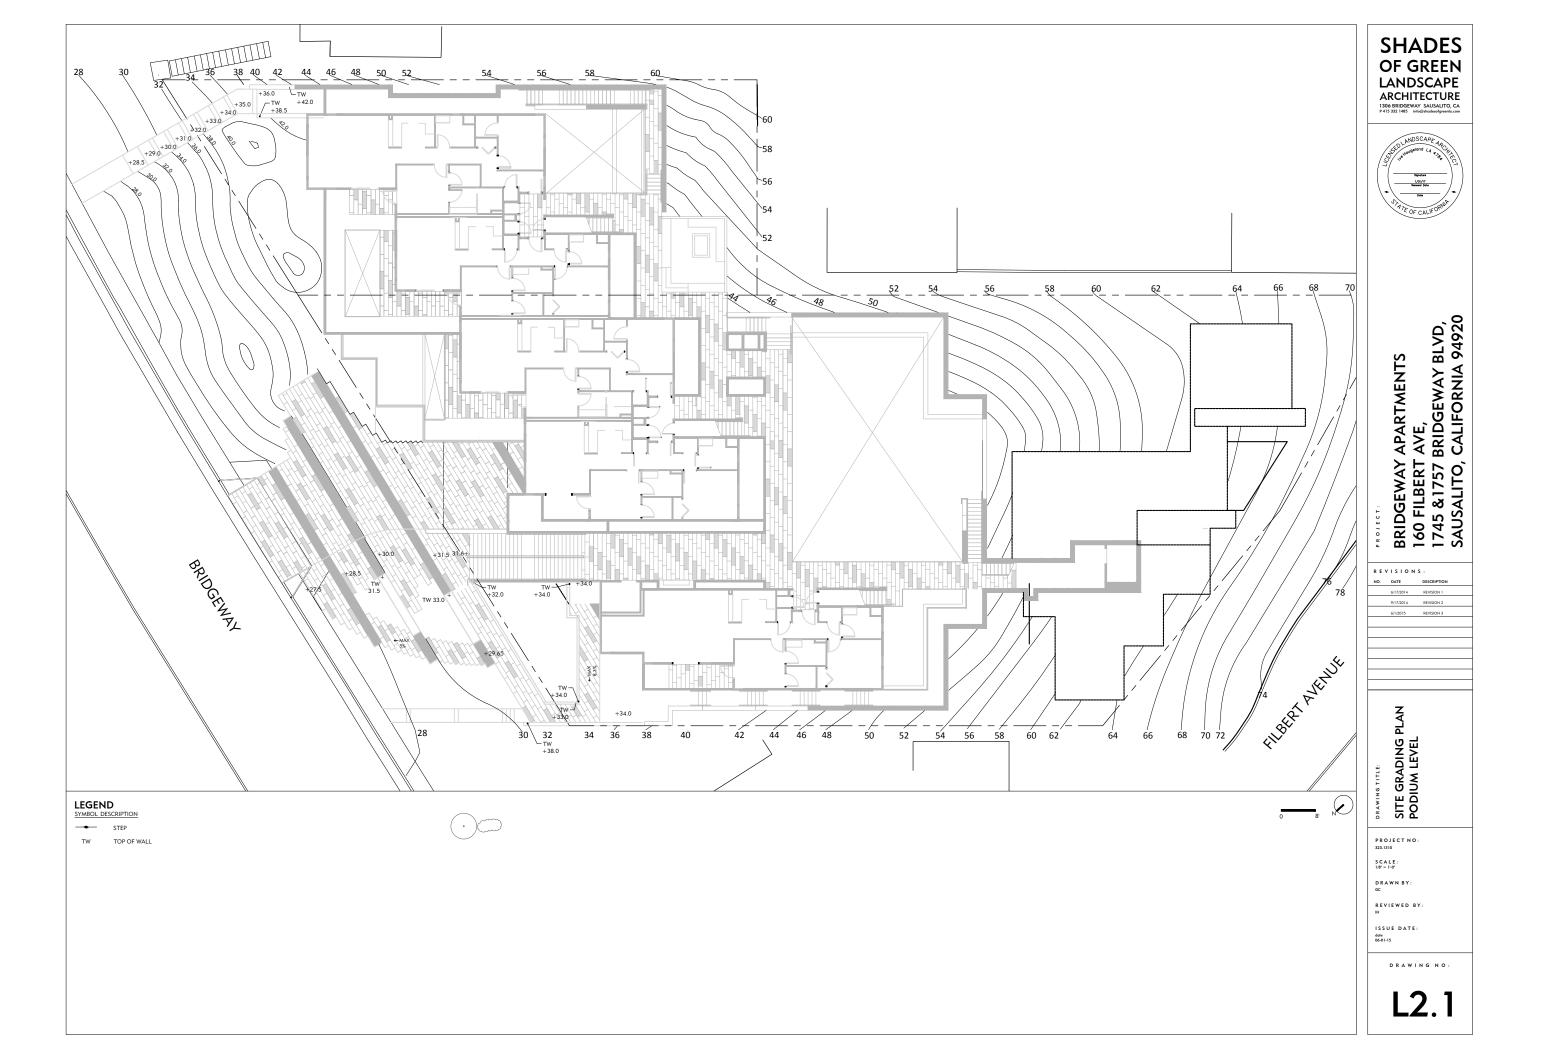

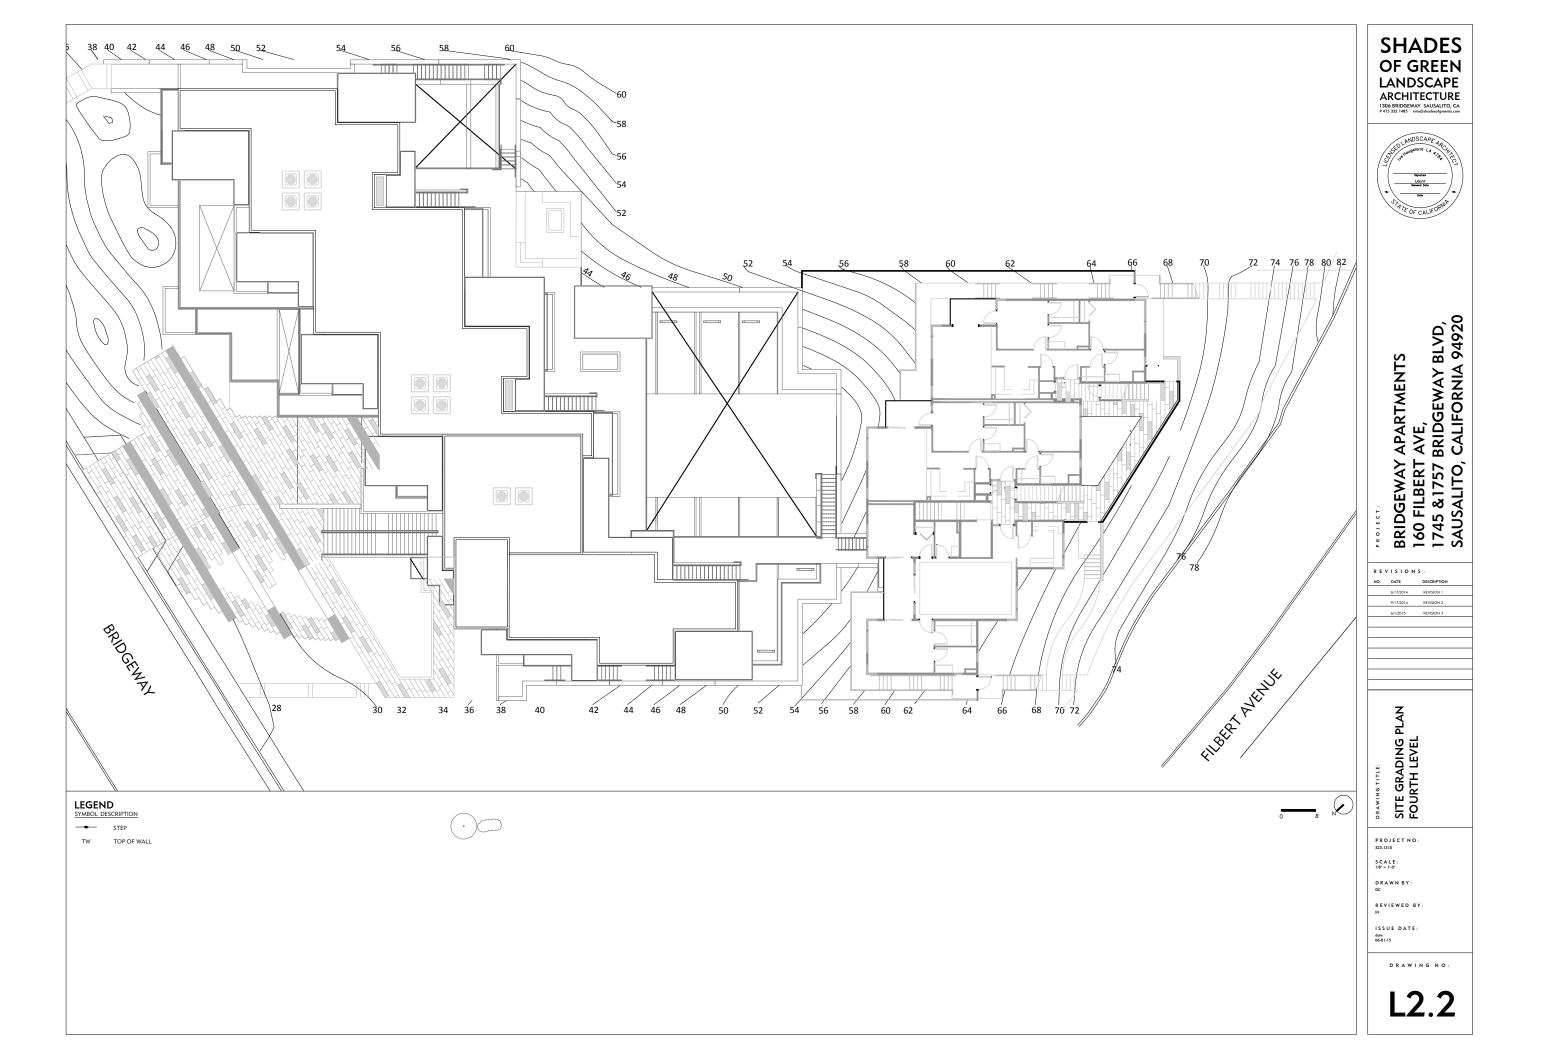

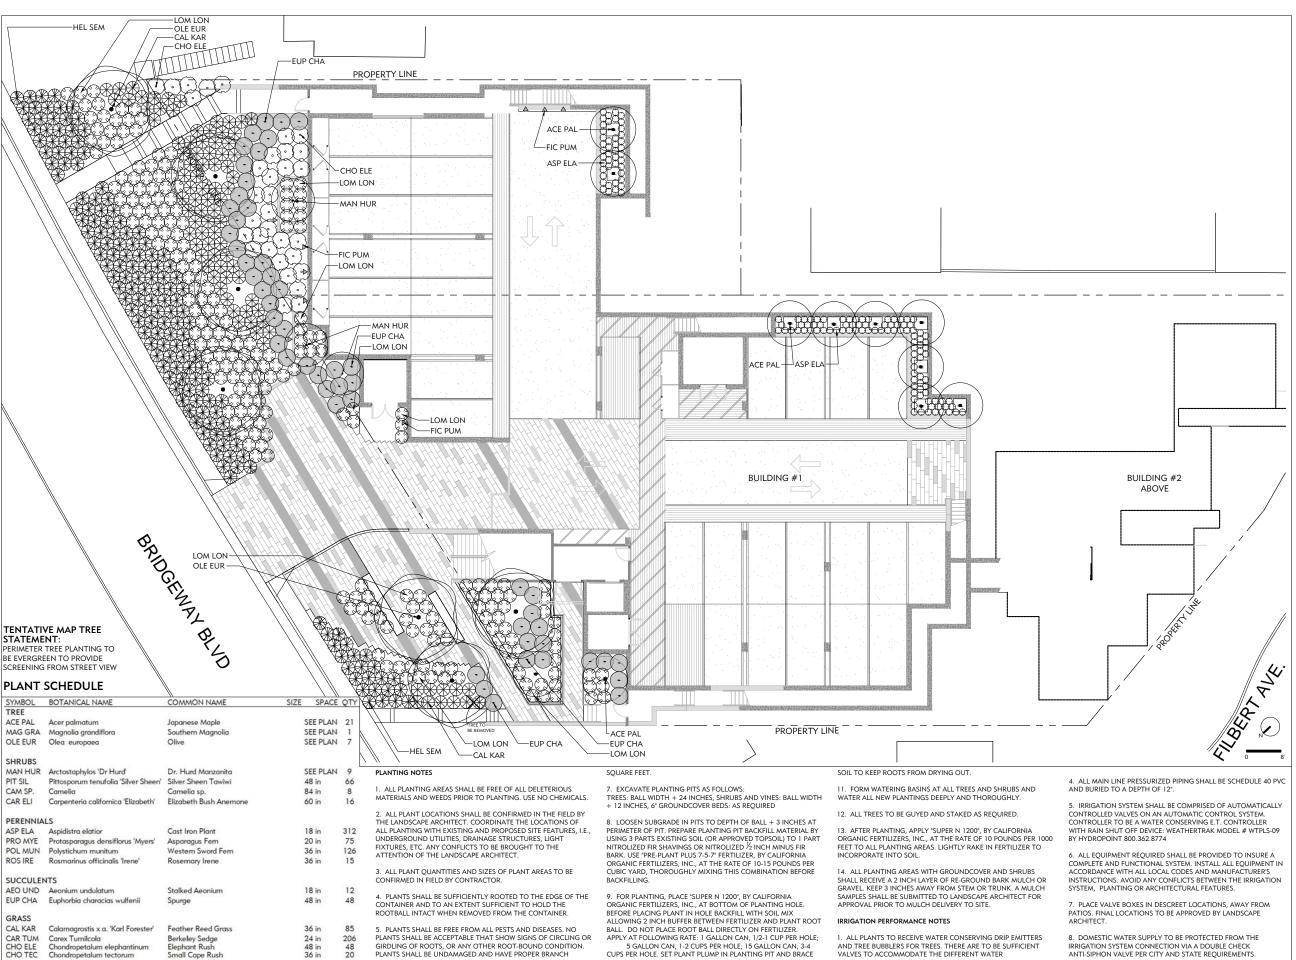

5 GALLON CAN, 1-2 CUPS PER HOLE; 15 GALLON CAN, 3-4
CUPS PER HOLE. SET PLANT PLUMP IN PLANTING PIT AND BRACE

RIGIDLY IN POSITION, TAMPING BACKELL MIX SOLIDLY AROUND

THE BALL AND ROOTS, UNTIL PITS ARE APPROXIMATELY 3/2 FULL.

WATER THOROUGHLY, SATURATING ROOTBALL, ADD REMAINING

BACKFILL MIX TO TOP OF HOLE, ELIMINATING ALL AIR POCKETS

10. ALL PLANTS SENSITIVE TO WATER BORNE FUNGI SHALL BE

PLACED 3 INCHES ABOVE FINISHED GRADE. ALL OTHER PLANTS SHALL BE PLANTED 1 INCH ABOVE FINISHED GRADE. MOUND UP

GIRDLING OF ROOTS, OR ANY OTHER ROOT-BOUND CONDITION.

6. ALL PLANTING AREAS TO BE TILLED SO THAT THE SOIL IS LOOSE

AND NOT COMPACTED. TO PREPARE PLANTING BEDS, CULTIVATE INTO TOP 8 INCHES OF SOIL, 6 CUBIC YARDS OF NITROLIZED

PLANTS SHALL BE UNDAMAGED AND HAVE PROPER BRANCH

REDWOOD SAWDUST PER 1000 SOUARE FEET, 10 LBS HIGH QUALITY COMPOST PER CUBIC YARD, AND SPREAD "PRE-PLANT PLUS 7-5-7" FERTILIZER AT THE RATE OF 20 POUNDS PER 1000

48 in 36 in

24 in 36 in

36 in

24 in

SEE PLAN 23

70 219 482

74

CHO ELE

FES CAL

HEL SEM

LOM LON

OPH PLA

FIC PUM Ficus Pumila

VINE

Chondropetalum elephantinum Chondropetalum tectorum

Lomandra longifolia 'Breeze' PP

Ophiopogon planiscapus 'Nigrescens Black Mondo Grass

Festuca californica

Heliotrichon se

Small Cape Rush

Calironia Fescue

Blue Oat Grass Dwarf Mat Rush

Creeping fig

AND TREE BUBBLERS FOR TREES. THERE ARE TO BE SUFFICIENT VALVES TO ACCOMMODATE THE DIFFERENT WATER

REQUIREMENTS FOR PLANTS WITH DIFFERENT EXPOSURES AND

2. DRIP SYSTEM TO BE INSTALLED WITH A PRESSURE-REDUCING

3. DRIP EMITTERS TO BE OF THE PRESSURE COMPENSATING TYPE.

SHADES OF GREEN LANDSCAPE ARCHITECTURE



Y APARTMENTS T AVE, 7 BRIDGEWAY BLVD, 9, CALIFORNIA 94920

BRIDGEWAY / 160 FILBERT / 1745 &1757 E SAUSALITO, (

REVISIONS: NO. DATE DESCRI 6/17/2014 REVISION I 9/17/2014 REVISION 2 6/1/2015 REVISION

PLANTING PLAN GARAGE LEVEL

PROJECT NO

S C A L E :

DRAWN BY:

REVIEWED BY

ISSUE DATE:

DRAWING NO:


L3.0

VISUALLY INSPECT MAINLINE FOR LEAKS UNDER FULL OPERATING 10. LAWN WILL BE WATERED WITH SPRINKLERS. USE WATER SAVING MP ROTATOR SPRINKLERS.

IRRIGATION SYSTEM CONNECTION VIA A DOUBLE CHECK
ANTI-SIPHON VALVE PER CITY AND STATE REQUIREMENTS.

9. FLUSH MAINLINES BEFORE INSTALLING REMOTE CONTROL

VALVES. FLUSH LATERAL LINES BEFORE INSTALLING DRIP VALVES.

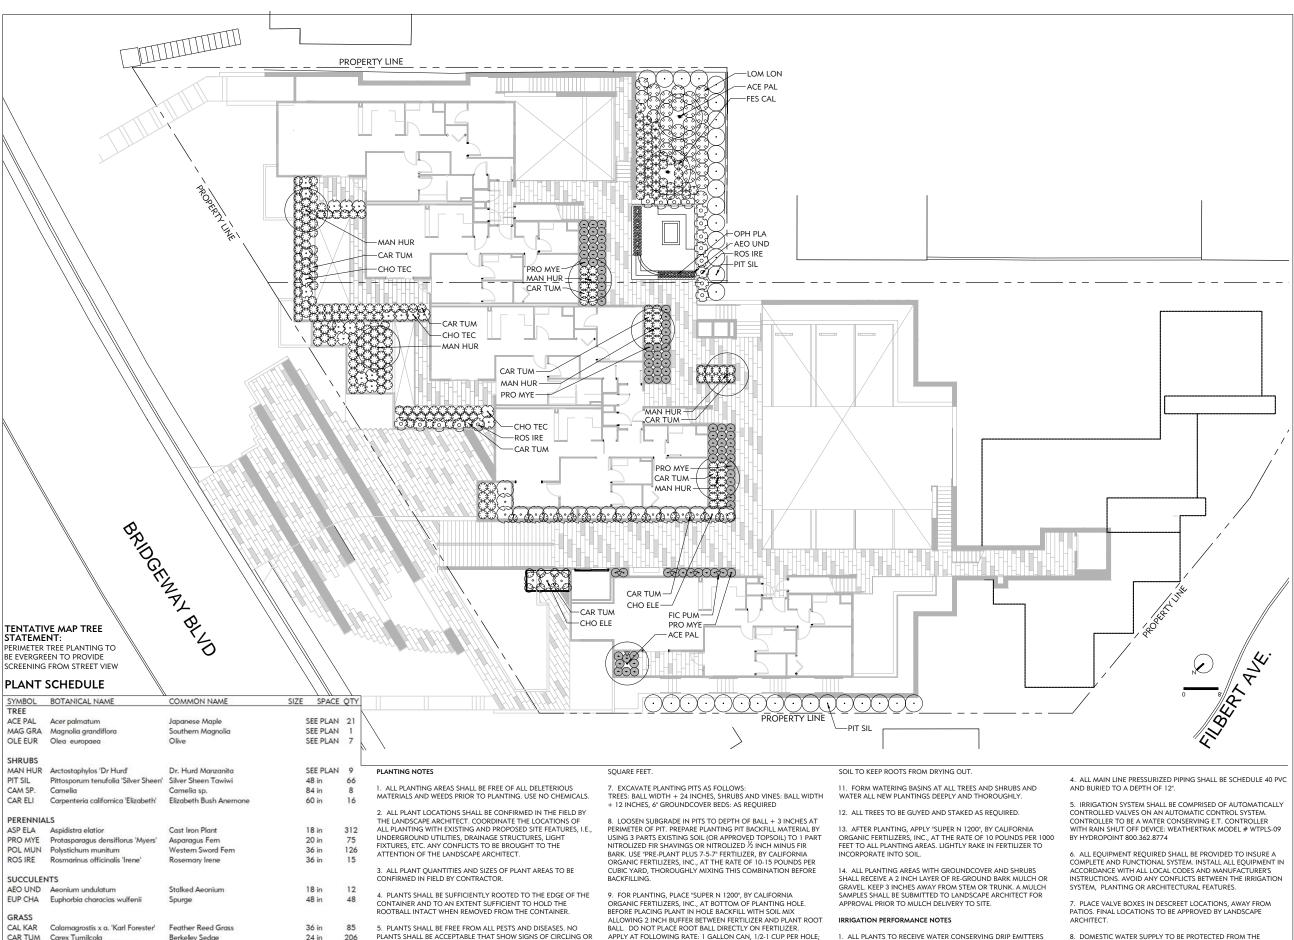

5 GALLON CAN, 1-2 CUPS PER HOLE: 15 GALLON CAN, 3-4

CUPS PER HOLE. SET PLANT PLUMP IN PLANTING PIT AND BRACE RIGIDLY IN POSITION, TAMPING BACKFILL MIX SOLIDLY AROUND

THE BALL AND ROOTS LINTIL PITS ARE APPROXIMATELY 3/4 FULL

WATER THOROUGHLY, SATURATING ROOTBALL. ADD REMAINING
BACKFILL MIX TO TOP OF HOLE, ELIMINATING ALL AIR POCKETS.

10. ALL PLANTS SENSITIVE TO WATER BORNE FUNGI SHALL BE PLACED 3 INCHES ABOVE FINISHED GRADE, ALL OTHER PLANTS

SHALL BE PLANTED 1 INCH ABOVE FINISHED GRADE. MOUND UP

Berkeley Sedge Elephant Rush

Small Cape Rush

Calironia Fescue

Blue Oat Grass

Dwarf Mat Rush

Creeping fig

24 in

36 in

24 in 36 in

36 in

24 in

SEE PLAN 23

206

48 20

70 219 482

74

GIRDLING OF ROOTS OR ANY OTHER ROOT-BOLIND CONDITION

. ALL PLANTING AREAS TO BE TILLED SO THAT THE SOIL IS LOOSE

AND NOT COMPACTED. TO PREPARE PLANTING BEDS, CULTIVATE

PLANTS SHALL BE UNDAMAGED AND HAVE PROPER BRANCH

INTO TOP 8 INCHES OF SOIL, 6 CUBIC YARDS OF NITROLIZED

OUALITY COMPOST PER CUBIC YARD, AND SPREAD "PRE-PLANT PLUS 7-5-7" FERTILIZER AT THE RATE OF 20 POUNDS PER 1000

REDWOOD SAWDUST PER 1000 SQUARE FEET, 10 LBS HIGH

CAR TUM

CHO ELE CHO TEC

FES CAL HEL SEM

LOMLON

OPH PLA

FIC PUM Ficus Pumila

Carex Tumilcola

Festuca californica

Heliotrichon sempervin

Chondropetalum elephantinum

Lomandra longifolia 'Breeze' PP

Ophiopogon planiscapus 'Nigrescens Black Mondo Grass

Chondropetalum tectorum

. ALL PLANTS TO RECEIVE WATER CONSERVING DRIP EMITTERS

AND TREE BUBBLERS FOR TREES, THERE ARE TO BE SUFFICIENT

VALVES TO ACCOMMODATE THE DIFFERENT WATER
REQUIREMENTS FOR PLANTS WITH DIFFERENT EXPOSURES AND

2. DRIP SYSTEM TO BE INSTALLED WITH A PRESSURE-REDUCING

3. DRIP EMITTERS TO BE OF THE PRESSURE COMPENSATING TYPE.

PLANT TYPES

SHADES OF GREEN LANDSCAPE ARCHITECTURE



Y APARTMENTS T AVE, 7 BRIDGEWAY BLVD, 9, CALIFORNIA 94920 BRIDGEWAY / 160 FILBERT / 1745 &1757 B SAUSALITO, (

REVISIONS: NO. DATE 6/17/2014 REYNSION I 9/17/2014 REVISION 2 6/1/2015

PLANTING PLAN PODIUM LEVEL

PROJECT NO

S C A L E :

DRAWN BY

REVIEWED BY

ISSUE DATE

8. DOMESTIC WATER SUPPLY TO BE PROTECTED FROM THE

9 FLUSH MAINLINES REFORE INSTALLING REMOTE CONTROL

10. LAWN WILL BE WATERED WITH SPRINKLERS. USE WATER

VALVES. FLUSH LATERAL LINES BEFORE INSTALLING DRIP VALVES.
VISUALLY INSPECT MAINLINE FOR LEAKS UNDER FULL OPERATING


IRRIGATION SYSTEM CONNECTION VIA A DOUBLE CHECK

PRESSURE BEFORE BACKFILLING.

SAVING MP ROTATOR SPRINKLERS.

DRAWING NO

L3.1

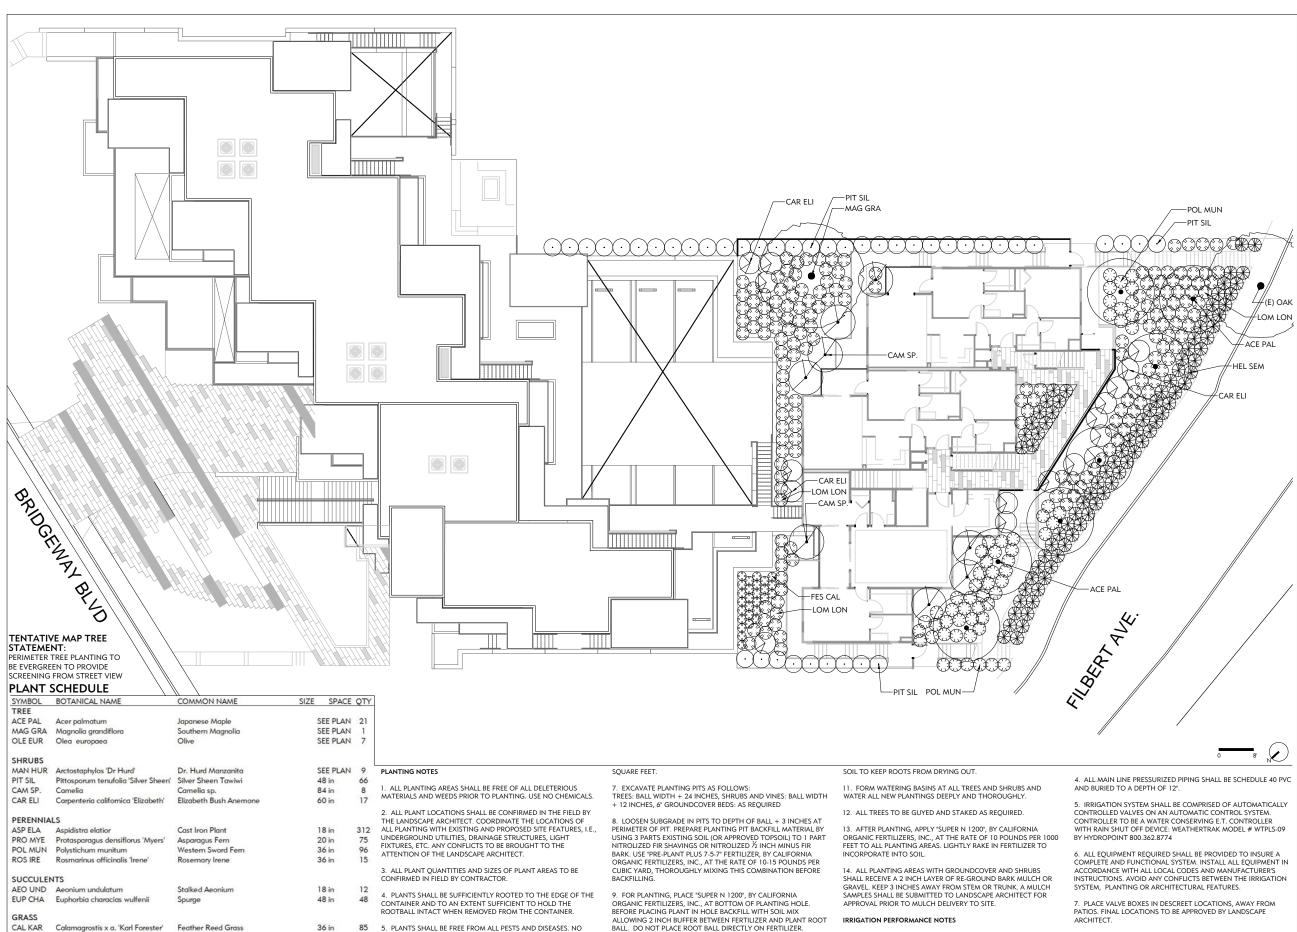

APPLY AT FOLLOWING RATE: 1 GALLON CAN 1/2-1 CUP PER HOLE:

5 GALLON CAN, 1-2 CUPS PER HOLE; 15 GALLON CAN, 3-4
CUPS PER HOLE. SET PLANT PLUMP IN PLANTING PIT AND BRACE

RIGIDLY IN POSITION, TAMPING BACKFILL MIX SOLIDLY AROUND

THE BALL AND ROOTS, UNTIL PITS ARE APPROXIMATELY % FULL. WATER THOROUGHLY, SATURATING ROOTBALL. ADD REMAINING

BACKFILL MIX TO TOP OF HOLE, ELIMINATING ALL AIR POCKETS.

10. ALL PLANTS SENSITIVE TO WATER BORNE FUNGI SHALL BE

PLACED 3 INCHES ABOVE FINISHED GRADE ALL OTHER PLANTS

SHALL BE PLANTED 1 INCH ABOVE FINISHED GRADE. MOUND UP

CAR TUM CHO ELE CHO TEC

FES CAL

HEI SEM

LOM LON

OPH PLA

FIC PUM Ficus Pumila

VINE

Carex Tumilcola

Festuca californica

Chondropetalum elephantinum Chondropetalum tectorum

Lomandra longifolia 'Breeze' PP

Ophiopogon planiscapus 'Nigrescens Black Mondo Grass

24 in 48 in 36 in

24 in 36 in 36 in

24 in

206 48 20

70 237 492

74

PLANTS SHALL BE ACCEPTABLE THAT SHOW SIGNS OF CIRCLING OR GIRDLING OF ROOTS, OR ANY OTHER ROOT-BOUND CONDITION.

6. ALL PLANTING AREAS TO BE TILLED SO THAT THE SOIL IS LOOSE

AND NOT COMPACTED. TO PREPARE PLANTING BEDS, CULTIVATE INTO TOP 8 INCHES OF SOIL, 6 CUBIC YARDS OF NITROLIZED

PLANTS SHALL BE UNDAMAGED AND HAVE PROPER BRANCH

REDWOOD SAWDUST PER 1000 SOUARE FEET, 10 LBS HIGH

SEE PLAN 23 PLUS 7-5-7" FERTILIZER AT THE RATE OF 20 POUNDS PER 1000

OLIALITY COMPOST PER CLIRIC YARD, AND SPREAD "PRE-PLANT

Berkeley Sedge Elephant Rush

Small Cape Rush

Calironia Fescue

Blue Oat Grass Dwarf Mat Rush

Creeping fig

SHADES OF GREEN LANDSCAPE **ARCHITECTURE**



T AVE, 7 BRIDGEWAY BLVD, 9, CALIFORNIA 94920 **APARTMENTS** BRIDGEWAY , 160 FILBERT , 1745 &1757 E SAUSALITO, (

REVISIONS: NO. DATE 6/17/2014 REVISION

PLANTING PLAN FOURTH LEVEL

PROJECT NO:

S C A L E :

DRAWN BY: REVIEWED BY

ISSUE DATE:

DRAWING NO

L3.2

- 1 ALL PLANTS TO RECEIVE WATER CONSERVING DRIP EMITTERS AND TREE BUBBLERS FOR TREES. THERE ARE TO BE SUFFICIENT VALVES TO ACCOMMODATE THE DIFFERENT WATER
- 2. DRIP SYSTEM TO BE INSTALLED WITH A PRESSURE-REDUCING
- 3. DRIP EMITTERS TO BE OF THE PRESSURE COMPENSATING TYPE.
- REQUIREMENTS FOR PLANTS WITH DIFFERENT EXPOSURES AND


- - 10 LAWN WILL BE WATERED WITH SPRINKLERS, LISE WATER

8 DOMESTIC WATER SUPPLY TO BE PROTECTED FROM THE

IRRIGATION SYSTEM CONNECTION VIA A DOUBLE CHECK
ANTI-SIPHON VALVE PER CITY AND STATE REQUIREMENTS.

9. FLUSH MAINLINES BEFORE INSTALLING REMOTE CONTROL VALVES. FLUSH LATERAL LINES BEFORE INSTALLING DRIP VALVES.

VISUALLY INSPECT MAINLINE FOR LEAKS UNDER FULL OPERATING

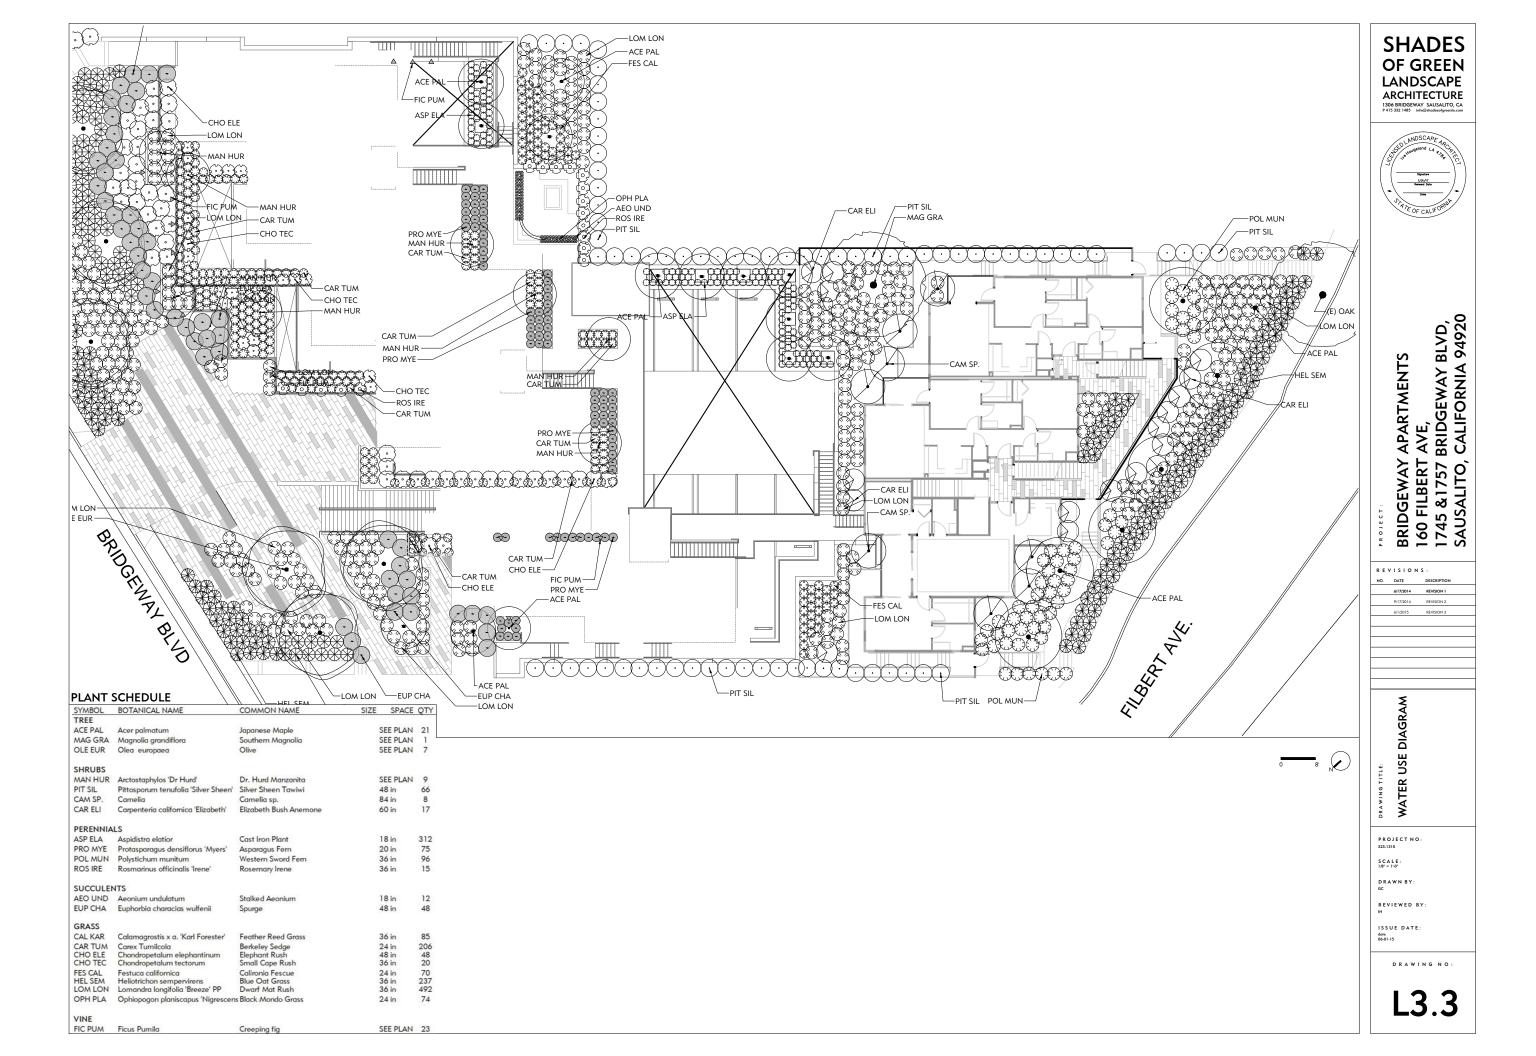

TREES



Japanese Maple Acer palmatum



Magnolia Magnolia grandiflora





PERENNIALS

Olive Olea europaea

SHRUBS



Dr. Hurd Manzanita Arctostaphylos 'Dr. Hurd'



Silver Sheen Tawiwi Pittosporum tenuifolia 'Silver Sheen'



Camelia Camelia sp.



Elizabeth Bush Anemone Carpenteria californica 'Elizabeth'



Cast Iron Plant Aspidistra elatior



Asparagus Fern Protasparagus densiflorus 'Myers'



Western Sword Fern Polystichum minutum



Rosemary Irene Rosmarinus officinalis 'Irene'

GRASSES



Feather Reed Grass Calamagrostis x a. 'Karl Foerster'



Berkeley Sedge Carex tumulicola





California Fescue Festuca californica



Blue Oat Grass Helictotrichon sempervirens



Elephant Rush Chondropetalum elephantinum



Small Cape Rush Chondropetalum tectorum



Dwarf Mat Rush Lomandra longifolia 'Breeze' PP



Black Mondo Grass Ophiopogon planiscapus 'Nigrescens'

SUCCULENTS



Stalked Aeonium Aeonium undulatum



Spurge Euphorbia characias wulfenii

VINE



Climbing Fig Ficus pumila

SHADES OF GREEN LANDSCAPE ARCHITECTURE 1306 BRIDGEWAY SAUSALITO, CA P 415 332 1485 info@hhddesdgwerfa.com



BRIDGEWAY APARTMENTS 160 FILBERT AVE, 1745 &1757 BRIDGEWAY BLVD, SAUSALITO, CALIFORNIA 94920

۵	窗;		ò
REVISIONS:			
NO.	DATE	DESCRIPTION	
	6/17/2014	REVISION 1	
	9/17/2014	REVISION 2	

PLANT IMAGE BOARD

1 '	ROJECT NO: 23-1310
	C A L E :
G	RAWN BY:
R	EVIEWED BY:
6	SSUE DATE: ote 9-17-14

DRAWING NO:

L3.4