## Dunphy Park Improvements Project- 60% Construction Documents

60% CD's, June 20, 2017

The scope of this project is to bring Dunphy Park's parking, storm drainage, electrical, wastewater, lighting and pedestrian facilities into compliance with current codes and standards of practice, constructing permanent restroom facilities, re-arranging the active and passive areas of Dunphy Park to better suit users and neighbors, and providing additional protection of the Park as a resource against the potential for coastal flooding and sea level rise. The design will balance the needs and concerns of adjacent residents and businesses and reflect the needs of the neighborhood and City. Based on the accepted Schematic Master Plan, the principal design elements are expected to include:

- Confirmation of the selection and design of grades, turf, trees and plantings with evaluation of preservation of existing significant trees being included.
- Selection and design of pathways and other surfacing materials.
- · Confirmation of selection and design of retaining walls.
- Amenities such as benches, drinking fountains, bicycle parking, sitting and other
- Treatment of interface between Park and adjacent uses.
- Access considerations.
- Lighting
- Utilities.
- Fencing and screening (including potential noise issues).
- Signage.
- · Maintenance considerations.

#### Sheet Index Notes & Abbreviations Landscape Site Improvement Plan Cover Sheet **Grading Plan** Drainage Plan Bid Alternatives Diagram Drainage and Utility Plan **Demolition Plan** Drainage and Utility Plan Construction Plan Details Shoreline Sections Construction Details Details Construction Details Construction Details **Erosion Control Plan Construction Details Erosion Control Details** Site Materials **Erosion Control Details** Restroom Plans **Erosion Control Details** Restroom Plans Restroom Plans Electrical Layout Plan Electrical Legend & Notes Grading Plan Electrical Schedules Soils Placement Plan Title 24 Compliance Planting Plan - Park East Planting Plan - Park West Title 24 Compliance Planting Schedule Title 24 Compliance Planting Palette Electrical Site Plan Planting Palette Electrical Restroom Plan Planting Details **Electrical Diagrams** Irrigation Plan **Electrical Diagrams**

<u>Appendix</u>

Boundary & Topographic Survey

Irrigation Details

Irrigation Details

Irrigation Details





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PROJECT/CLIENT NAME

#### **Dunphy Park**

200 Napa Street Sausalito, CA 94965

Owner: City of Sausalito 420 Litho St. Sausalito, CA 94965

RHAA PROJECT NUMBER

16042A

**CONSULTANT** 

**SUBMITTAL** 


Permit Submittal

21 August 2017

REVISIONS

**REGISTRATION AND SIGNATURE** 



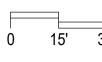

**COVER SHEET** 

#### **General Notes**

These drawings describe the quality and character of the materials, shape, configuration and design intent of the completed, installed work.

The installed work shall conform to the requirements of the governing building authority; requirement of the City of Sausalito, Marin Municipal Water District, and any other permitting agency; all special requirements and conditions of the design review permit and building permit; and all applicable codes, laws, standards, etc.

All general notes, dimensions, and details shall be considered typical and apply to similar conditions unless otherwise noted. Specific notes, details and specifications shall take precedence over general notes and typical details.

All work shall be in accordance with the recommendations specified in the Geotechinical Study Report prepared by RGH Consultants, dated June 9, 2015.

The site plan and proposed grading has been developed based on the Boundary and Topographic Survey by Linda A Carruthers & Associates, dated 12/09/13.

All existing grades, site elements and underground utilities shown on these plans reflect the available records provided by the City of Sausalito.

All existing utility structures (shown or not shown on the drawings) within the area of work shall be adjusted or reconstructed to the finish grades shown and specified.

Utility connections and disconnections necessary to complete the work shall be performed in such a manner as to minimize utility service interruptions.

#### General References

The contractor shall comply with all requirements of the City of Sausalito, Marin Municipal Water District requirements, and the state water efficient landscape ordinance.

California Building Code (Caliifornia Code of Regulations Title 24), current addition

Local air quality maintenance district for airborne particulate

Uniform Building Code (UBC)

Caltrans standards

CAL-OSHA, 'Construction Safety Orders' and division of industrial safety pertaining to "Confined Space", current edition

Current standards of the americans with disabilites act (ada)

California regional water quality control board requirements.

Latest edition of the uniform plumbing code and the national electric code.

California 1881 model water landscape ordinance or adopted local ordinance.

#### **Quality Control Notes**

Contractor to provide mockups of all paving materials, walls, etc. for approval

Contractor to submit shop drawings, product technical data sheets, and material samples for approval.

Contractor to submit soil analysis reports for all planting soils for approval.

All approved submittals, test results, products, systems, shop drawings, materials, and mockups will be considered part of the project specifications.

#### Accessibility Notes

All site work shall comply with current California Building Code (Caliifornia Code of Regulations Title 24), current standards of the Americans with Disabilites Act (ADA)

All paving areas shall be accessible per title 24. All paving surfaces are to be stable, firm, and slip resistant with cross slopes not to exceed 2% in any direction, unless otherwise noted. Accessible paths of travel are barrier-free access routes at least 48" clear in width and without any abrupt vertical level changes exceeding 1/2" if beveled at 1:2 max slope, or vertical level changes not exceeding 1/4" max. All accessible pathways shall be sloped less than 5% in the direction of travel, unless otherwise noted.

All accessible paths of travel shall be maintained free of overhanging obstructions below 80" above finish grade. Objects with leading edges located between 27"and 80" above finish grade shall not protrude more than 4" horizontally into the path of travel. Exceptions include handrails, door closers, and door stops. Guardrails or other barriers shall be provided where object protrusion is beyond the limits allowed.

#### Tree Protection Notes

Each tree identified for preservation shall receive supplemental irrigation prior to and during the demolition and construction process.

Establish a tree protection zone (tpz) for each tree identified for preservation prior beginning any demolition or construction work. Any modifications to the TPZ must be approved and monitored by the project arborist.

Prohibit work within the tree protection zone, including: grading and storage of soil; construction access routes; travel and parking of all vehicles and construction equipment; grade changes and excavations; material storage and staging; fuel and mixing areas; washout areas for concrete and other materials.

No irrigation trenching shall occur within the tpz, see irrigation specification.

Fence all trees to be retained to completely enclose the tree protection zone prior to demolition, grubbing or grading. Fences shall be 6 ft. Chain link or equivalent as approved. Where possible, fence group of trees together. Fences are to remain in place until all grading and construction is completed.

Protect all trunks and limbs exposed to potential damage by construction activities with timbers secured to trees with metal straps as approved by the project arborist.

Prune trees to be preserved to clean the crown and to provide construction clearance. All pruning shall be completed by a certified arborist or tree worker and adhere to the tree pruning guidelines of the international society of arboriculture. Brush shall be chipped and spread beneath the trees within the tree protection zone.

Ensure that any root pruning required for construction purposes is supervised by and receives the approval of the project arborist.

Apply and maintain 3" of wood chip mulch within the tree protection zone. Keep the mulch 2' from the base of tree trunks.

Evaluate any injury to trees that should occur during construction. Notify the project arborist so that appropriate treatments can be applied.

Require that any tree pruning needed for clearance during construction be performed by a certified arborist and not by construction personnel.

An I.S.A. certified arborist or tree worker shall be present at all times during pruning. All pruning shall be in accordance with the tree pruning guidelines of the international society of arboriculture and adhere to the most recent edition of the american national standards for tree care operations (z133.1) and tree pruning

#### Layout Notes

Parking lot stalls to be 9' x 18'. Accessible parking stalls to be provided as shown.

All walkways to be 5-feet wide, unless otherwise shown.

All curves to be continuous with smooth transitions as shown in the drawings, unless otherwise noted.

#### **Grading Notes**

The contractor is responsible for conforming to all improvements to the adjacent existing conditions with smooth transitions to avoid any abrupt or apparent changes in grades, cross slope, hazardous conditions, etc.

Contractor to notify the owner's representative of any discrepancies between the design intent and existing conditions and any conflicting information regarding finish grades and elveations.

All existing utility structures (shown or not shown on the drawings) within the area of work shall be adjusted or reconstructed to the finish grades shown and specified.

All finish grades and contours in planting areas refer to finish grade of the mulched landscape.

#### **Irrigation Notes**

The irrigation system to be controlled by a centrally located weather-based irrigation controller with a rain shutoff sensor.

The intent of this irrigation system is to provide the minimum amount of water required to sustain good plant health. The irrigation controller is to be programmed for seasonal weather changes, plant material water requirements, mounds and slopes, sun, shade and wind exposure.

Turf areas to be irrigated by pop-up spray heads and rotors. New trees to be irrigated with in-line drip irrigation (drip rings). All other planting area to be installed with in-line drip irrigation.

Shoreline planting to be temporarily irrigated during plant establishment period only. Temporary irrigation to be removed after plants are established

#### Planting Notes

Trees and plants have been selected for the local conditions and are drought tolerant.

All soil and subsoil to be tested by an approved accredited soil testing laboratory.

Landscape architect to inspect planting layout prior to installation. Contractor to provide 10'x10' mockup of all plant mixes for approval by landscape architect.

All planting areas, planters, and pots to receive 3" of organic mulch.



Vicinity Map (NTS)

#### **ABBREVIATIONS**

FACE OF BUILDING

AL	ALIGN	FOC	FACE OF CURB	REBAR	REINFORCING BAR
AC	ASPHALITIC CONCRETE	FT	FOOT/FEET	REC	RECOMMENDATION
AD	AREA DRAIN	FTG	FOOTING	REQ'D	REQUIRED
ADA	AMERICANS WITH DISABILITIES	GA	GAUGE	RGH	ROUGH
,,	ACT	GAL	GALLON	RIM	RIM ELEVATION
AGG	AGGREGATE	GALV	GALVANIZED	RWD	REDWOOD
ALUM	ALUMINUM	GB	GRADE BREAK	SAD	SEE ARCHITECTURAL DRAWINGS
APPX	APPROXIMATE	GC	GALLON CAN	SED	SEE ELECTRICAL DRAWINGS
ARCH	ARCHITECTURE	GFRC	GLASS FIBER REINFORCED	SPD	SEE PLUMBING DRAWINGS
		GFRC			
BLDG	BUILDING	ODM	CONCRETE	SSD	SEE STRUCTURAL DRAWINGS
BOS	BOTTOM OF STAIRS	GPM	GALLONS PER MINUTE	SCD	SEE CIVIL DRAWINGS
BS	BOTTOM OF STAIRS	GRD	GRADE	SD	STORM DRAIN
BX	BOX	HB	HOSE BIB	SDR	STORM / SLOT DRAIN RIM
CAL	CALIPER	HDPE	HIGH DENSITY POLYETHYLENE	SHT	SHEET
CALDAG	CALIFORNIA DISABLED	HDR	HEADER	SJ	SCORE JOINT
	ACCESSIBILITY GUIDEBOOK	HORIZ	HORIZONTAL	SMD	SEE MECHANICAL DRAWINGS
СВ	CATCH BASIN	HT	HEIGHT	SPCS	SPACES
CBC	CALIFORNIA BUILDING CODE	ID	INSIDE DIAMETER	SPEC'D	SPECIFIED
CJ	CONTROL JOINT	INV	INVERT ELEVATION	SPECS	SPECIFICATIONS
CL	CENTERLINE	IRR	IRRIGATION	SQ	SQUARE
CLF	CHAIN LINK FENCE	LF	LINEAR FEET	SF	SQUARE FEET
CLR	CLEAR	MAWA	MAXIMUM APPLIED WATER	SS	STAINLESS STEEL
CO	CLEAN OUT		ALLOWANCE	STD	STANDARD
COL	COLUMN	MAX	MAXIMUM	STL	STEEL
CONC	CONCRETE	MFG	MANUFACTURER	STPA	STORMWATER TREATMENT
CONST	CONSTRUCTION	MH	MANHOLE		PLANTING AREA
CONT	CONTINUOUS	MIN	MINIMUM	SW	SIDEWALK
CTR	CENTER	(N)	NEW	TBD	TO BE DETERMINED
CY	CUBIC YARD	NIC	NOT IN CONTRACT	TC	TOP OF CURB
DG	DECOMPOSED GRANITE	NO	NUMBER	TOF	TOP OF FOOTING
DI	DRAIN INLET	NTS	NOT TO SCALE	TOW	TOP OF WALL
DIA	DIAMETER	OC	ON CENTER	TS	TOP OF STAIRS
DWGS	DRAWINGS	OD	OUTSIDE DIAMETER	TW	TOP OF WALL
EJ	EXPANSION JOINT	PA	PLANTING AREA	TYP	TYPICAL
	ELECTRICAL TRANSFORMER	PERF	PERFORATED	UBC	UNIFORM BUILDING CODE
ELEV	ELEVATION	PERP	PERPENDICULAR		
		PIP		UON	UNLESS OTHERWISE NOTED
EQ	EQUAL		POURED-IN-PLACE	VERT	VERTICAL
EQUIP	EQUIPMENT	PL BOO	PROPERTY LINE	W	WATER LINE
ETWU	ESTIMATED TOTAL WATER USE	POC	POINT OF CONNECTION	WUCOLS	WATER USE CLASSIFICATION
(E)	EXISTING	PROP	PROPOSED		OF LANDSCAPE SPECIES
FFE	FINISH FLOOR ELEVATION	PSI	POUNDS PER SQUARE INCH	W/	WITH
FG	FINISH GRADE	PVC	POLYVINYL-CHLORIDE	@	AT
FL	FLOWLINE	QTY	QUANTITY		
<b>F</b> ∩ <b>P</b>		D	DADILIC		

RADIUS **ROOTBALL** 



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**CONSULTANT** 

SUBMITTAL

Permit Submittal

21 August 2017

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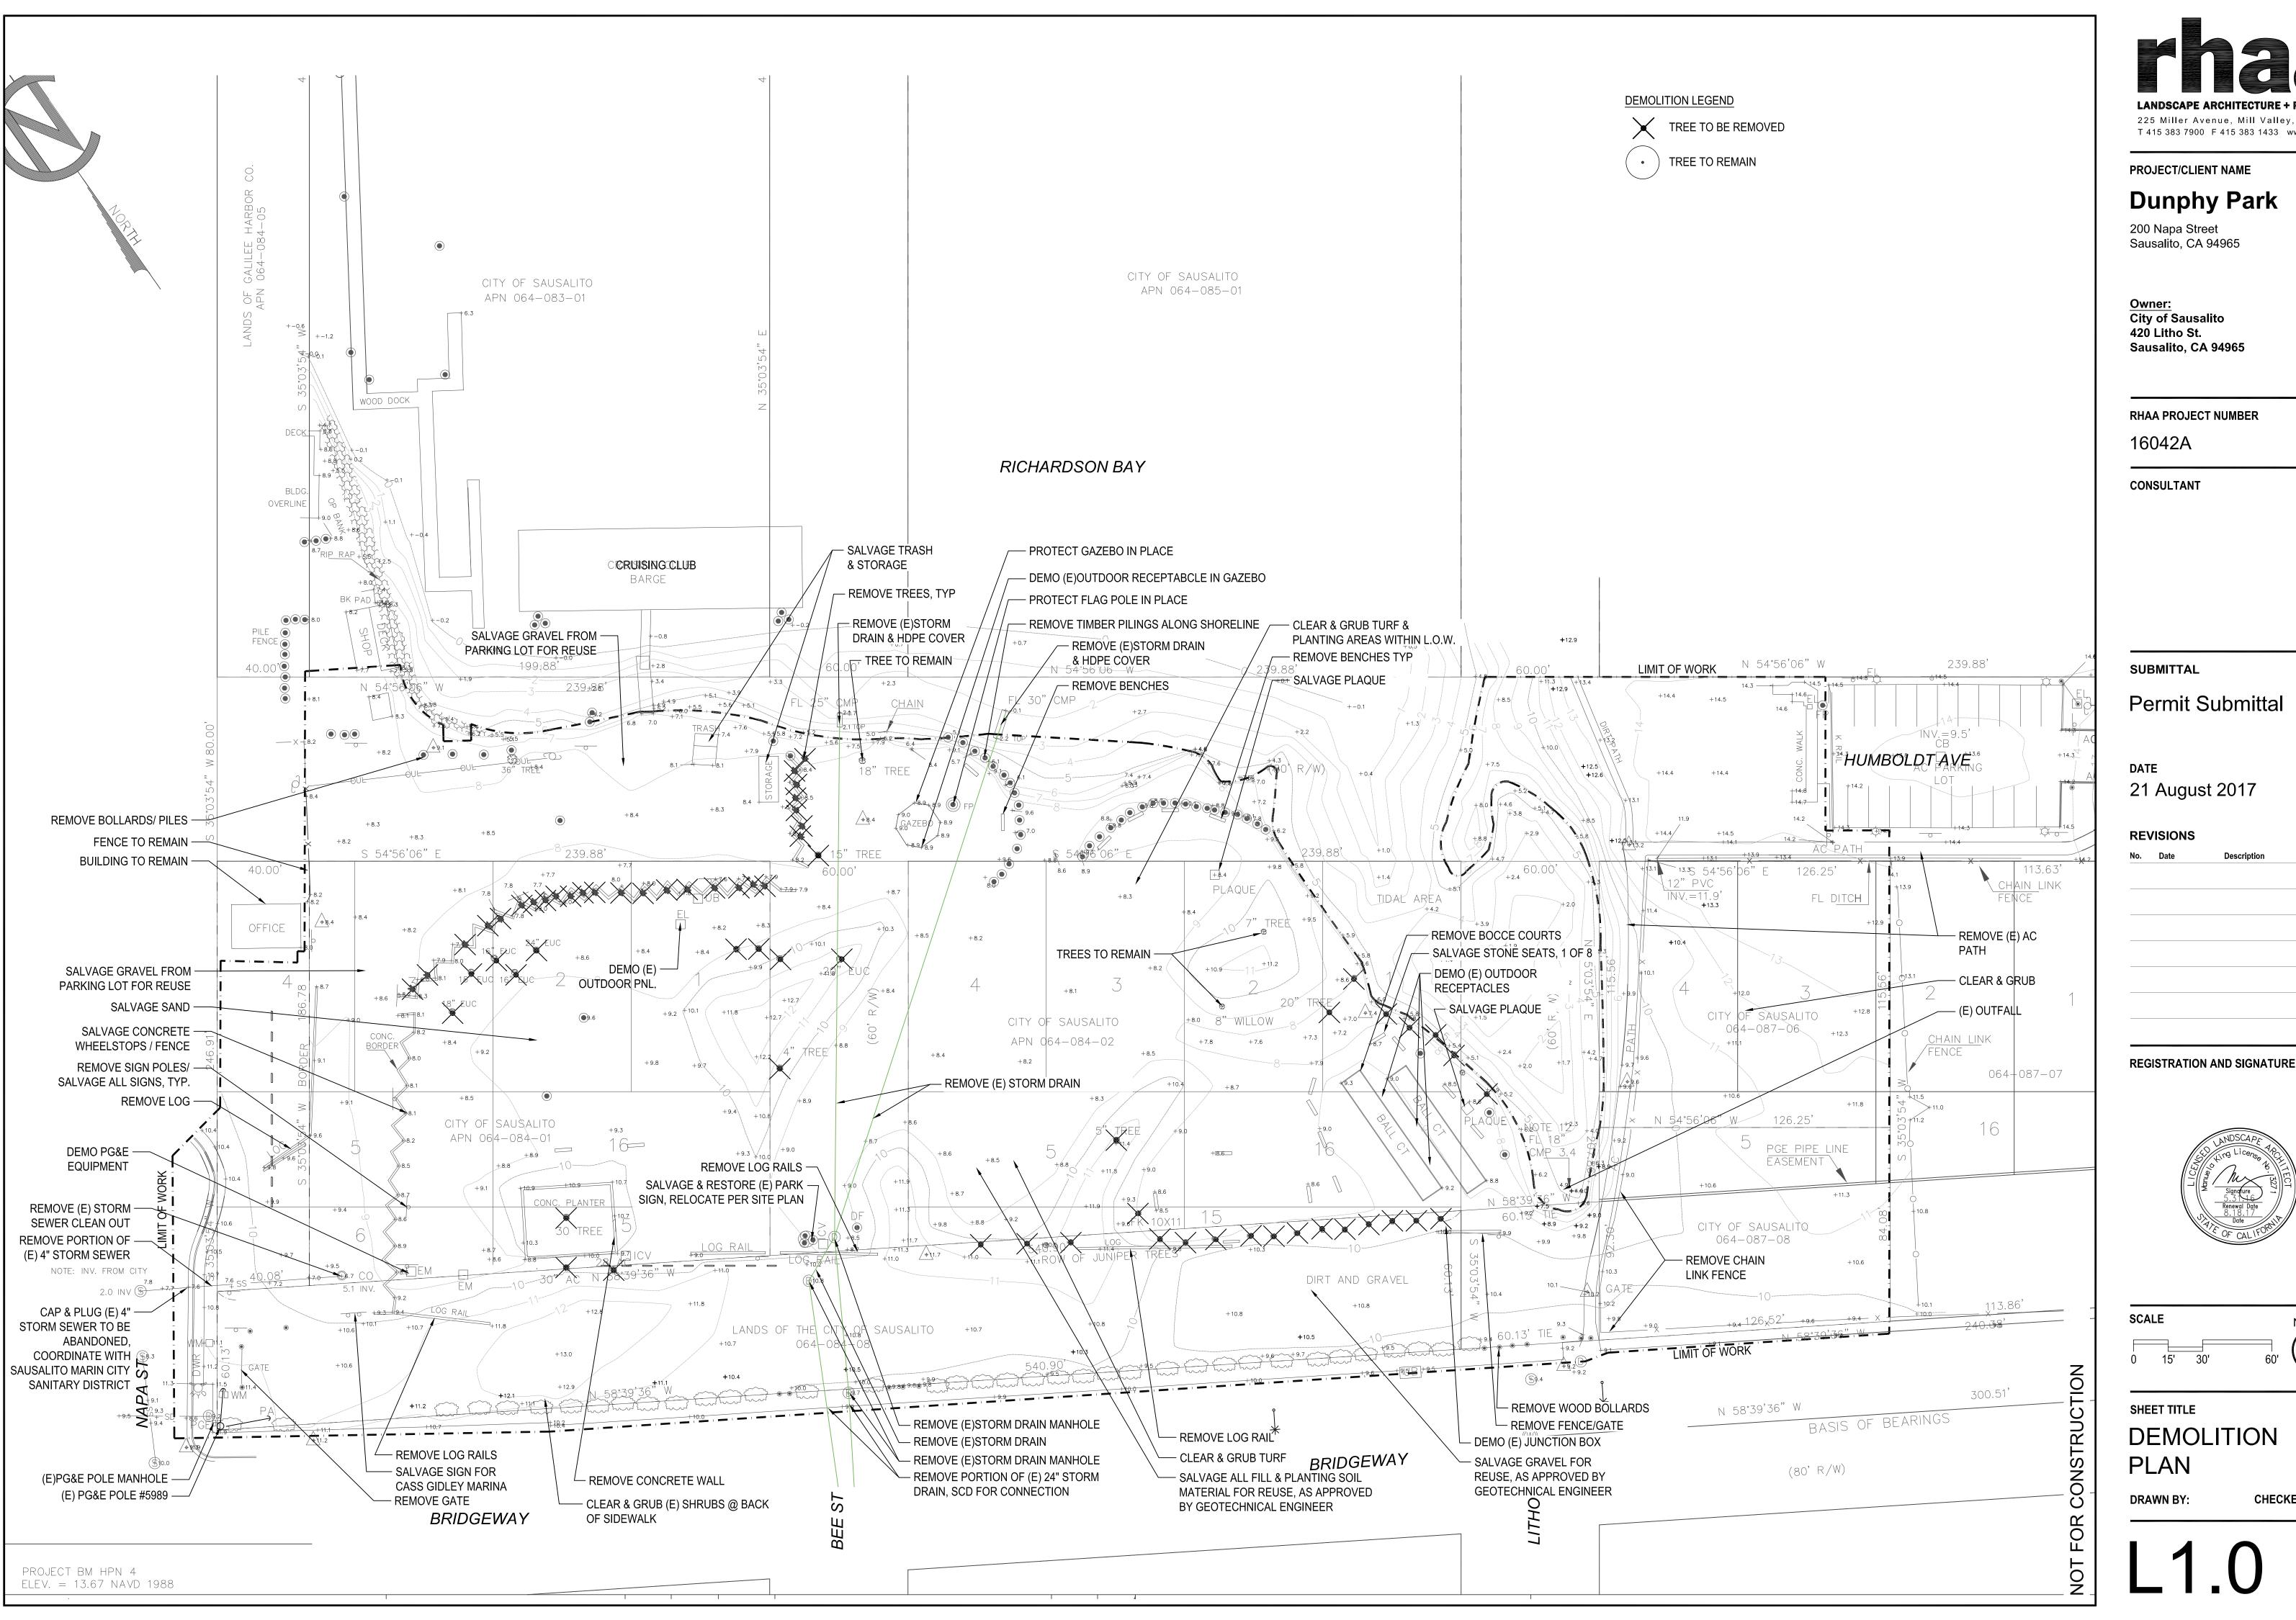
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ADD ALTERNATES





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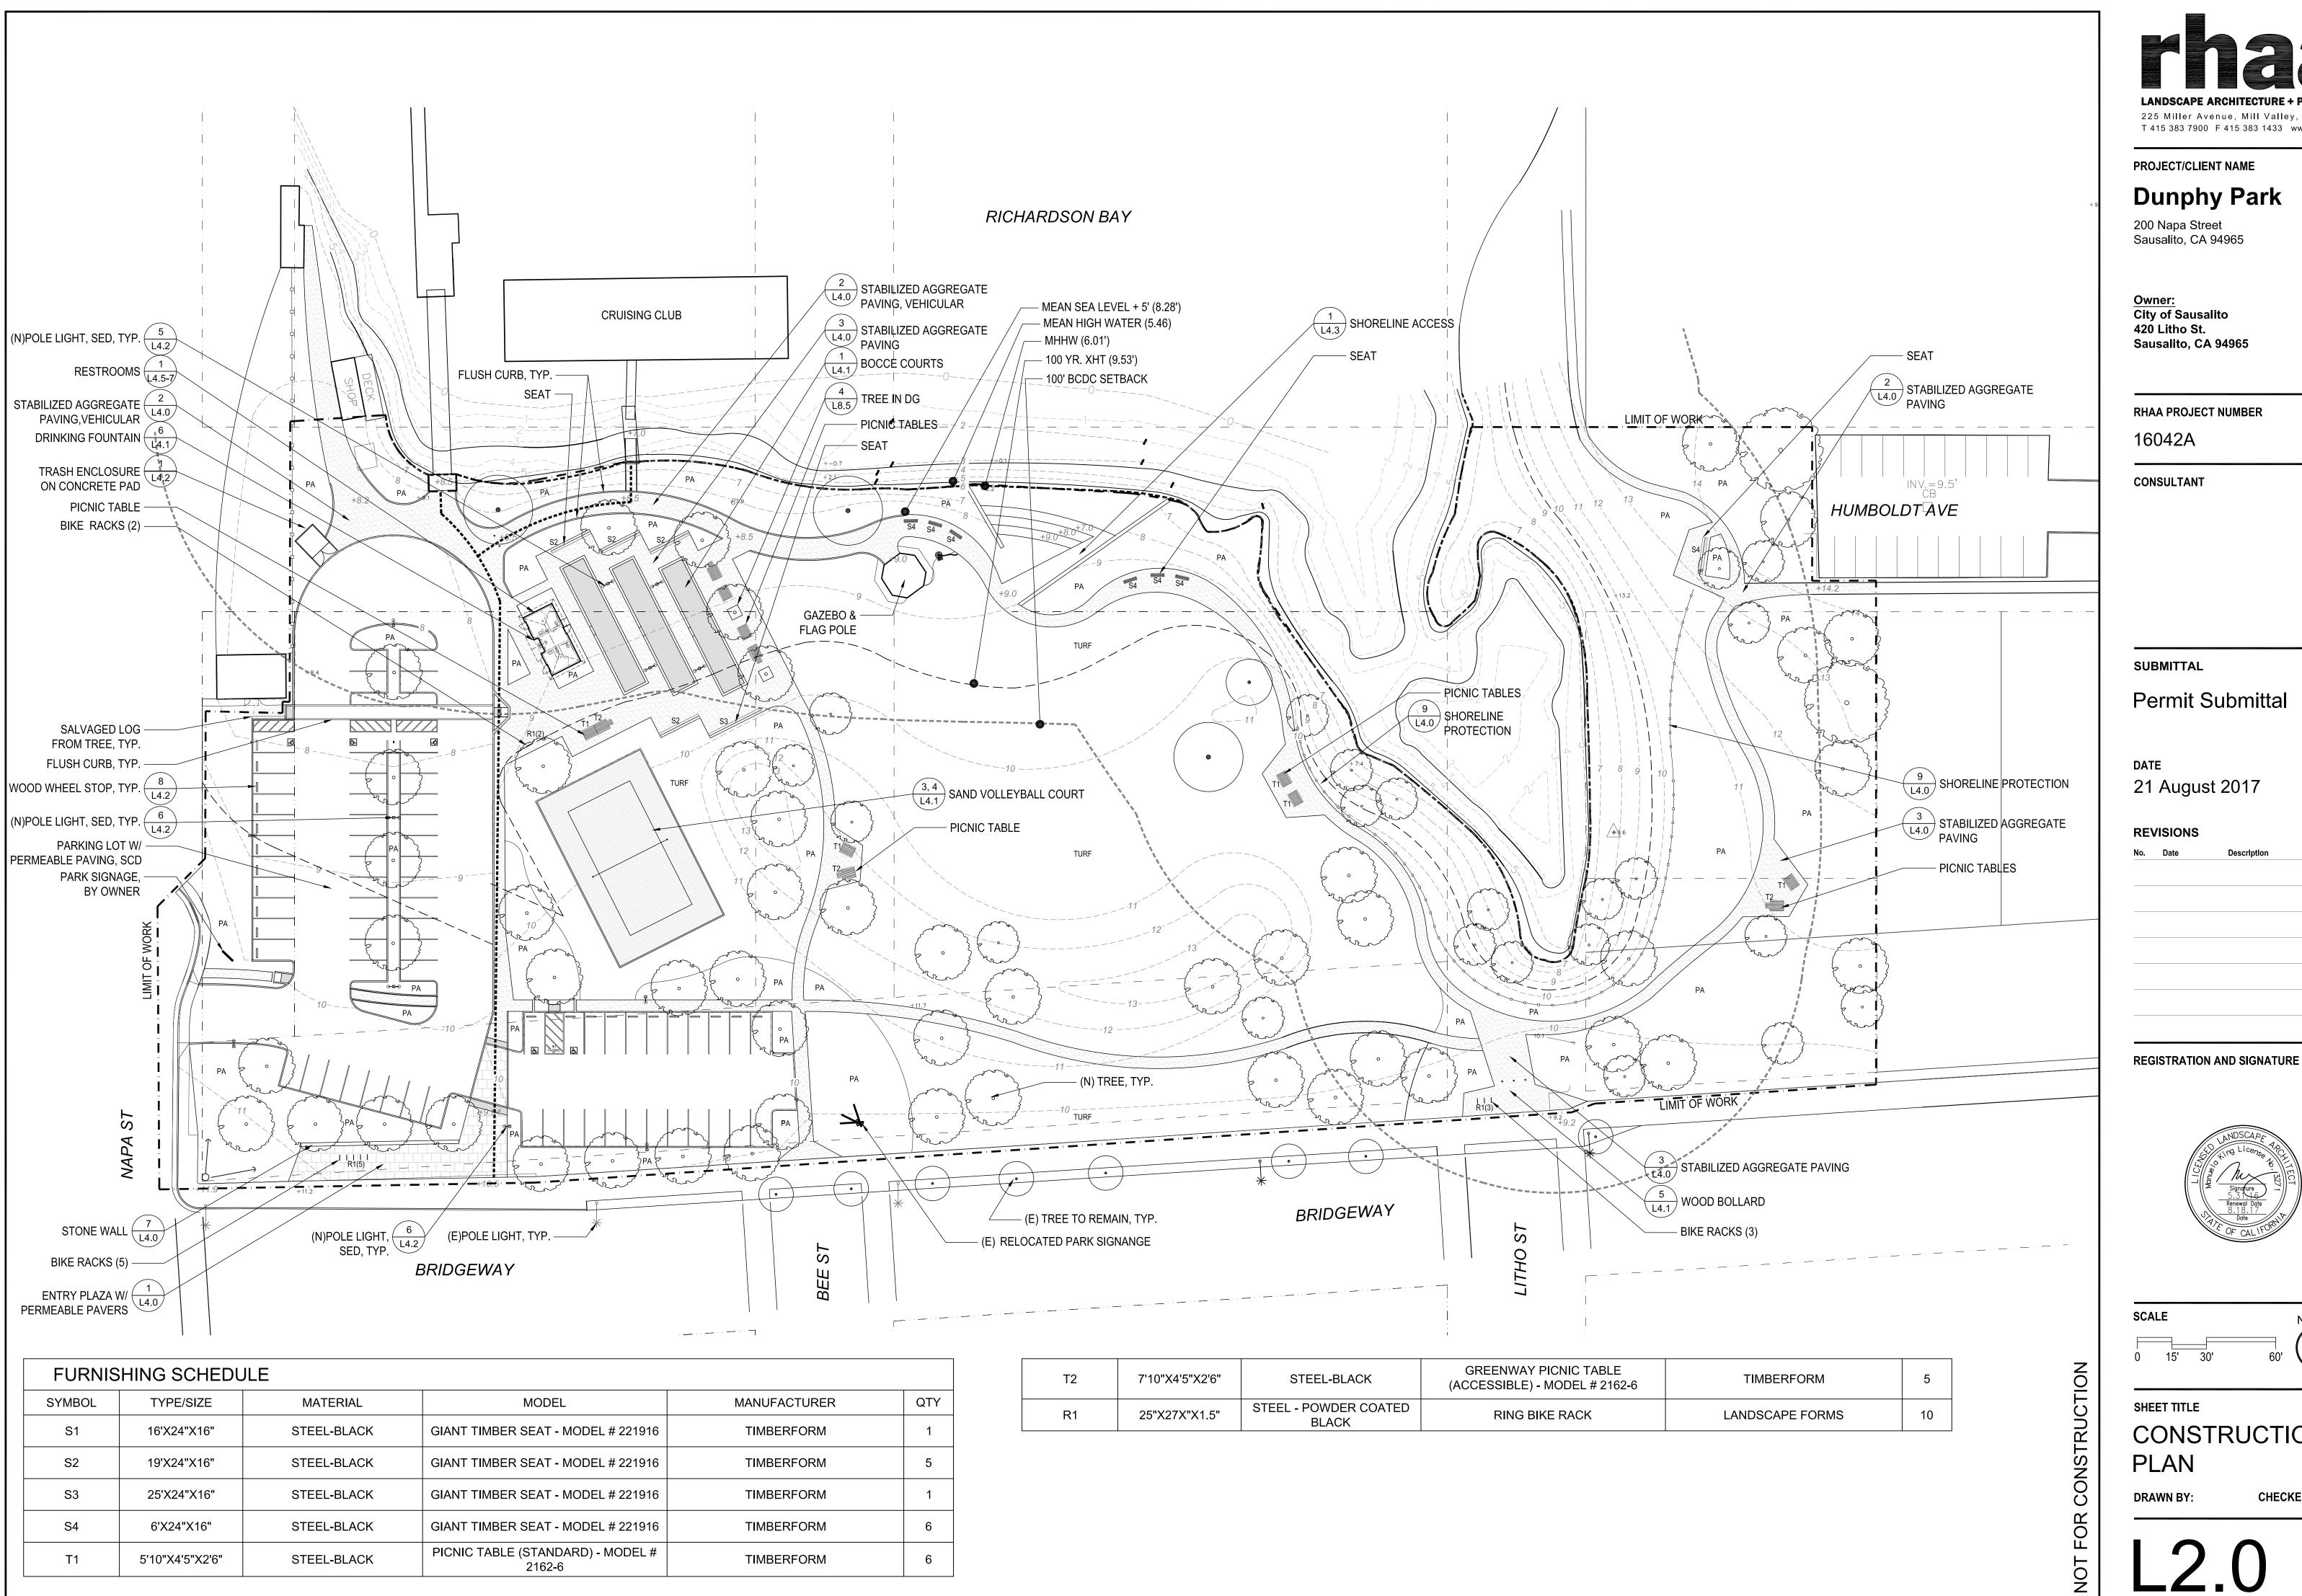


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**DEMOLITION** PLAN

DRAWN BY:





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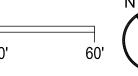
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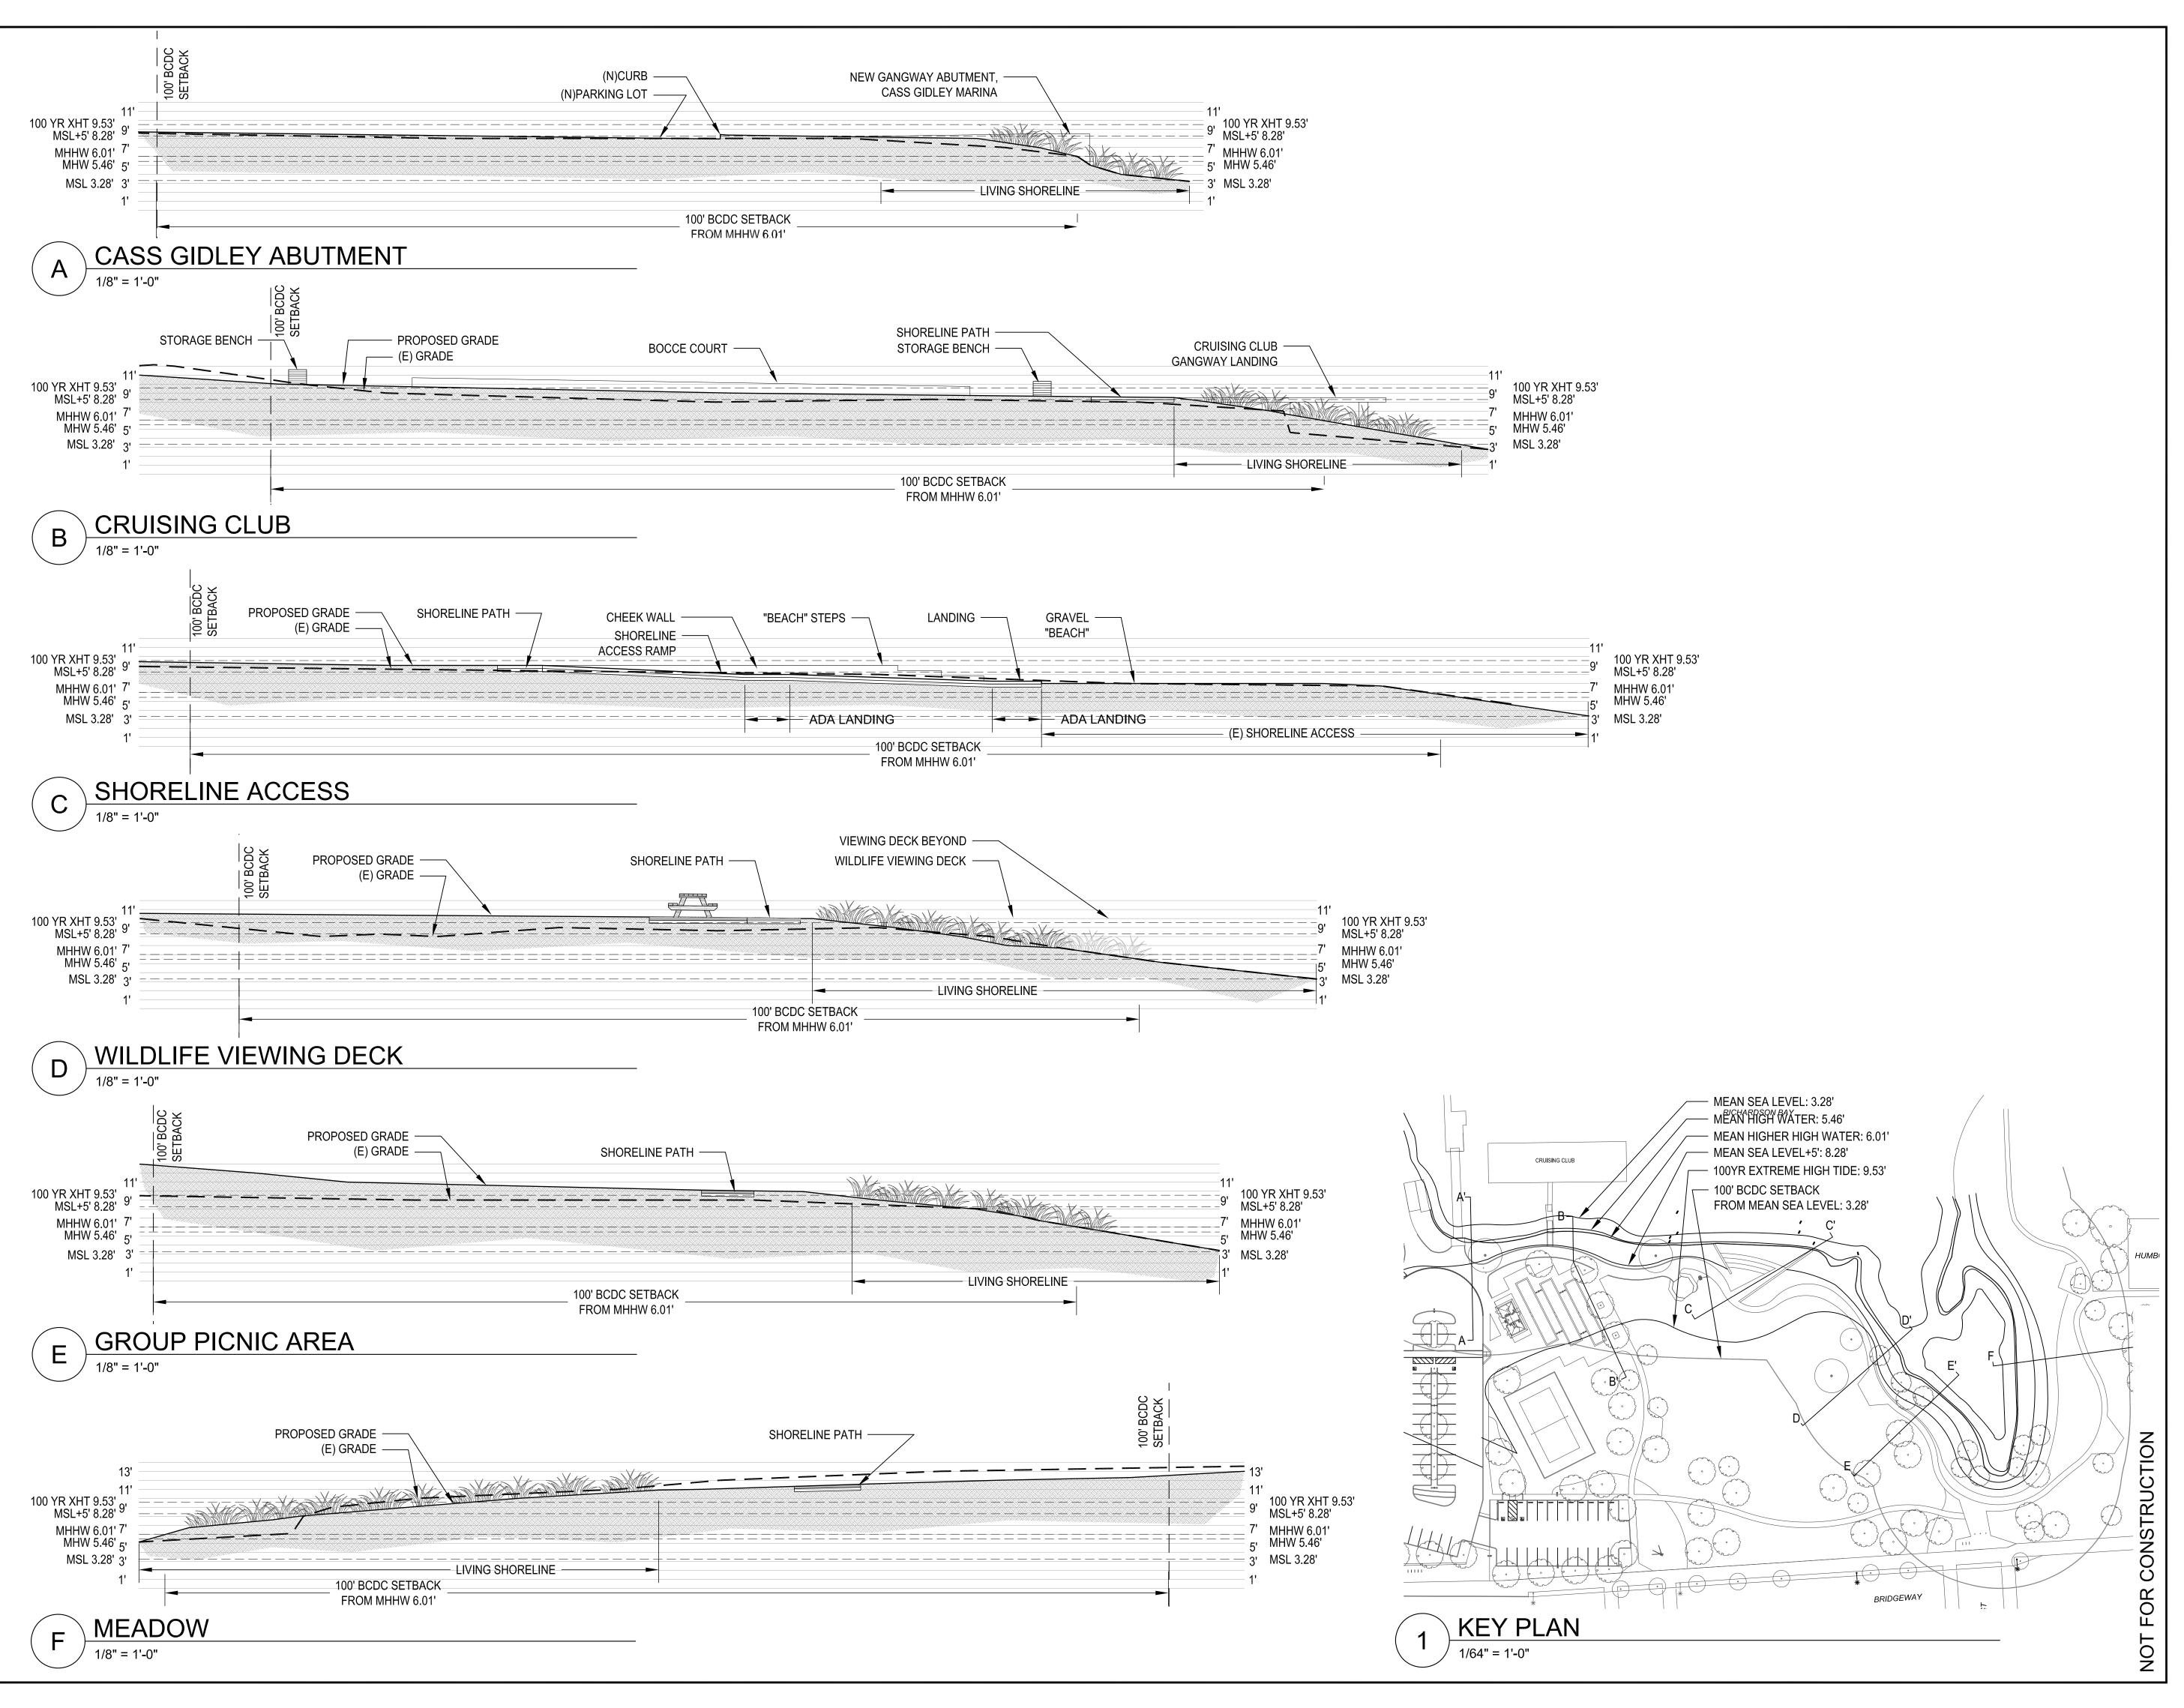
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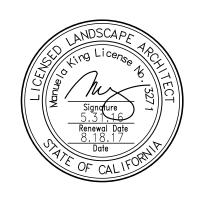
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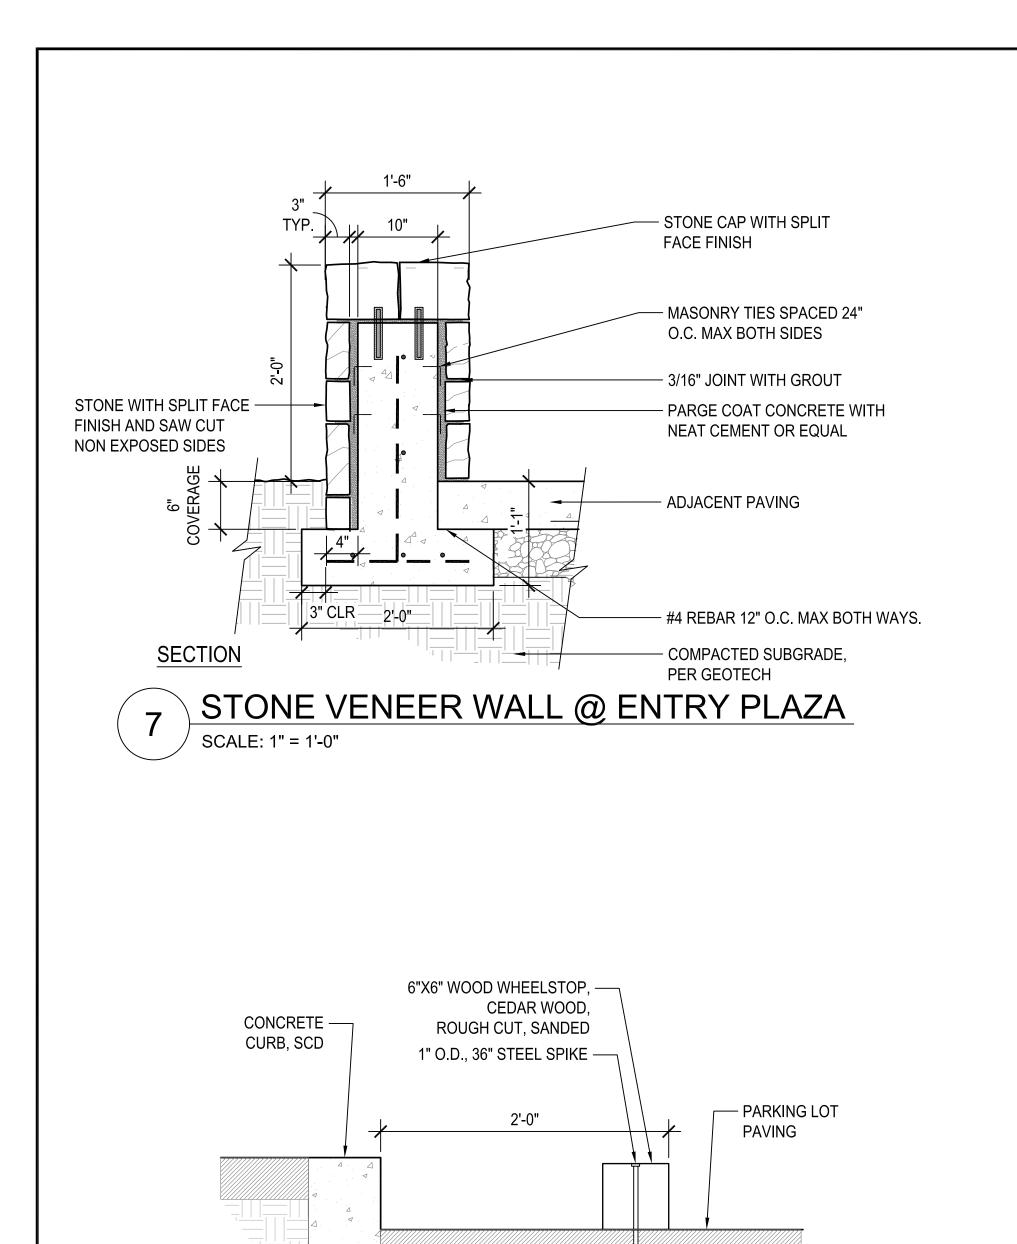
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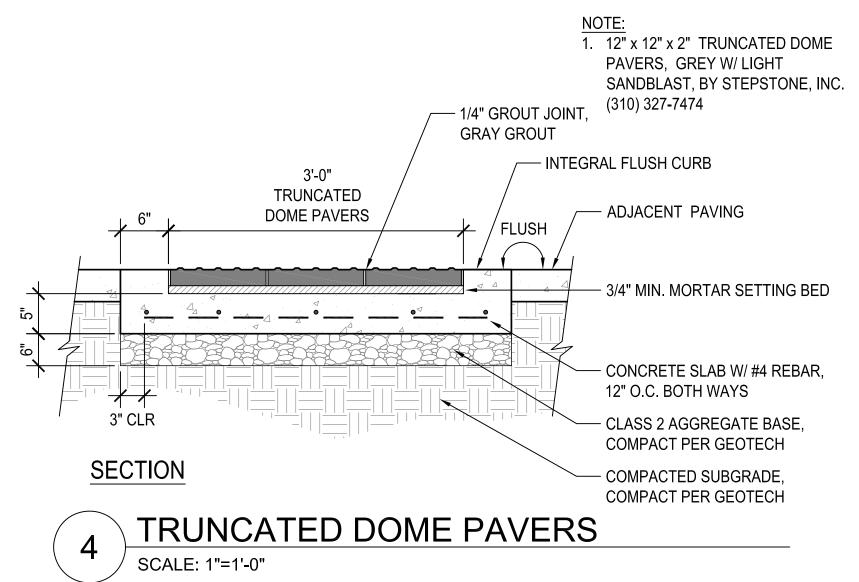
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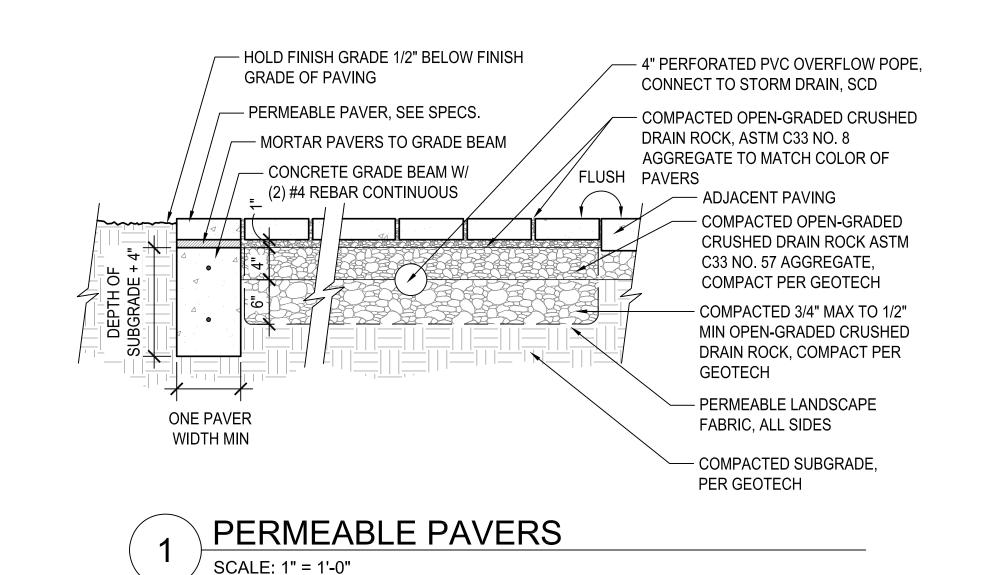
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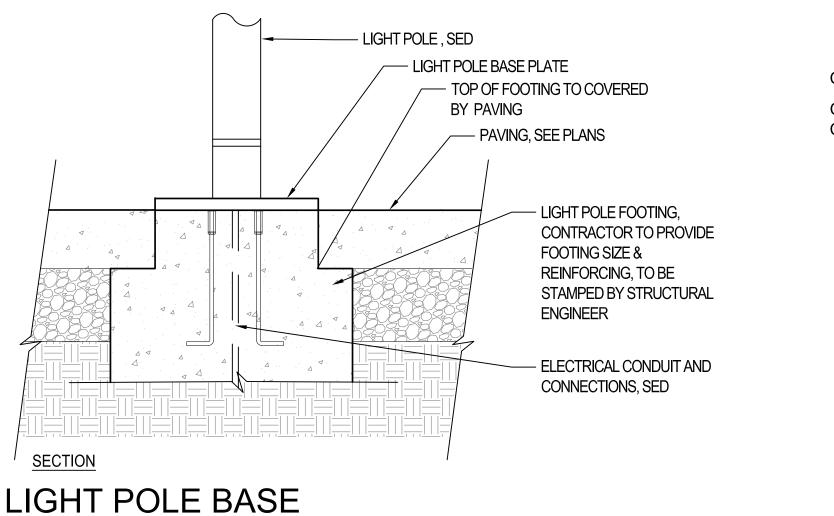
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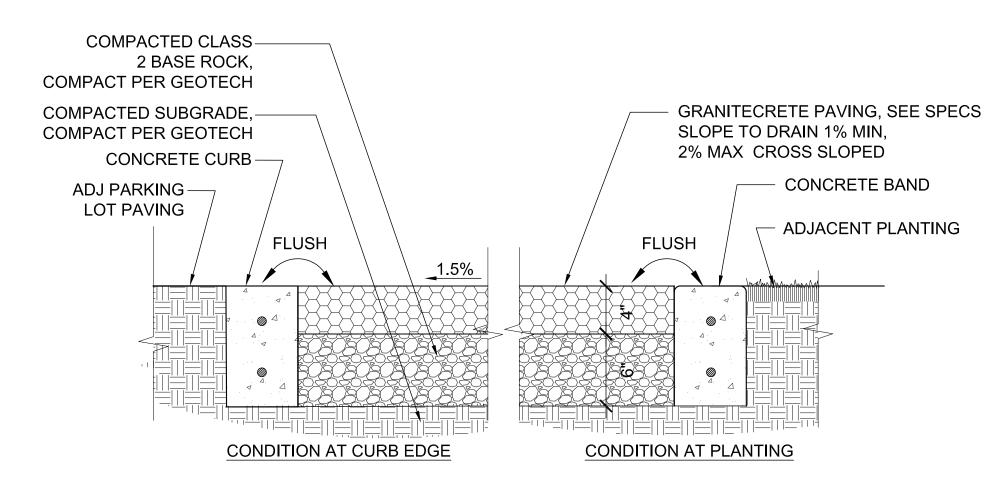
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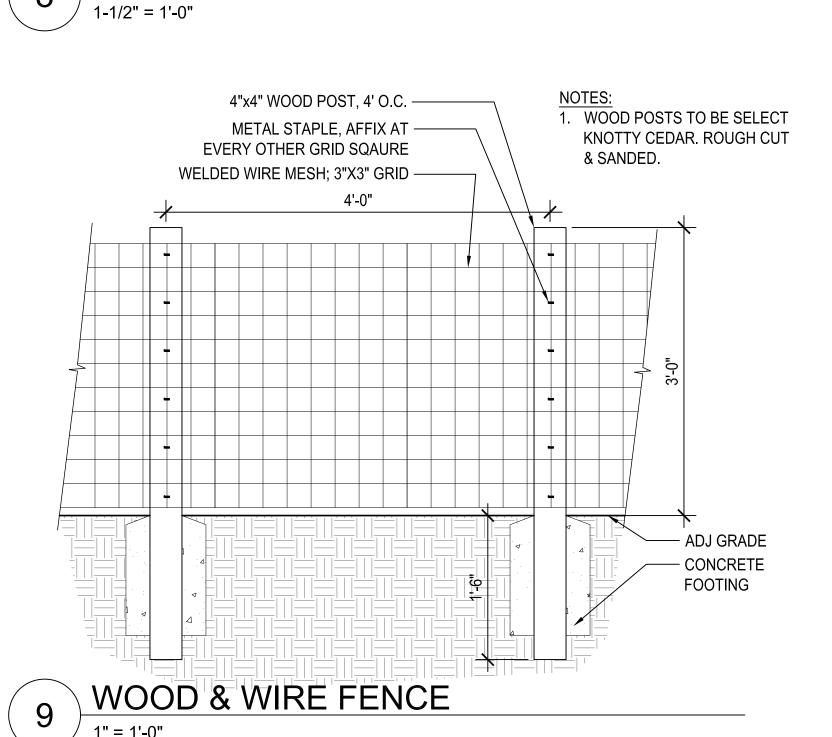














WOOD WHEEL STOP

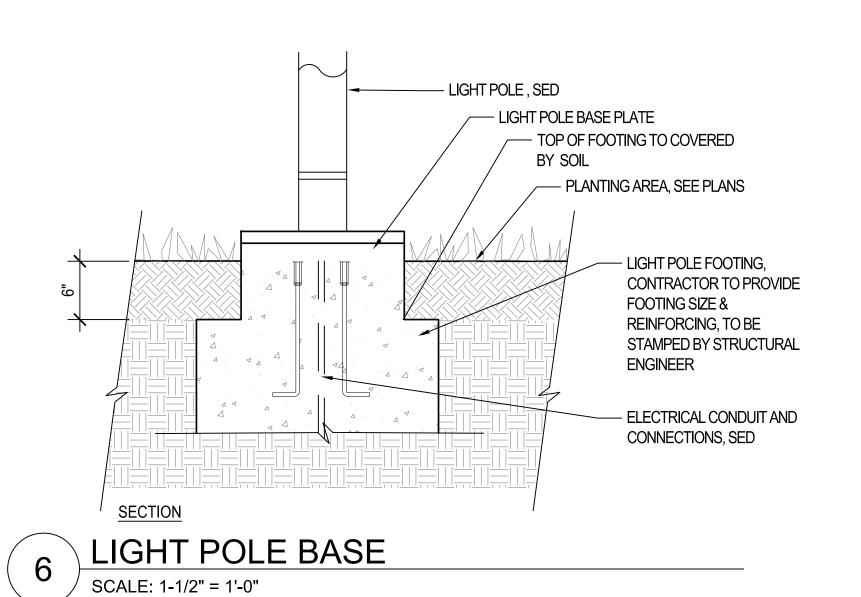

SCALE: 1-1/2" = 1'-0"

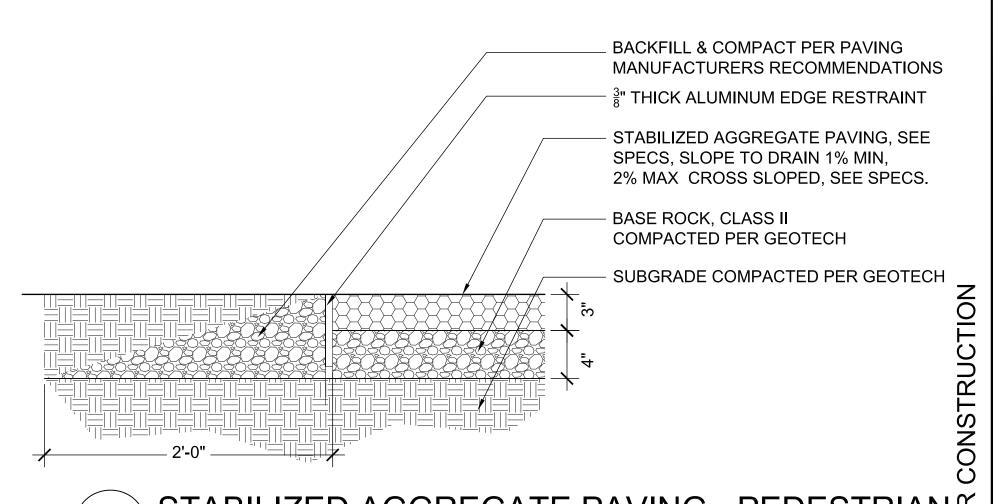

STABILIZED AGGREGATE PAVING - PEDESTRIAN OF 1-1/2" = 1'-0"

LANDSCAPE ARCHITECTURE + PLANNING
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0	15'	30'	60'	


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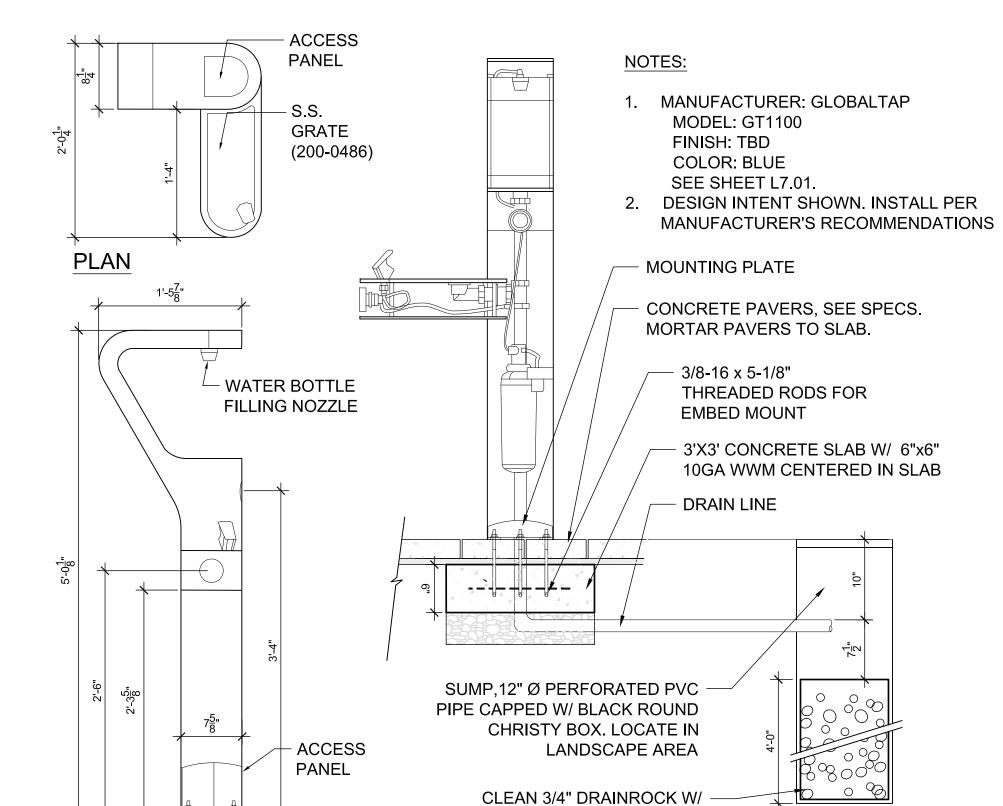
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DRAINAGE SECTION


PERMEABLE GEOTEXTILE FABRIC

ENVELOPE, WRAP & OVERLAP 12"


1'-0" —

6 WATER FOUNTAIN
1" = 1'-0"

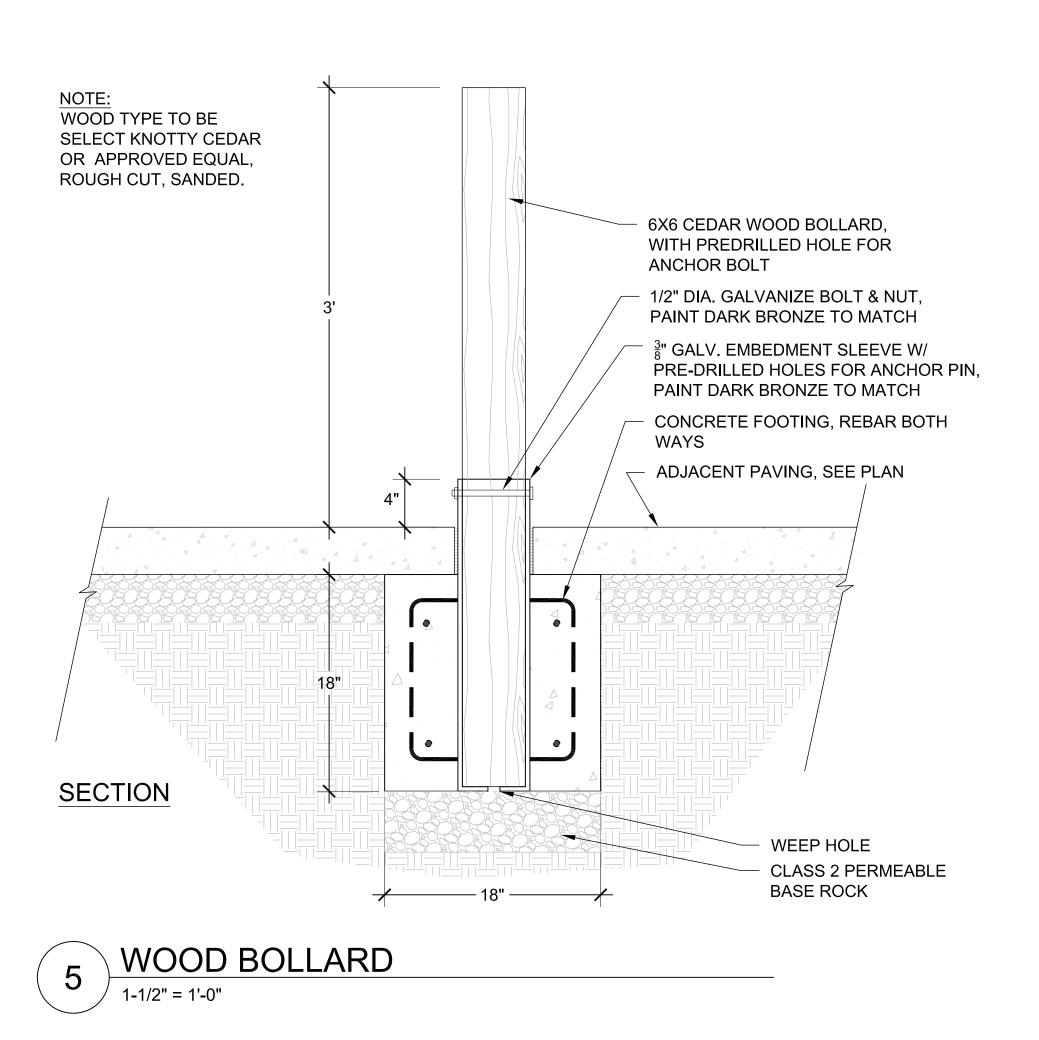**ELEVATION** 

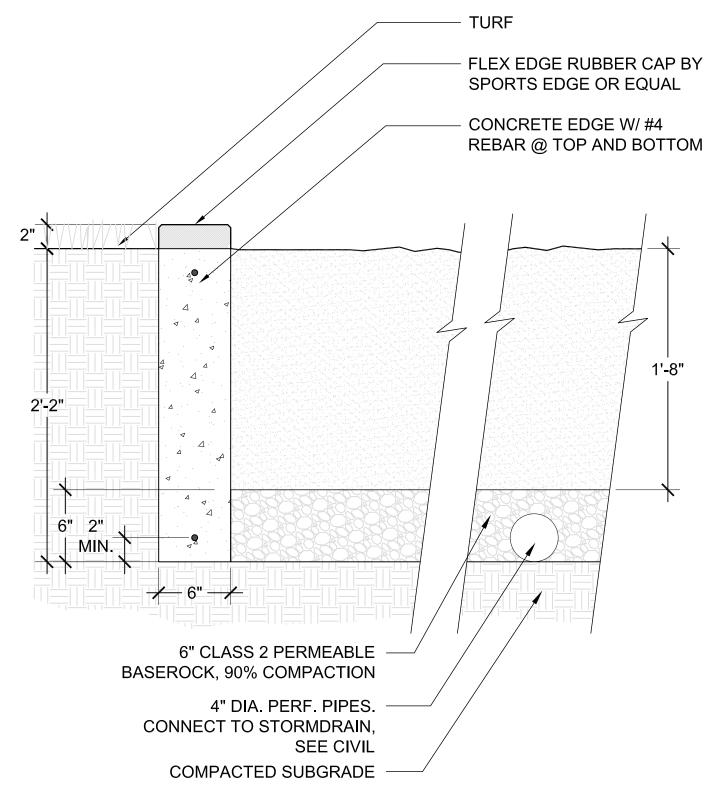



3 VOLLEYBALL COURT - RUBBERIZED EDGE

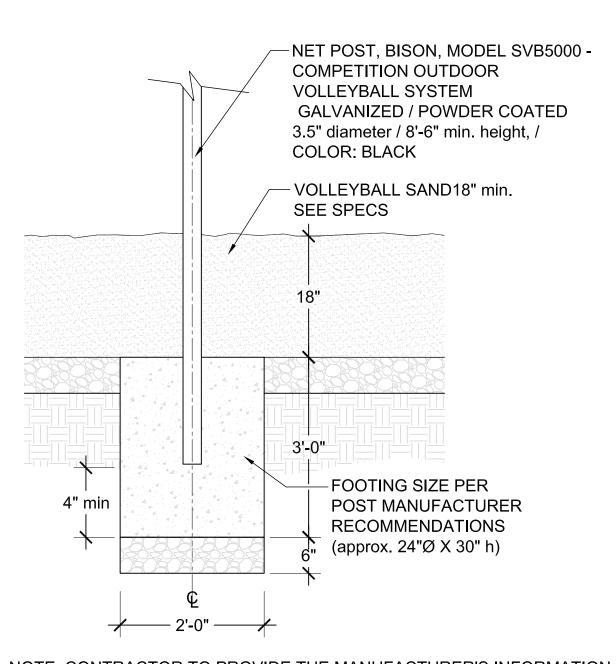


NOTE: CONTRACTOR TO PROVIDE THE MANUFACTURER'S INFORMATION ON THE VOLLEYBALL POLE FOOTINGS, REINFORCEMENT AND ANCHOR BOLTS TO THE CITY INSPECTOR.

4 VOLLEYBALL NET FOOTING
3/4" = 1'-0"

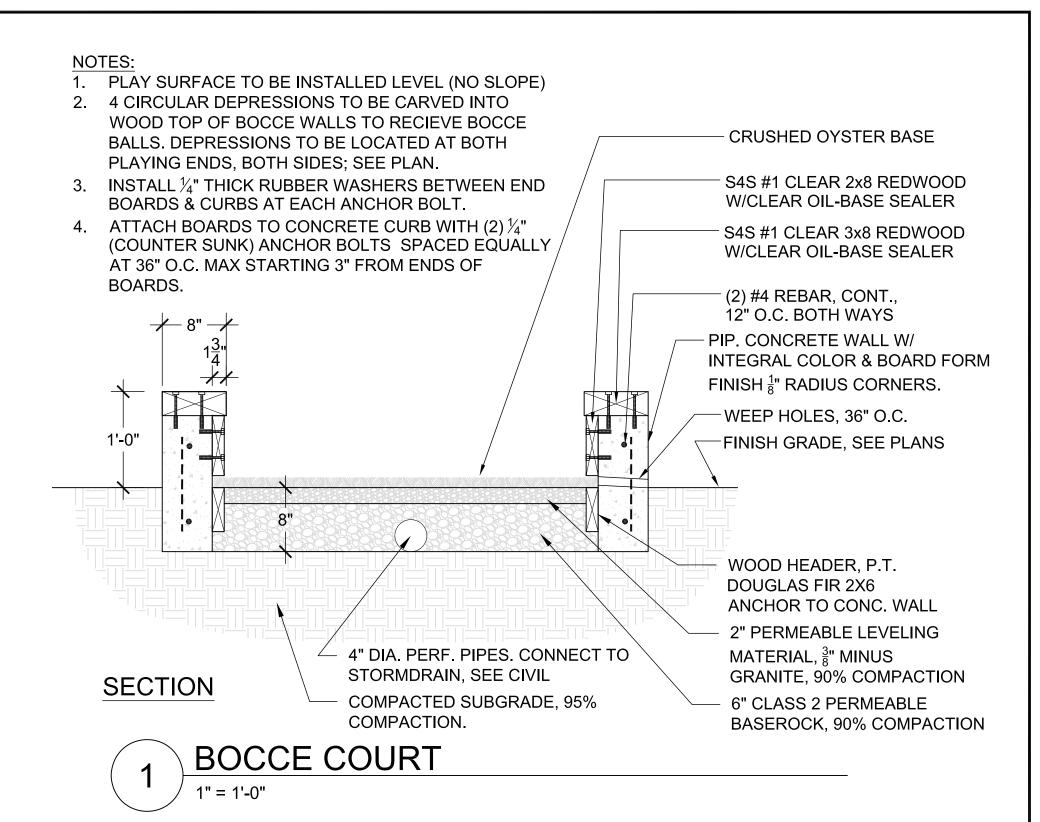

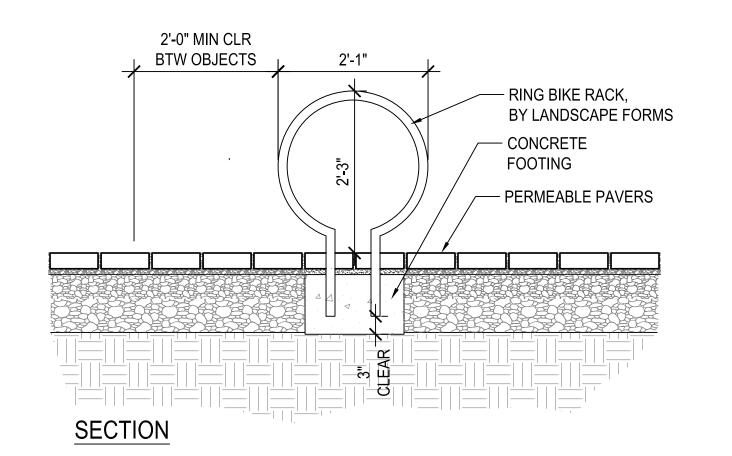

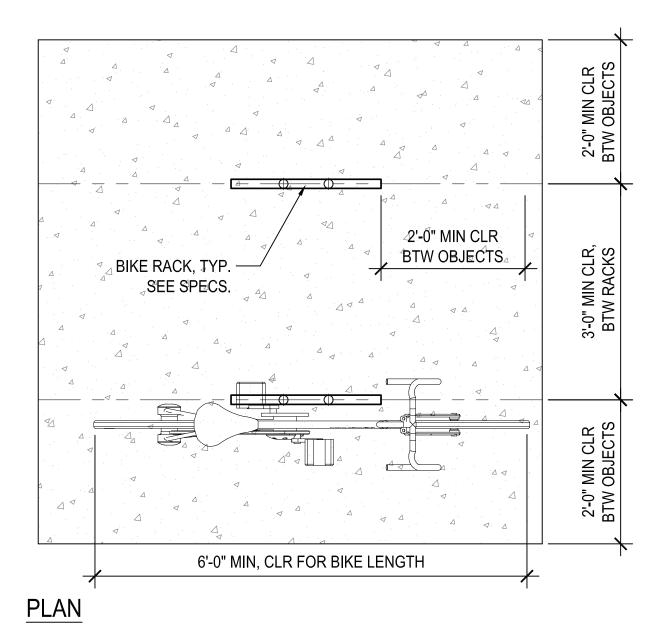

2 BIKE RACK - CIRCULAR

SCALE: 3/4" = 1'-0"

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SCALE

0 15' 30' 60'


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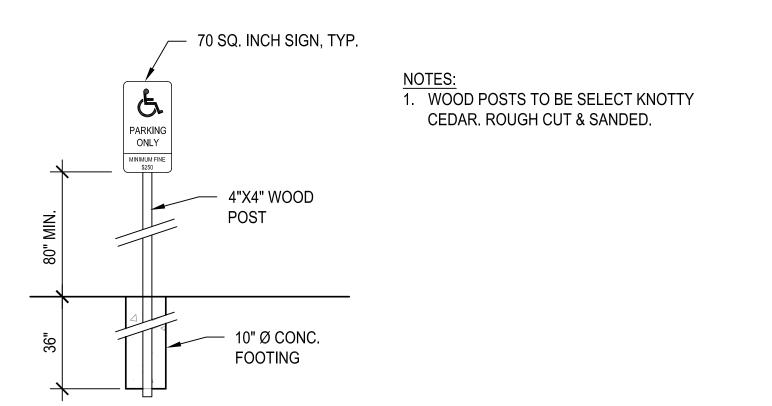
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ACCESSIBLE PARKING SIGNAGE SCALE: 1/4" = 1'-0"

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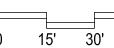
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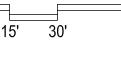
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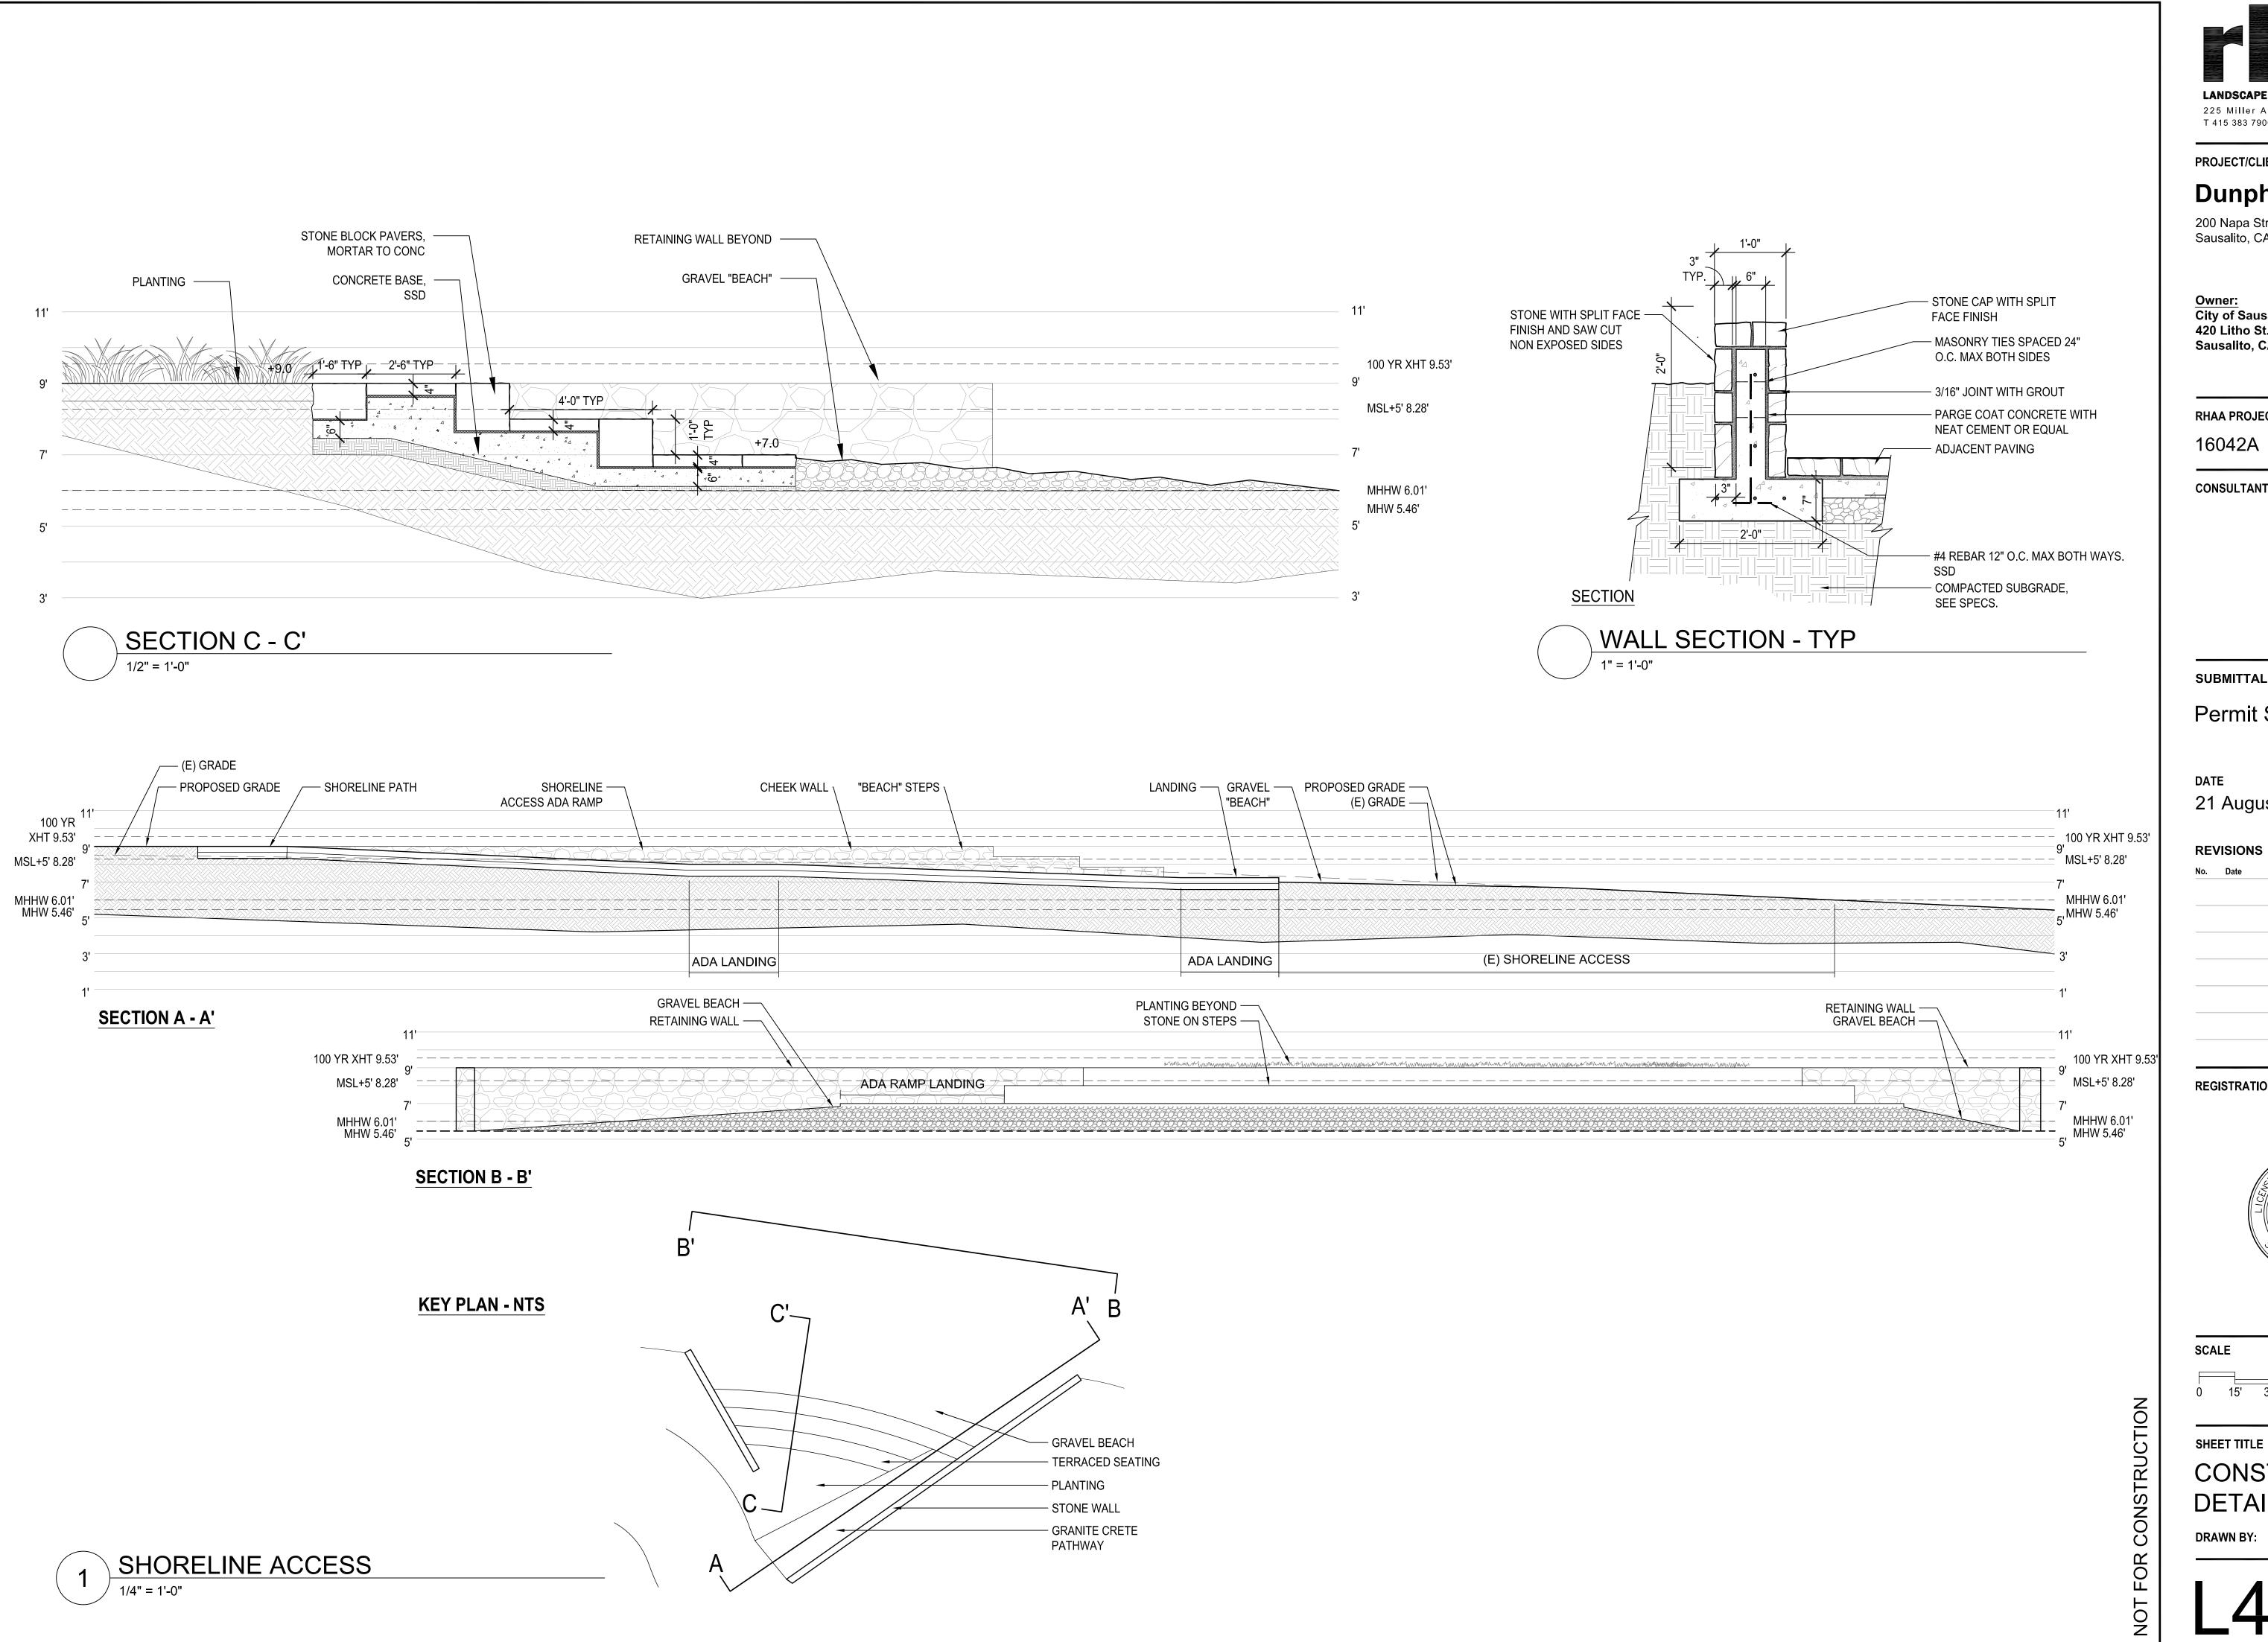






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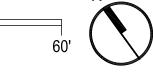
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CONSTRUCTION **DETAILS** 

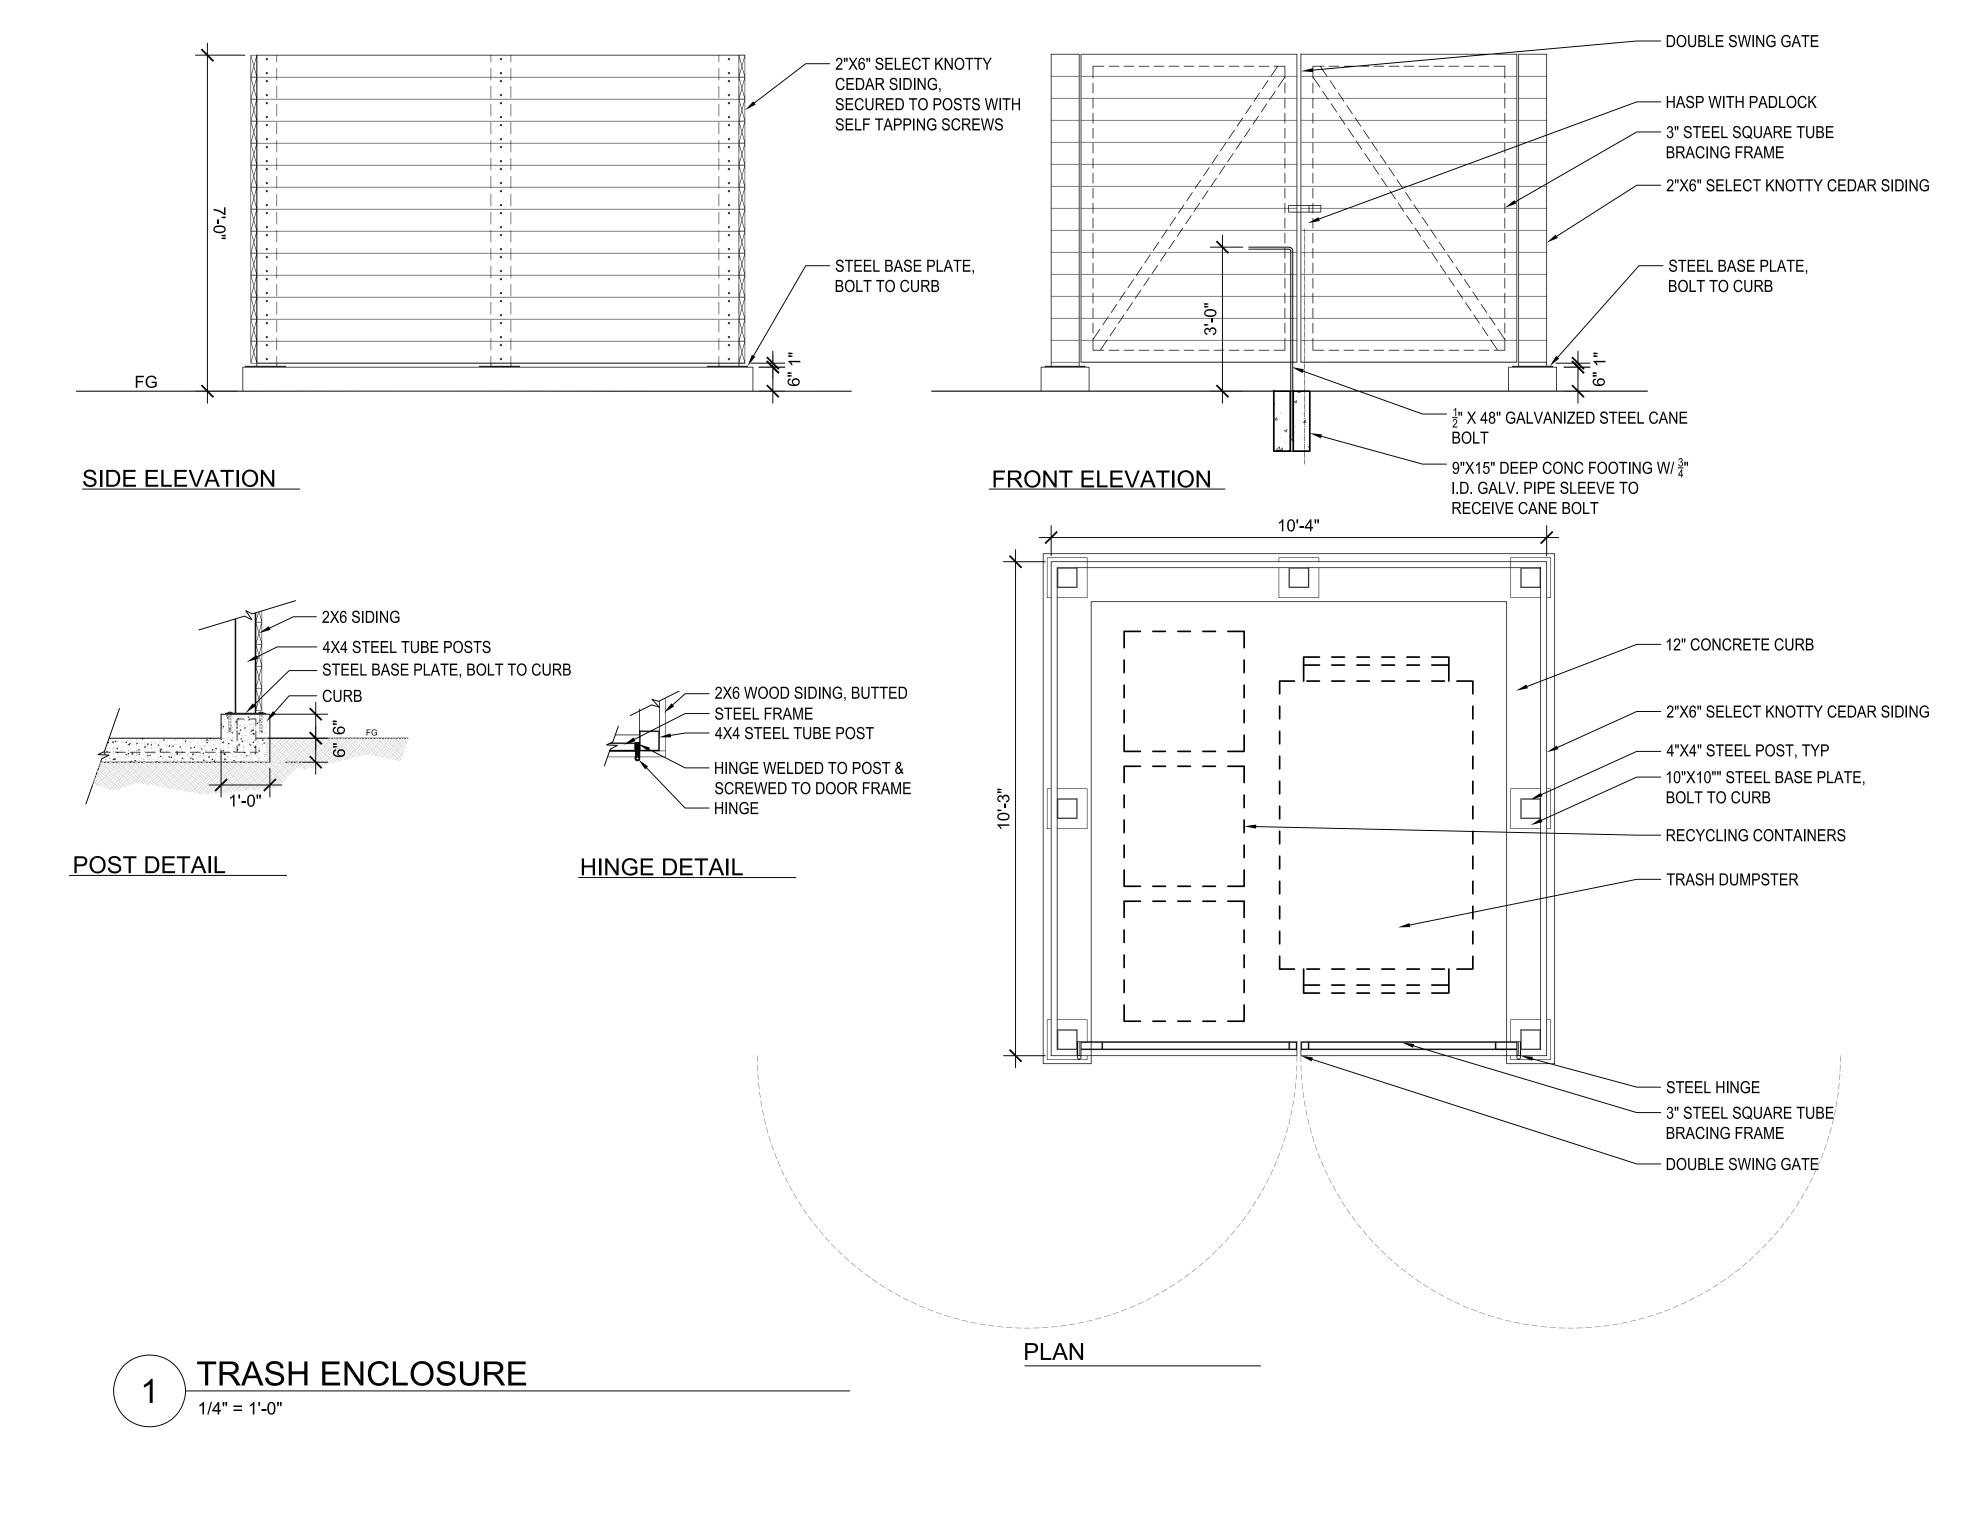

**PRODUCT REQS** 

DRINKING FOUTAIN

DOG WATERING BOWL

ACCESSIBLE

**COLOR** BLACK

**PRODUCT** 

**MATERIAL** 

STEEL

**COLOR** BLACK

RING BIKE RACK


BY LANDSCAPE FORMS

POWDER COATED GALVANIZED

**BOTTLE FILLER** 

# WOOD LED POLE LIGHT BY VALMONT STRUCTURES

#### **MATERIAL** CONCRETE & WOOD CURB WALLS WITH OYSTER SHELL PLAYING SURFACE, WOOD TOP RAIL WITH CARVED INDENTATIONS TO RECEIVE **BOCCE BALLS**

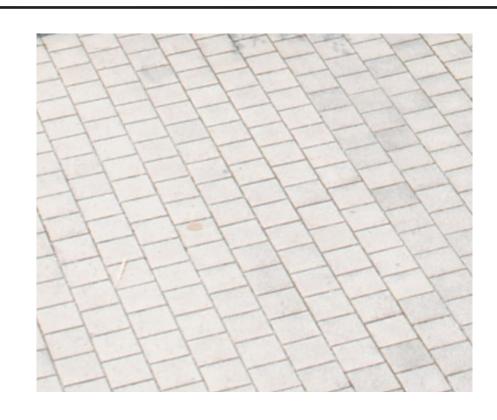

**MATERIAL** PERMEABLE PAVERS TO BE AQUA VIA II BY ACKERSTONE



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SCALE


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**CHECKED BY:** 

SITE MATERIALS

DRAWN BY:

**BOCCE BALL COURT** 

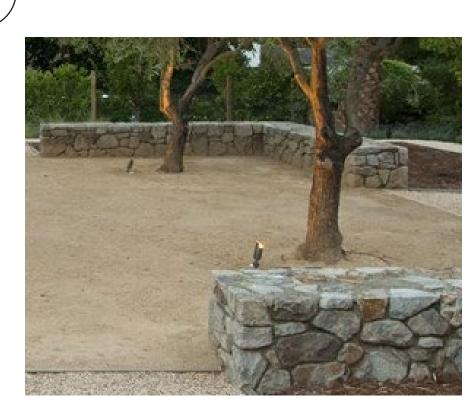

**MATERIAL** STONE MORTARED TO PIP CONCRETE




**ENTRY PLAZAS** 

**PARKING LOT** 

**MATERIAL** PERMEABLE ASPHALT

> **ALTERNATE** STANDARD **ASPHALT**

STONE WALLS

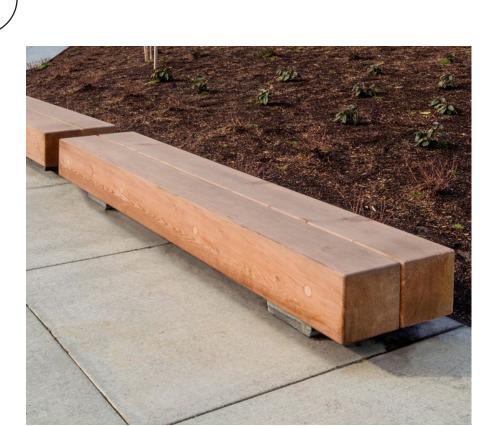

**PRODUCT GIANT TIMBER SEAT** BY TIMBERFORM

**MATERIAL** DOUGLAS FIR SLAT WITH GALVANIZED STEEL FRAME

**COLOR** STEEL - BLACK



PERMEABLE PATHS

**MATERIAL** 

**COLOR** NATURAL

GRANITECRETE

SEAT



**PRODUCT** GREENWAY PICNIC TABLE (STANDARD & ACCESSIBLE MODELS) BY TIMBERFORM

**MATERIALS** DOUGLAS FIR SLATS GALVANIZED STEEL FRAME

**COLOR** STEEL - BLACK



**MATERIAL** SAND STEEL POSTS


**COLOR** STEEL - BLACK


PICNIC TABLE

BIKE RACK

DRINKING FOUNTAIN

**VOLLEYBALL COURT** 

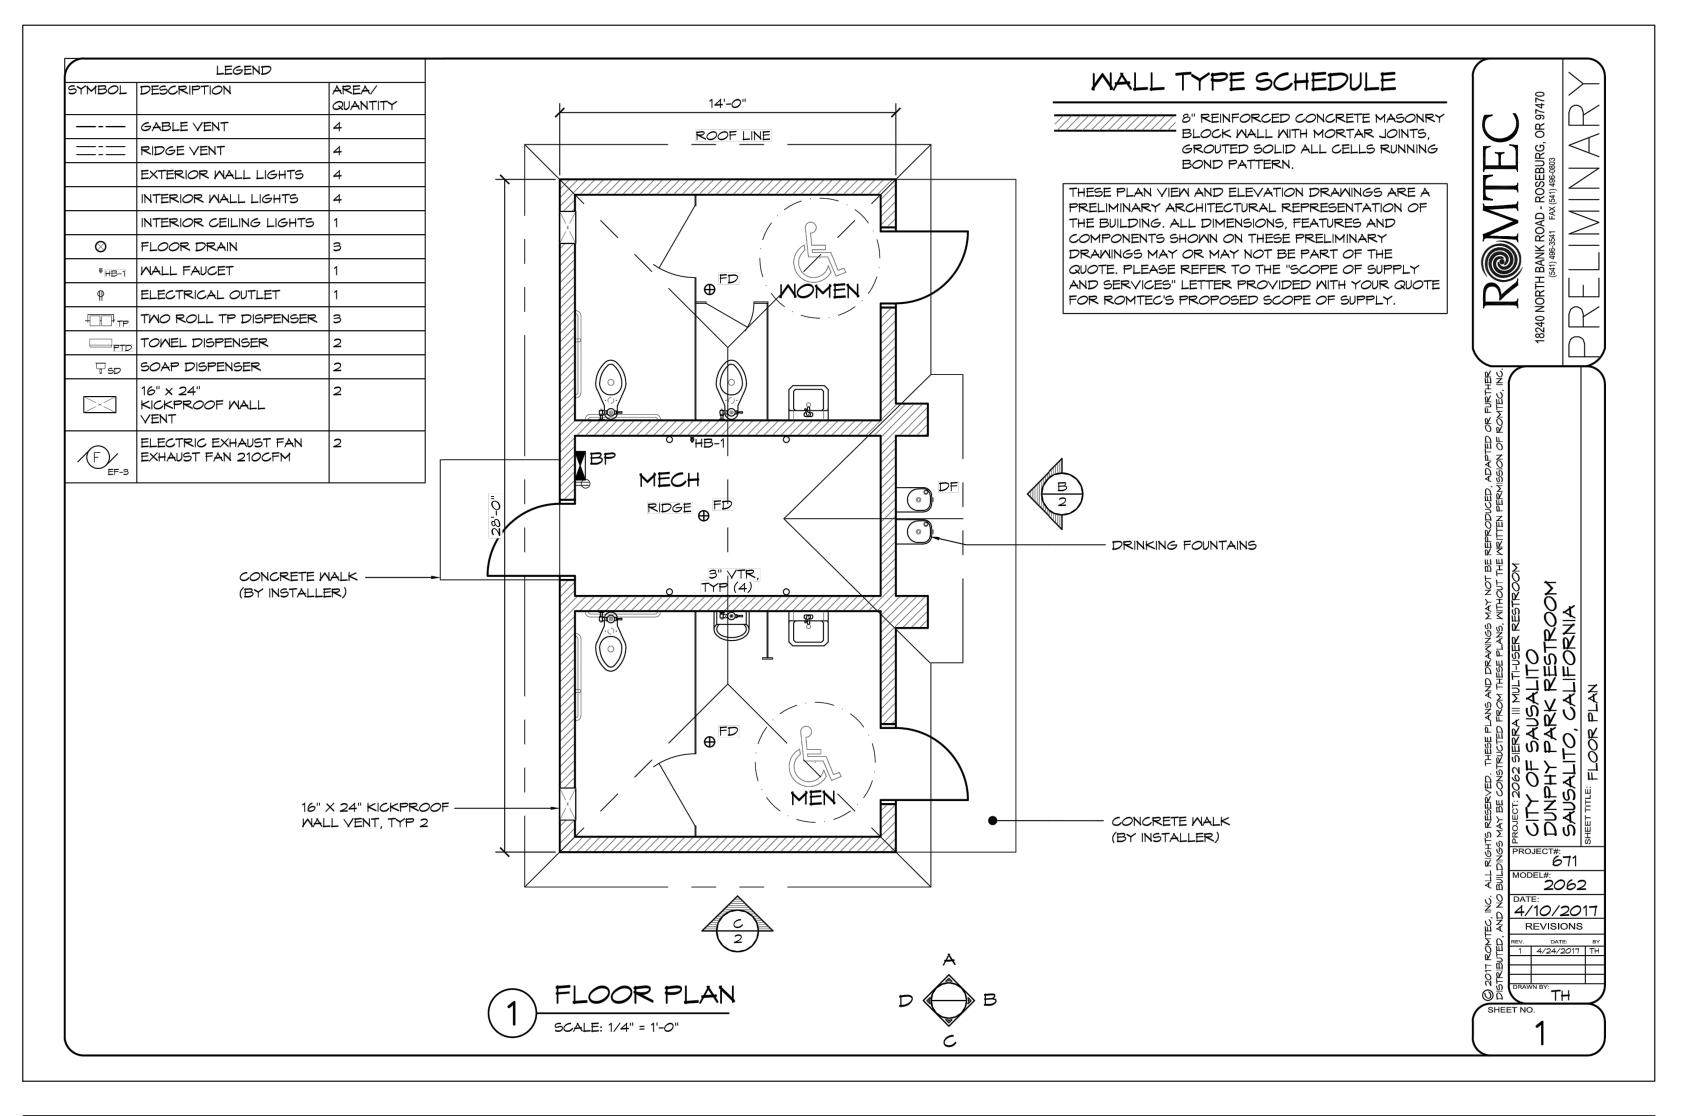

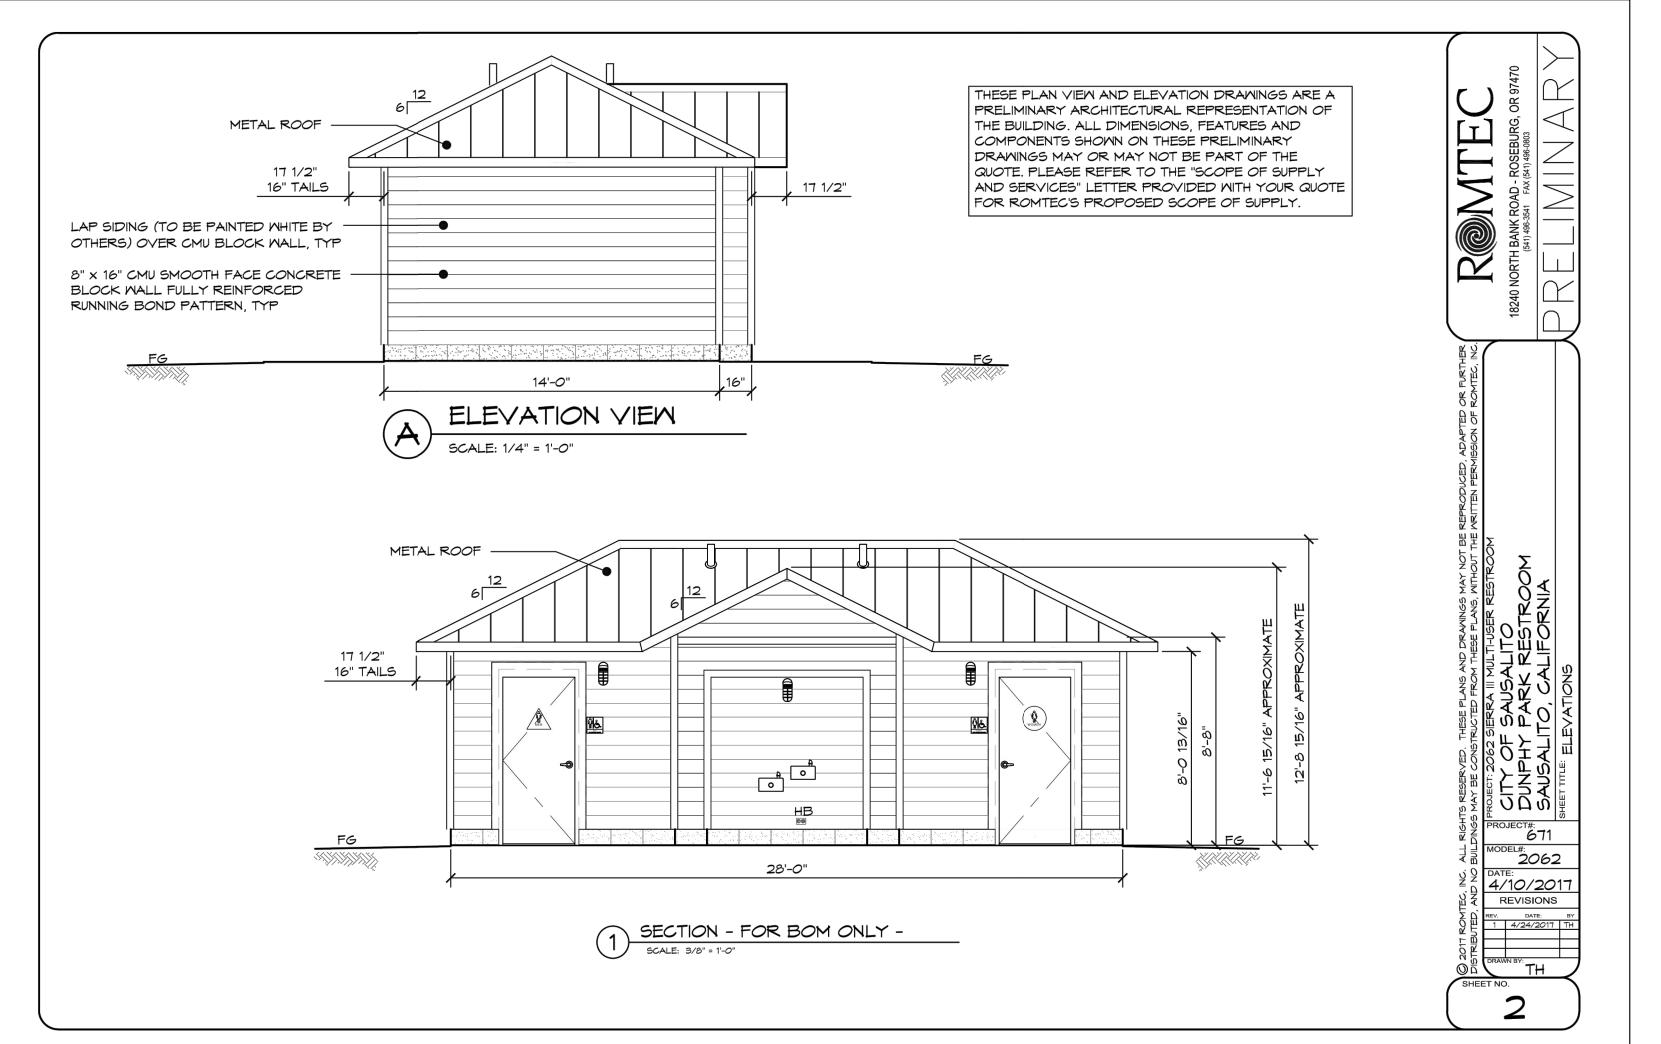

NOTES:

CUSTOMIZED RESTROOM BY ROMTEC

PLANS AND ELEVATION PROVIDED BY ROMTEC.

**EXTERIOR WALLS:** 

HORIZONTAL CLAPBOARDS, LAP SIDING OVER CMU BLOCK WALL COLOR: WHITE

ROOF

MATERIAL: METAL STANDING SEAM ROOFING COLOR: GREY

**FOUNDATION:** 

SEE CIVIL DRAWINGS FOR SEWER & WATER P.O.C.

SEE ELECTRICAL DRAWINGS FOR POWER P.O.C.

**GENERAL** 

ROMTEC TO PROVIDE ALL ARCHITECURAL, MEP & STRUCTURAL PLANS FOR FINAL APPROVAL

ROMTEC PLANS TO INCLUDE FINAL MONOLITHIC SLAB FOUNDATION PLANS.

CONTRACTOR TO INSTALL BUILDING FOUNDATION UTILITIES ROUTED THROUGH FOUNDATION, CONSTRUCTION OF ALL COMPONENTS OF BUILDING & MAKE FINAL UTILITY HOOKUP.

rhaa

LANDSCAPE ARCHITECTURE + PLANNING
225 Miller Avenue, Mill Valley, CA 94941
T 415 383 7900 F 415 383 1433 www.rhaa.com

PROJECT/CLIENT NAME

**Dunphy Park** 

Owner:

Sausalito, CA 94965

200 Napa Street

Owner:
City of Sausalito
420 Litho St.
Sausalito, CA 94965

RHAA PROJECT NUMBER

16042A

CONSULTANT

**SUBMITTAL** 

Permit Submittal

DATE

21 August 2017

REVISIONS

Date Description


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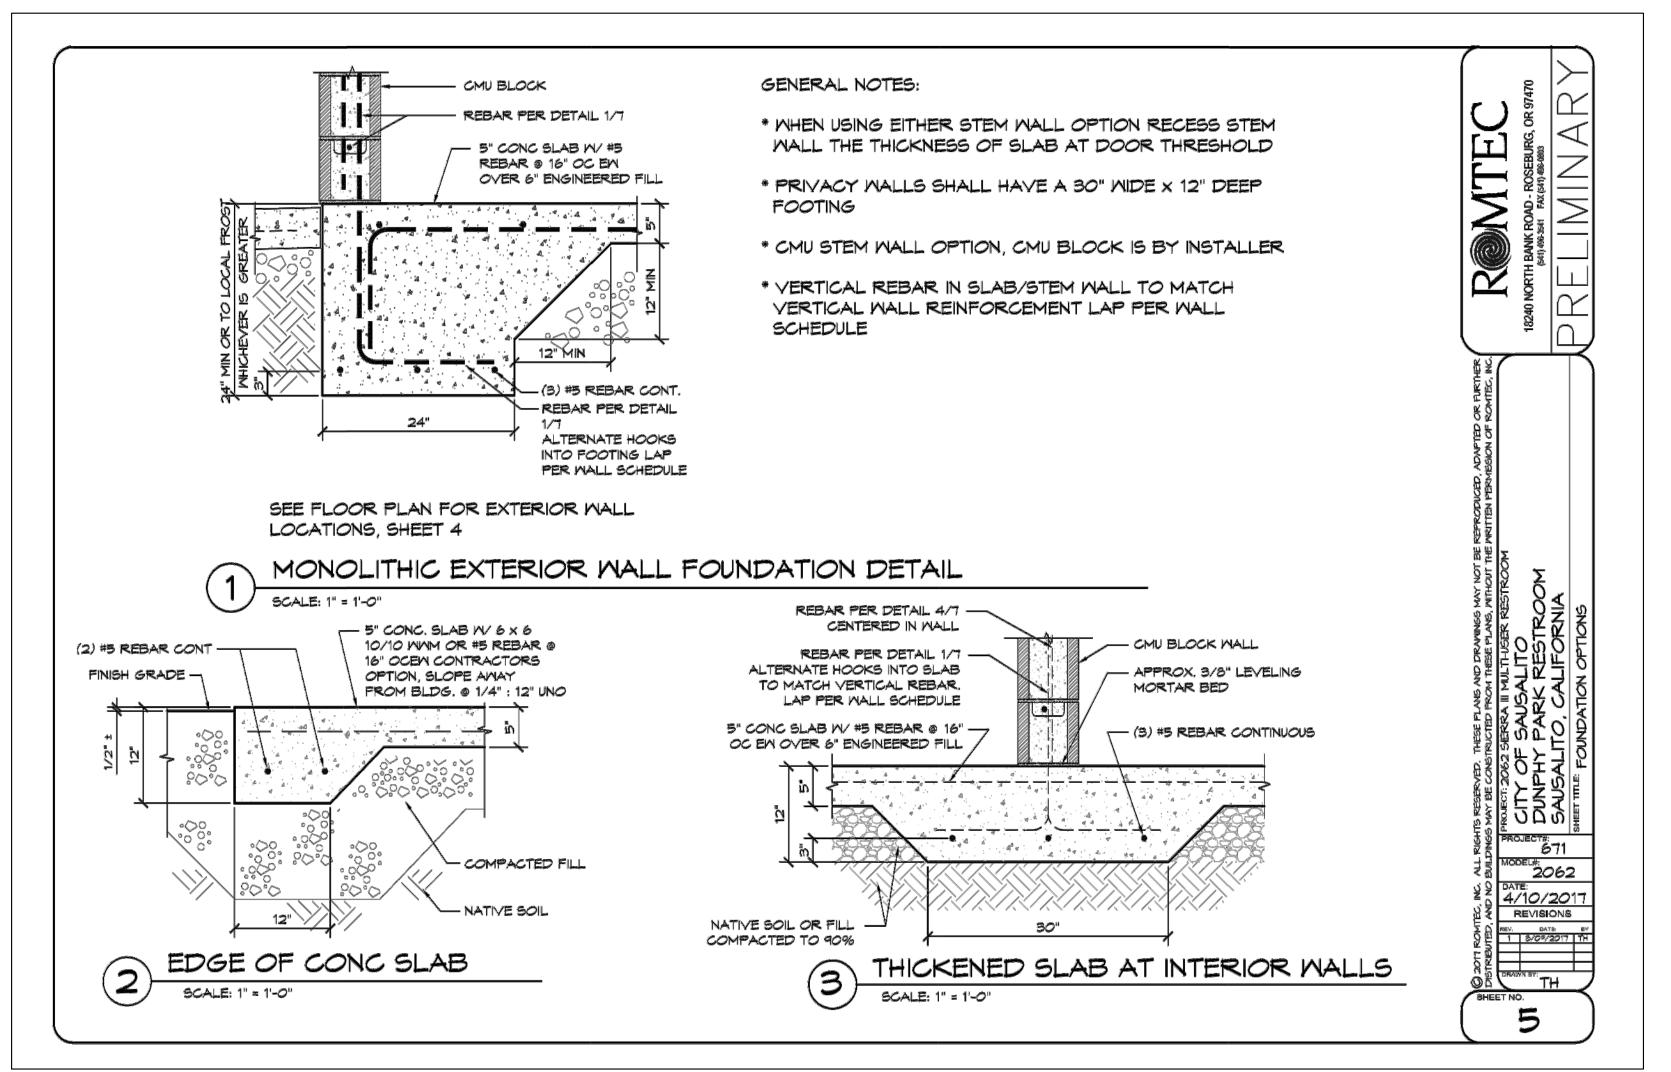
SHEET TITLE
RESTROOM
PLANS

DRAWN BY:

CHECKED BY:

**L4.5** 



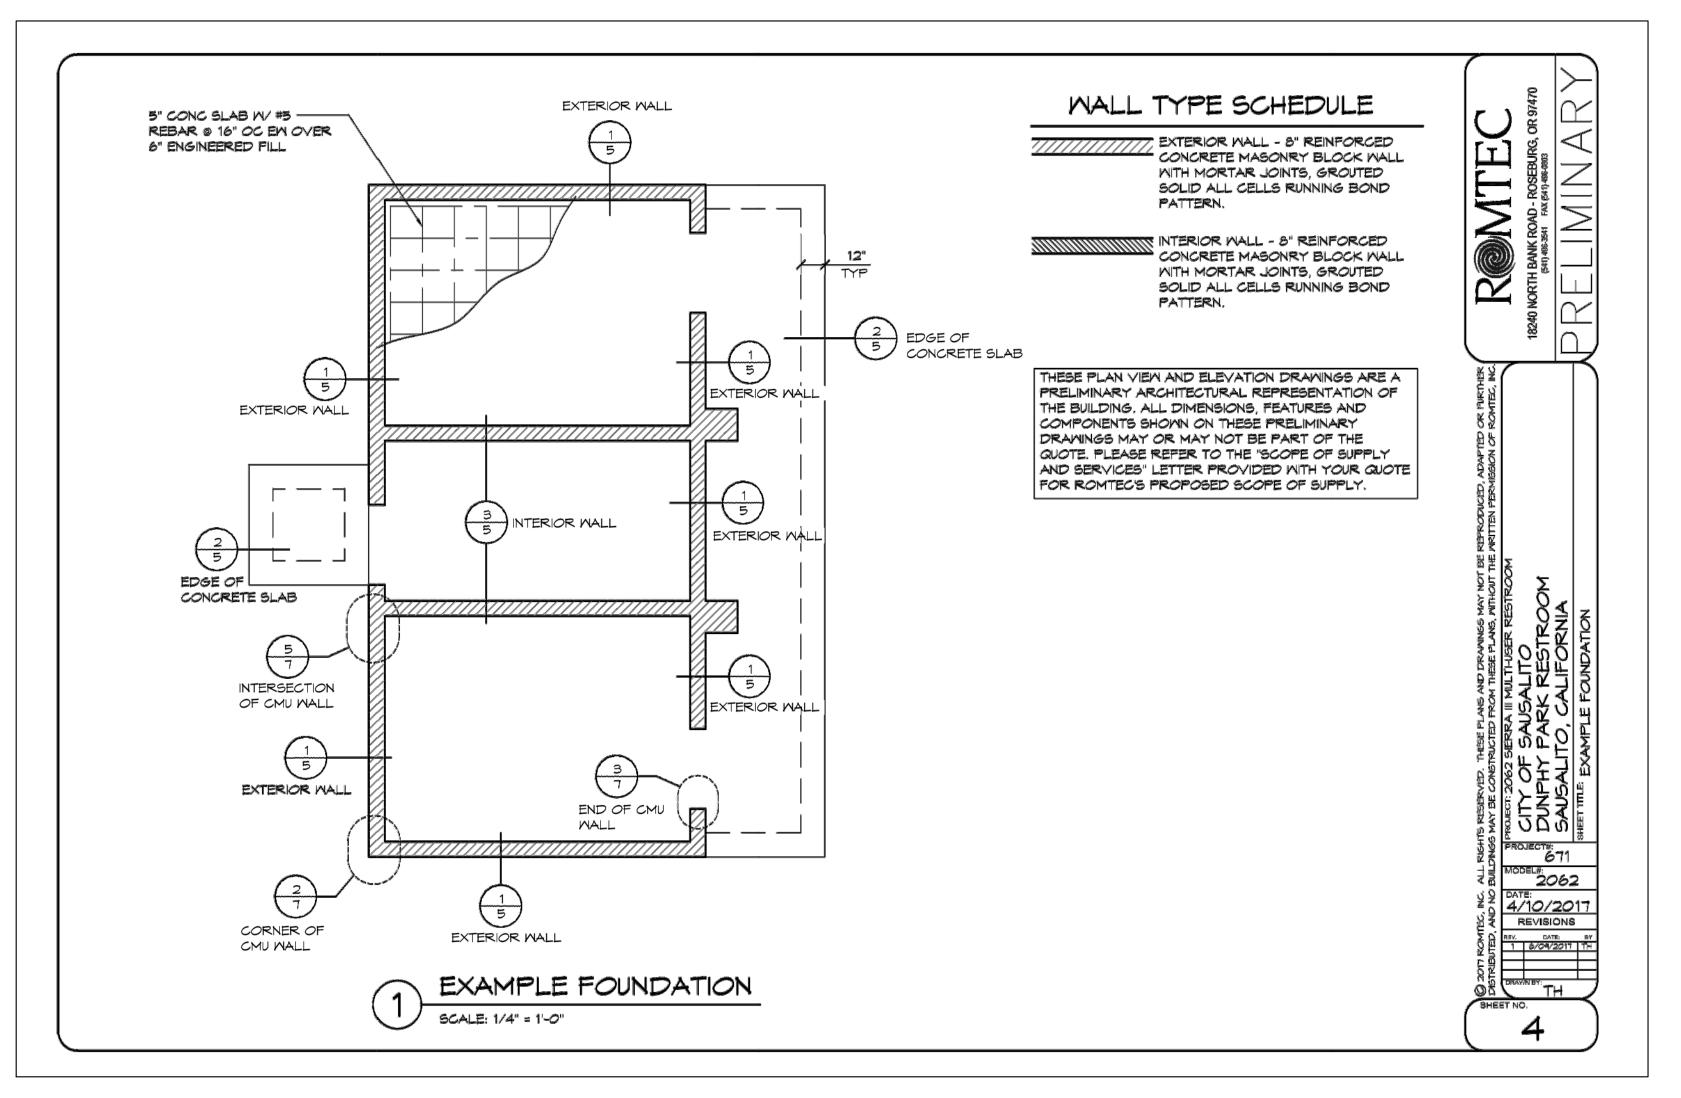

#### **NOTES:**

**CUSTOMIZED RESTROOM BY ROMTEC** 

PLANS AND ELEVATION PROVIDED BY ROMTEC.

**EXTERIOR WALLS:** 

HORIZONTAL CLAPBOARDS, LAP SIDING OVER CMU BLOCK WALL COLOR: WHITE

MATERIAL: METAL STANDING SEAM ROOFING COLOR: GREY

**FOUNDATION:** 

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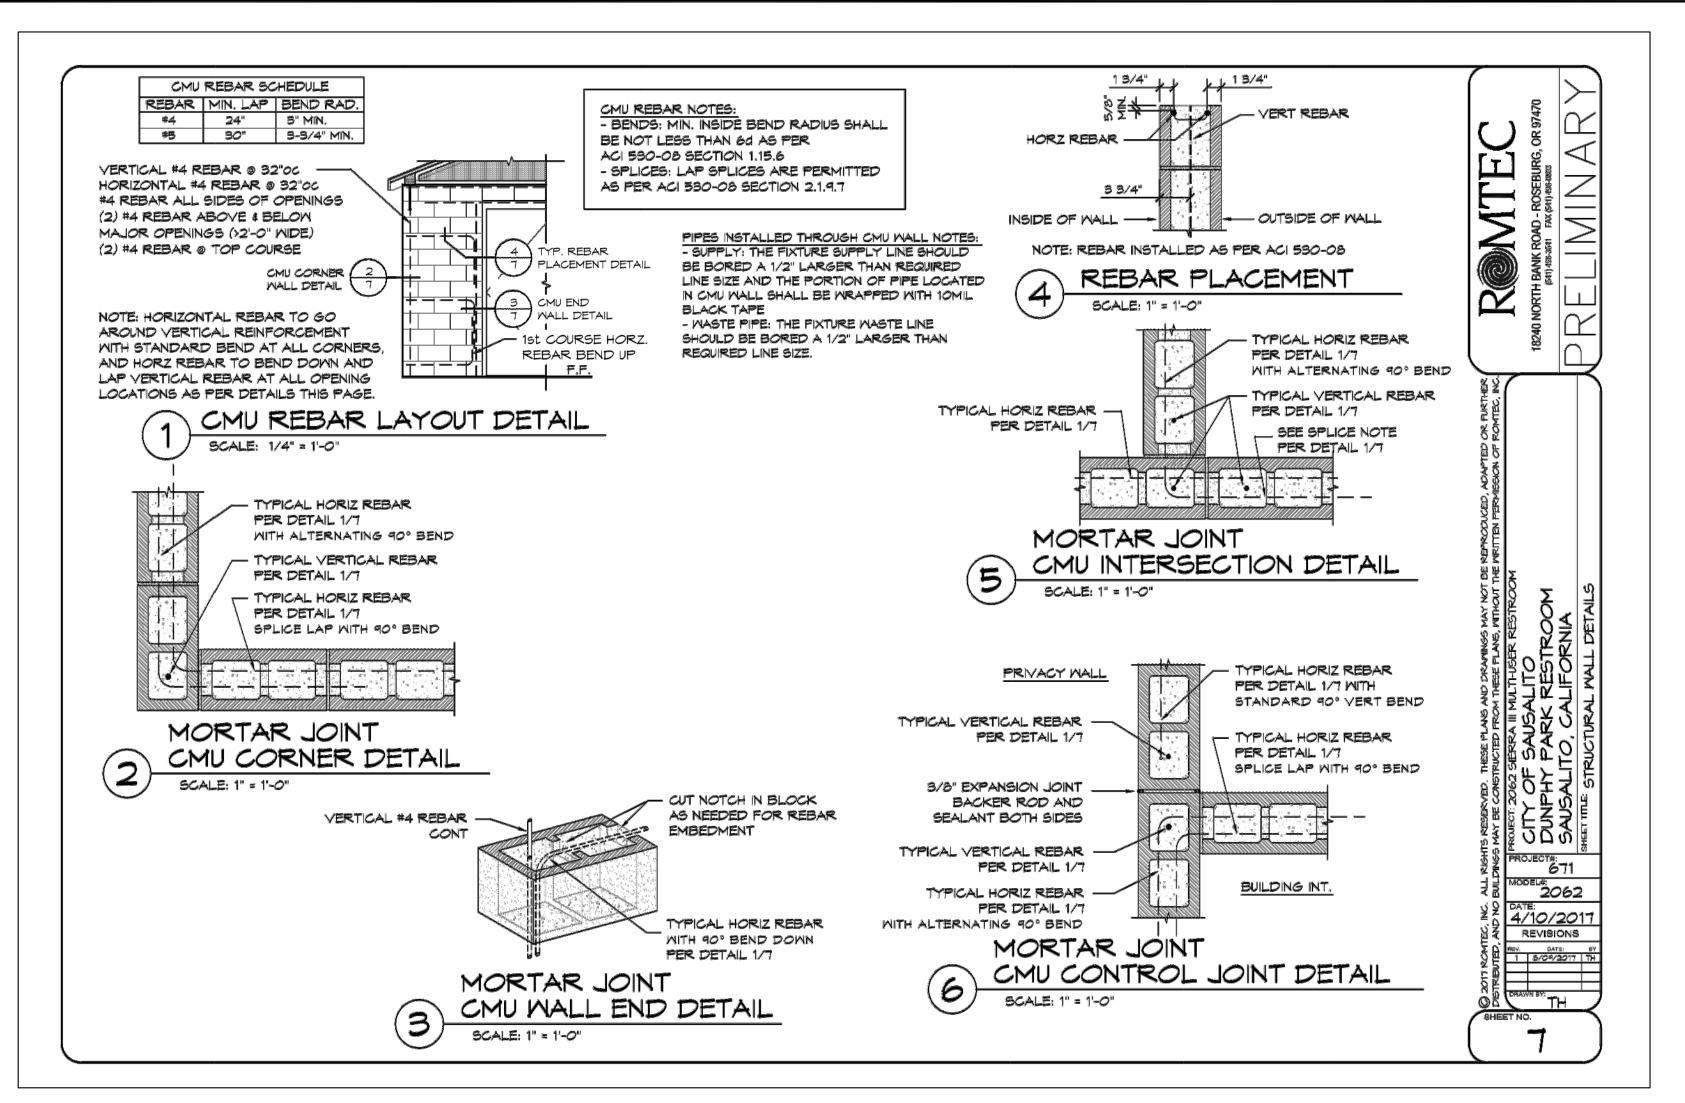
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**REGISTRATION AND SIGNATURE** 

SHEET TITLE

RESTROOM **PLANS** 

DRAWN BY:



NOTES:

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PLANS AND ELEVATION PROVIDED BY ROMTEC.

EXTERIOR WALLS:
HORIZONTAL CLAPBOARDS, LAP SIDING OVER CMU BLOCK WALL

ROOF:

MATERIAL: METAL STANDING SEAM ROOFING COLOR: GREY

FOUNDATION:

COLOR: WHITE

SEE CIVIL DRAWINGS FOR SEWER & WATER P.O.C.

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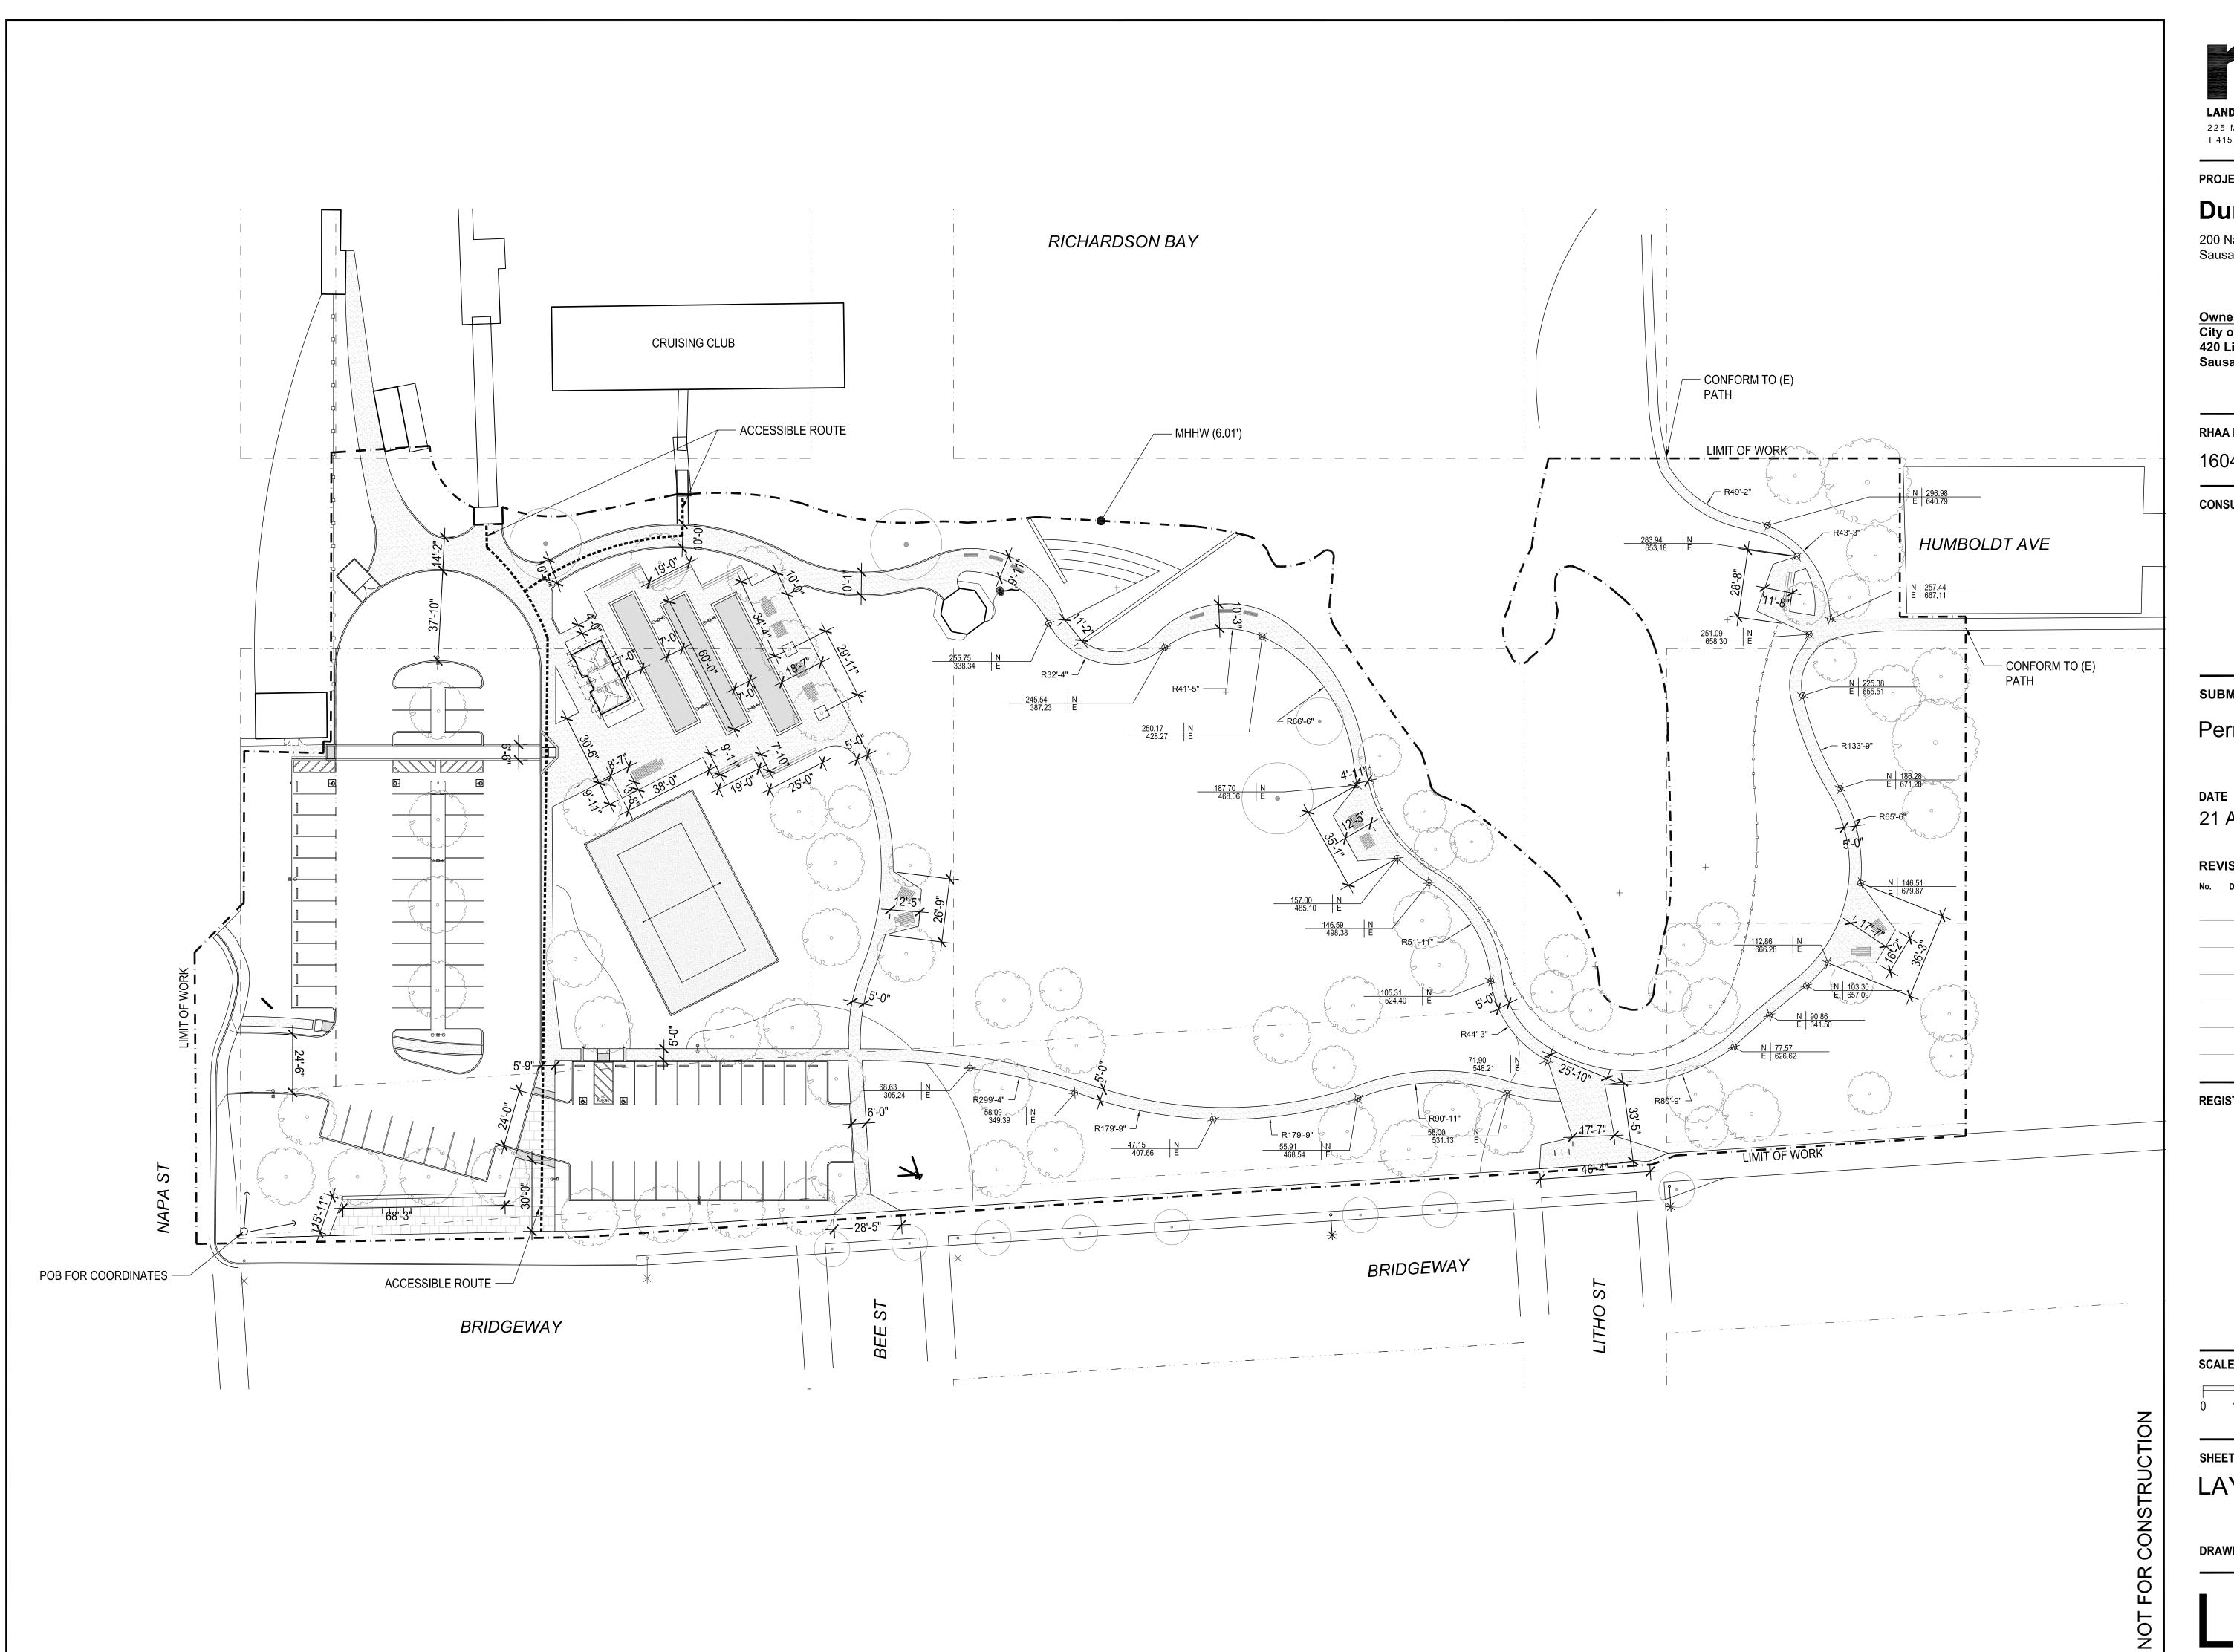
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RESTROOM PLANS

DRAWN BY

**CHECKED BY:** 

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PROJECT/CLIENT NAME

### **Dunphy Park**

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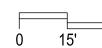
21 August 2017


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SCALE






SHEET TITLE

LAYOUT PLAN

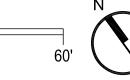DRAWN BY:

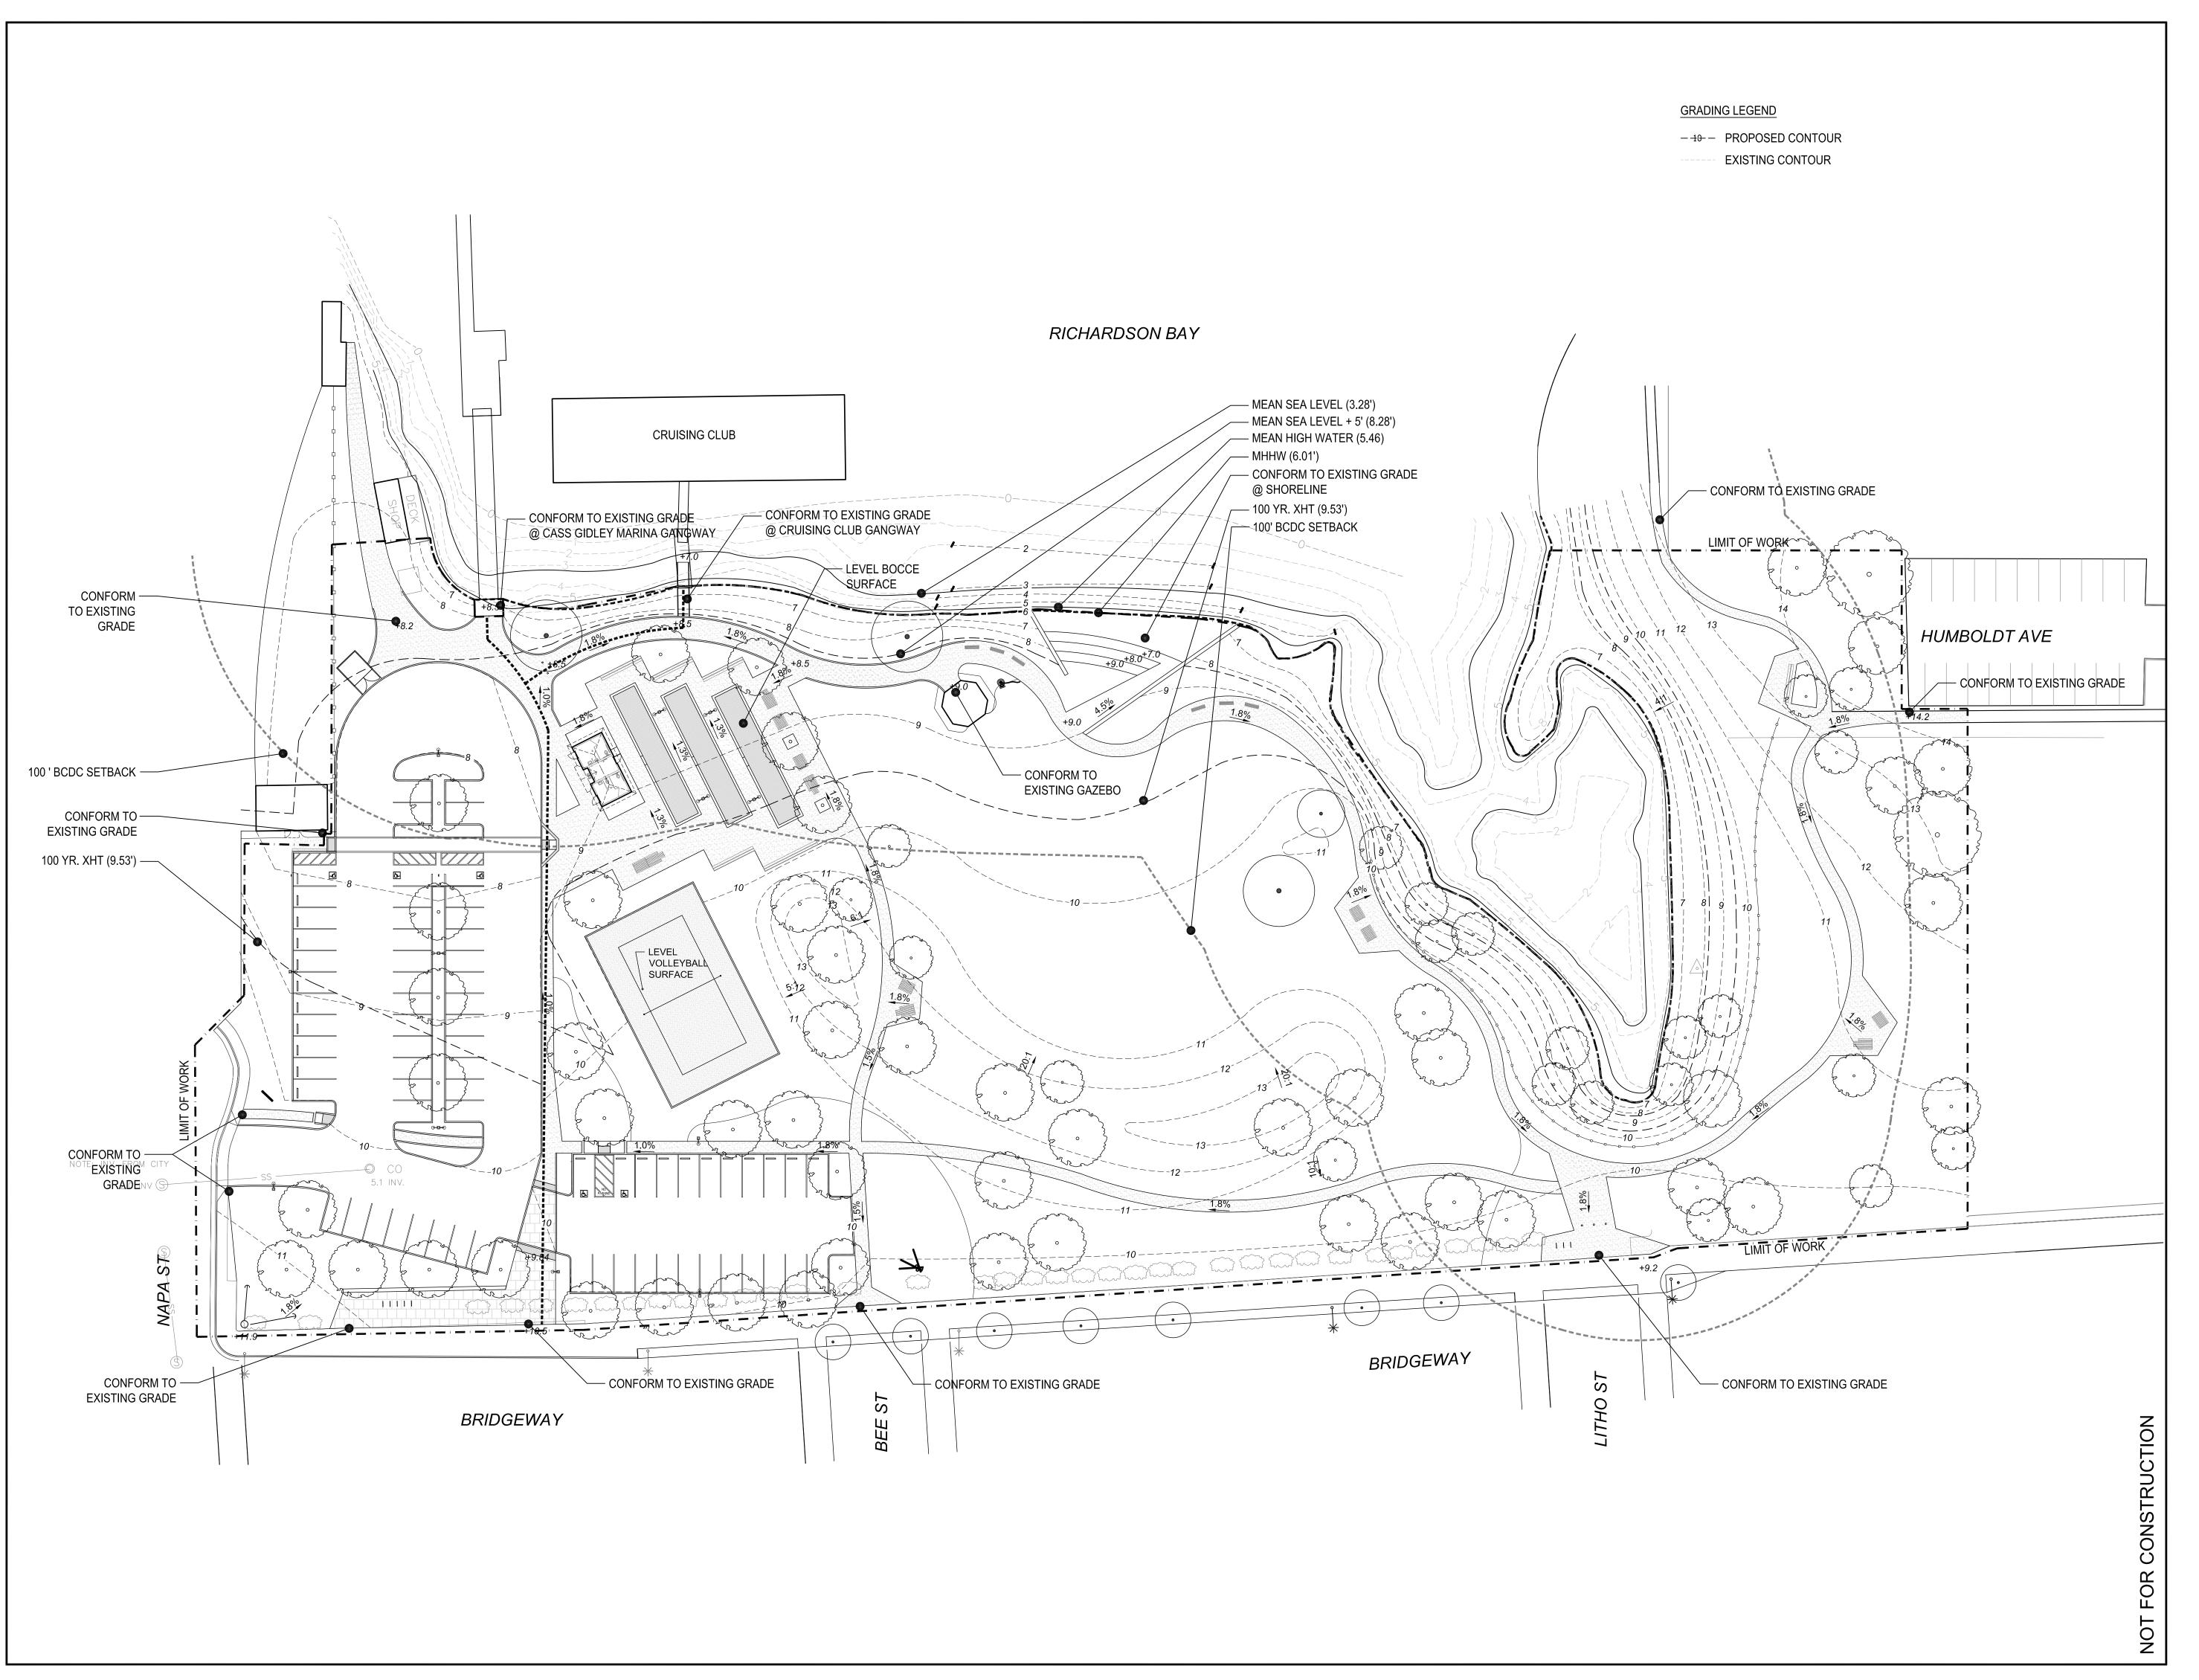



#### **Dunphy Park**

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Owner: City of Sausalito 420 Litho St. Sausalito, CA 94965

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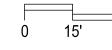
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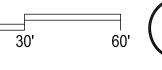
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SCALE






SHEET TITLE

**GRADING PLAN** 

DRAWN BY:

CHECKED BY:

L6.0

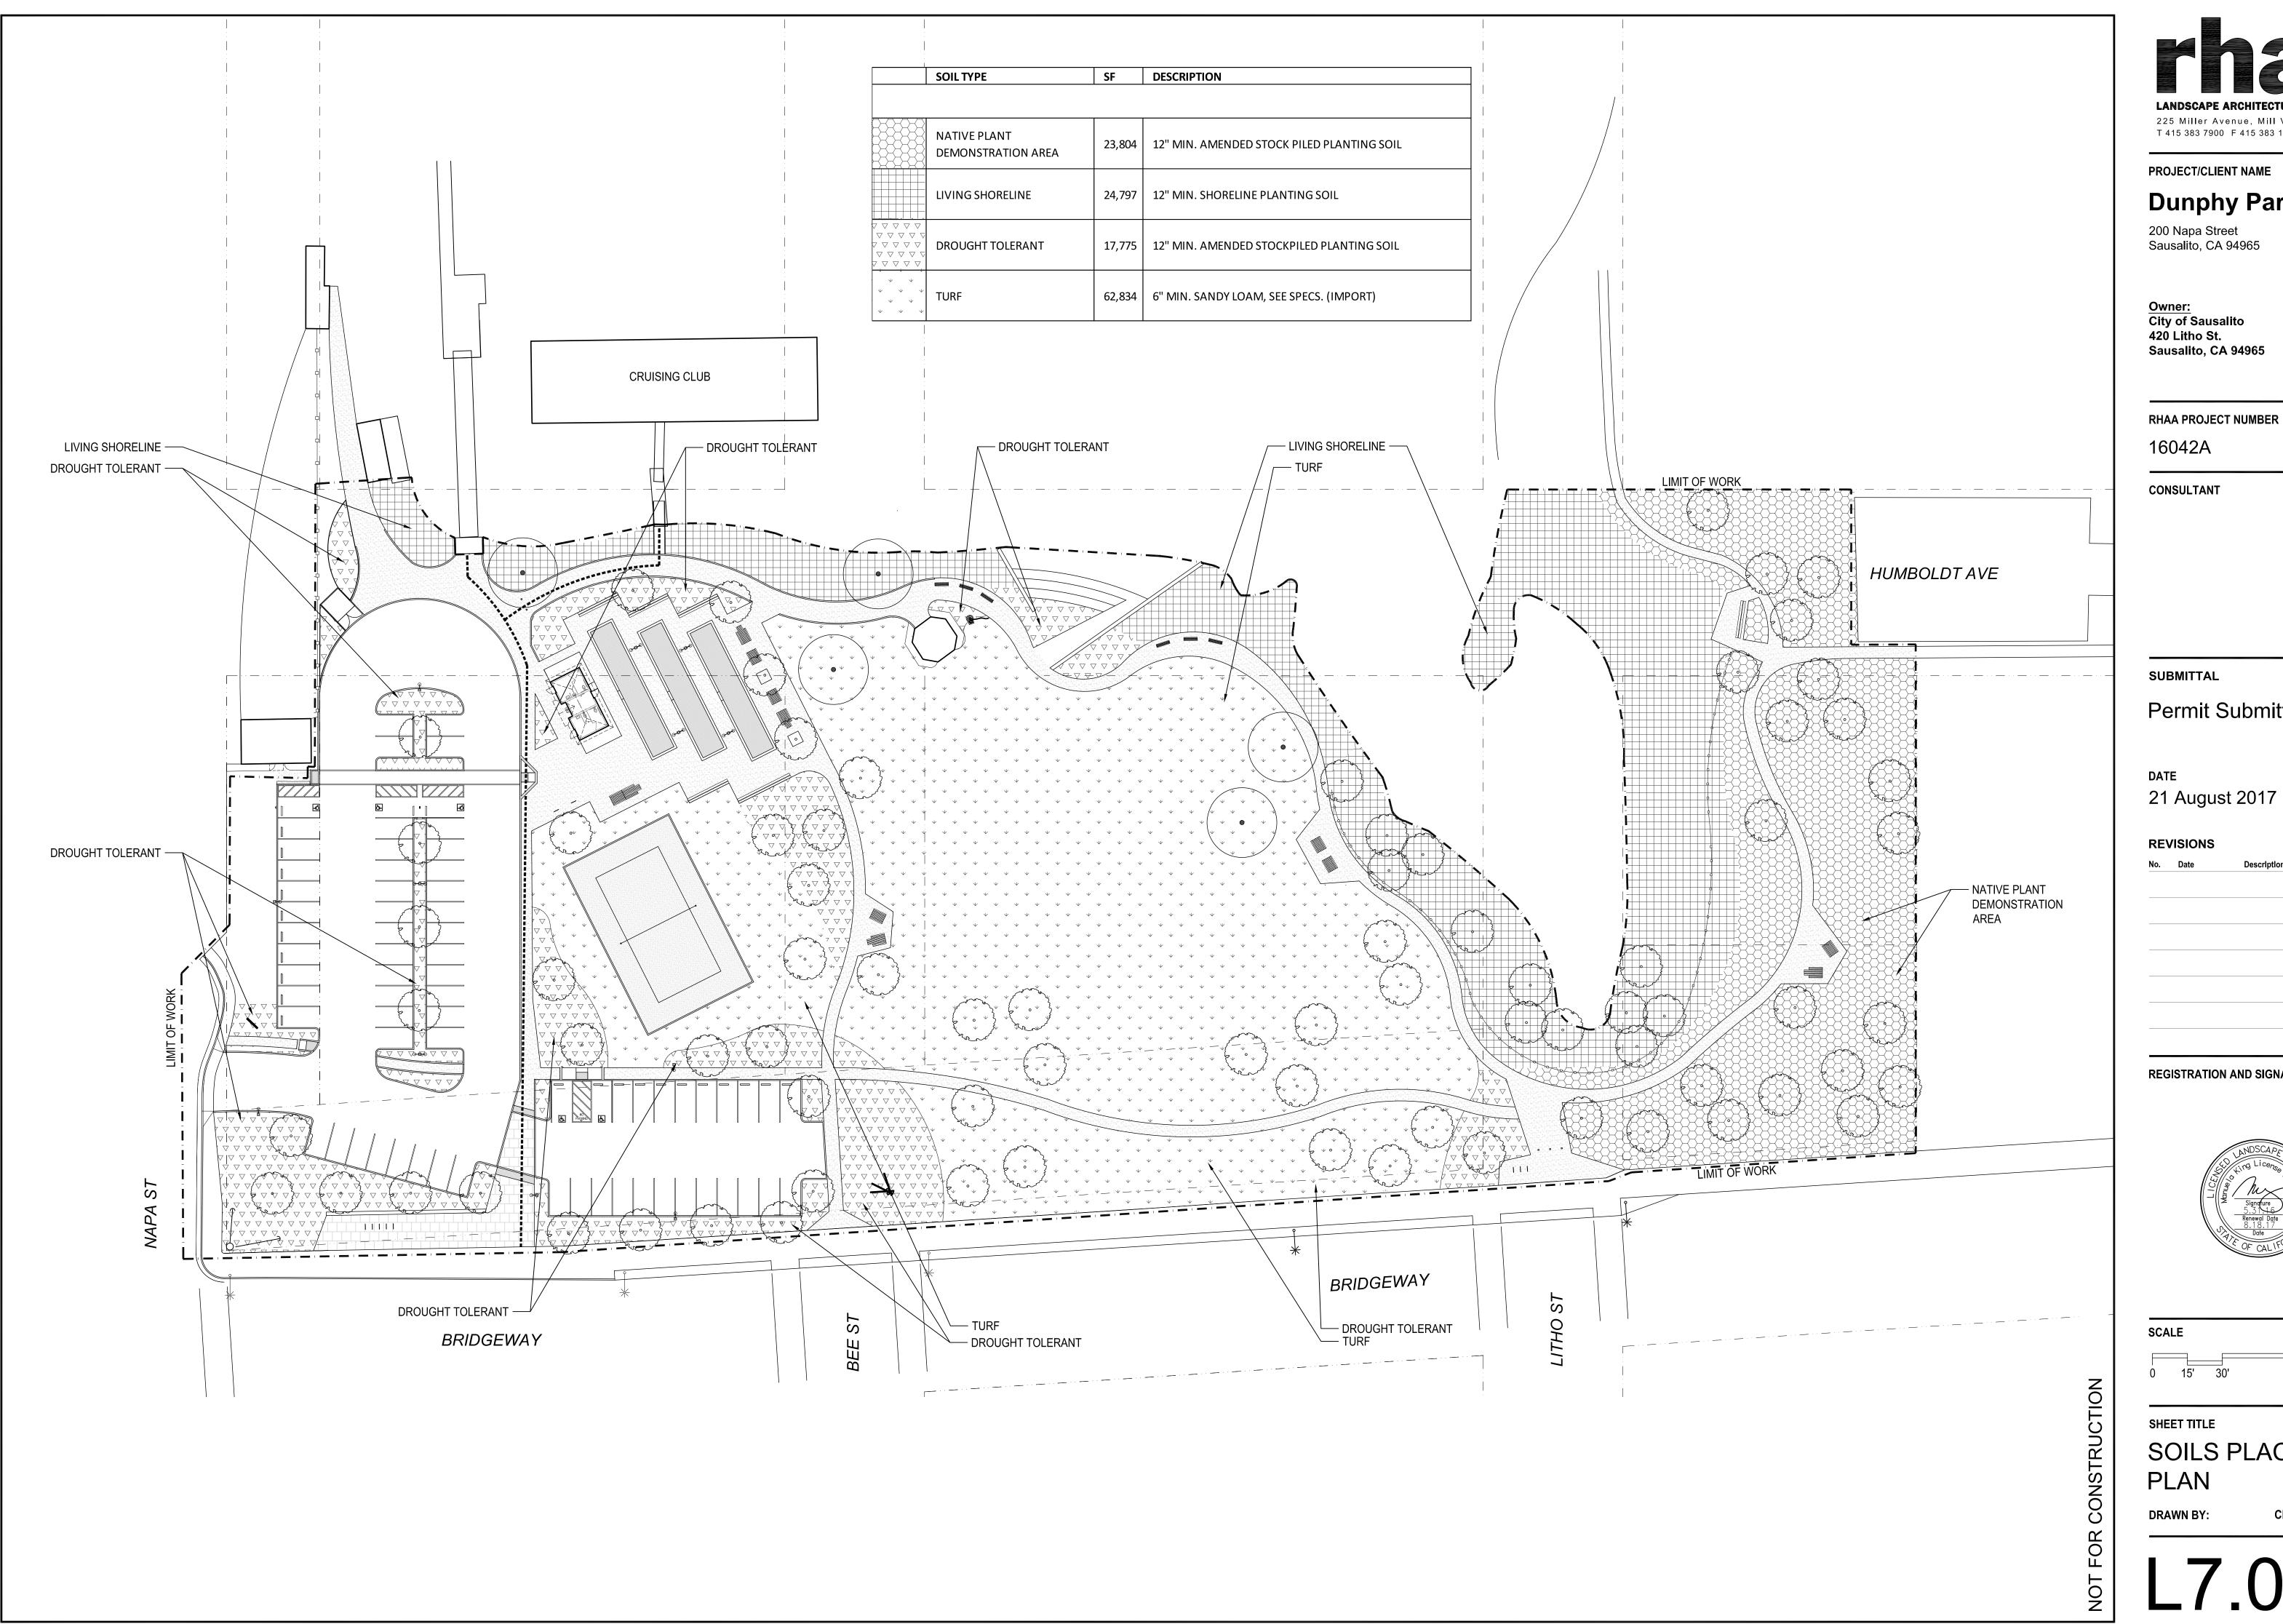



### **Dunphy Park**


Owner: City of Sausalito Sausalito, CA 94965

RHAA PROJECT NUMBER


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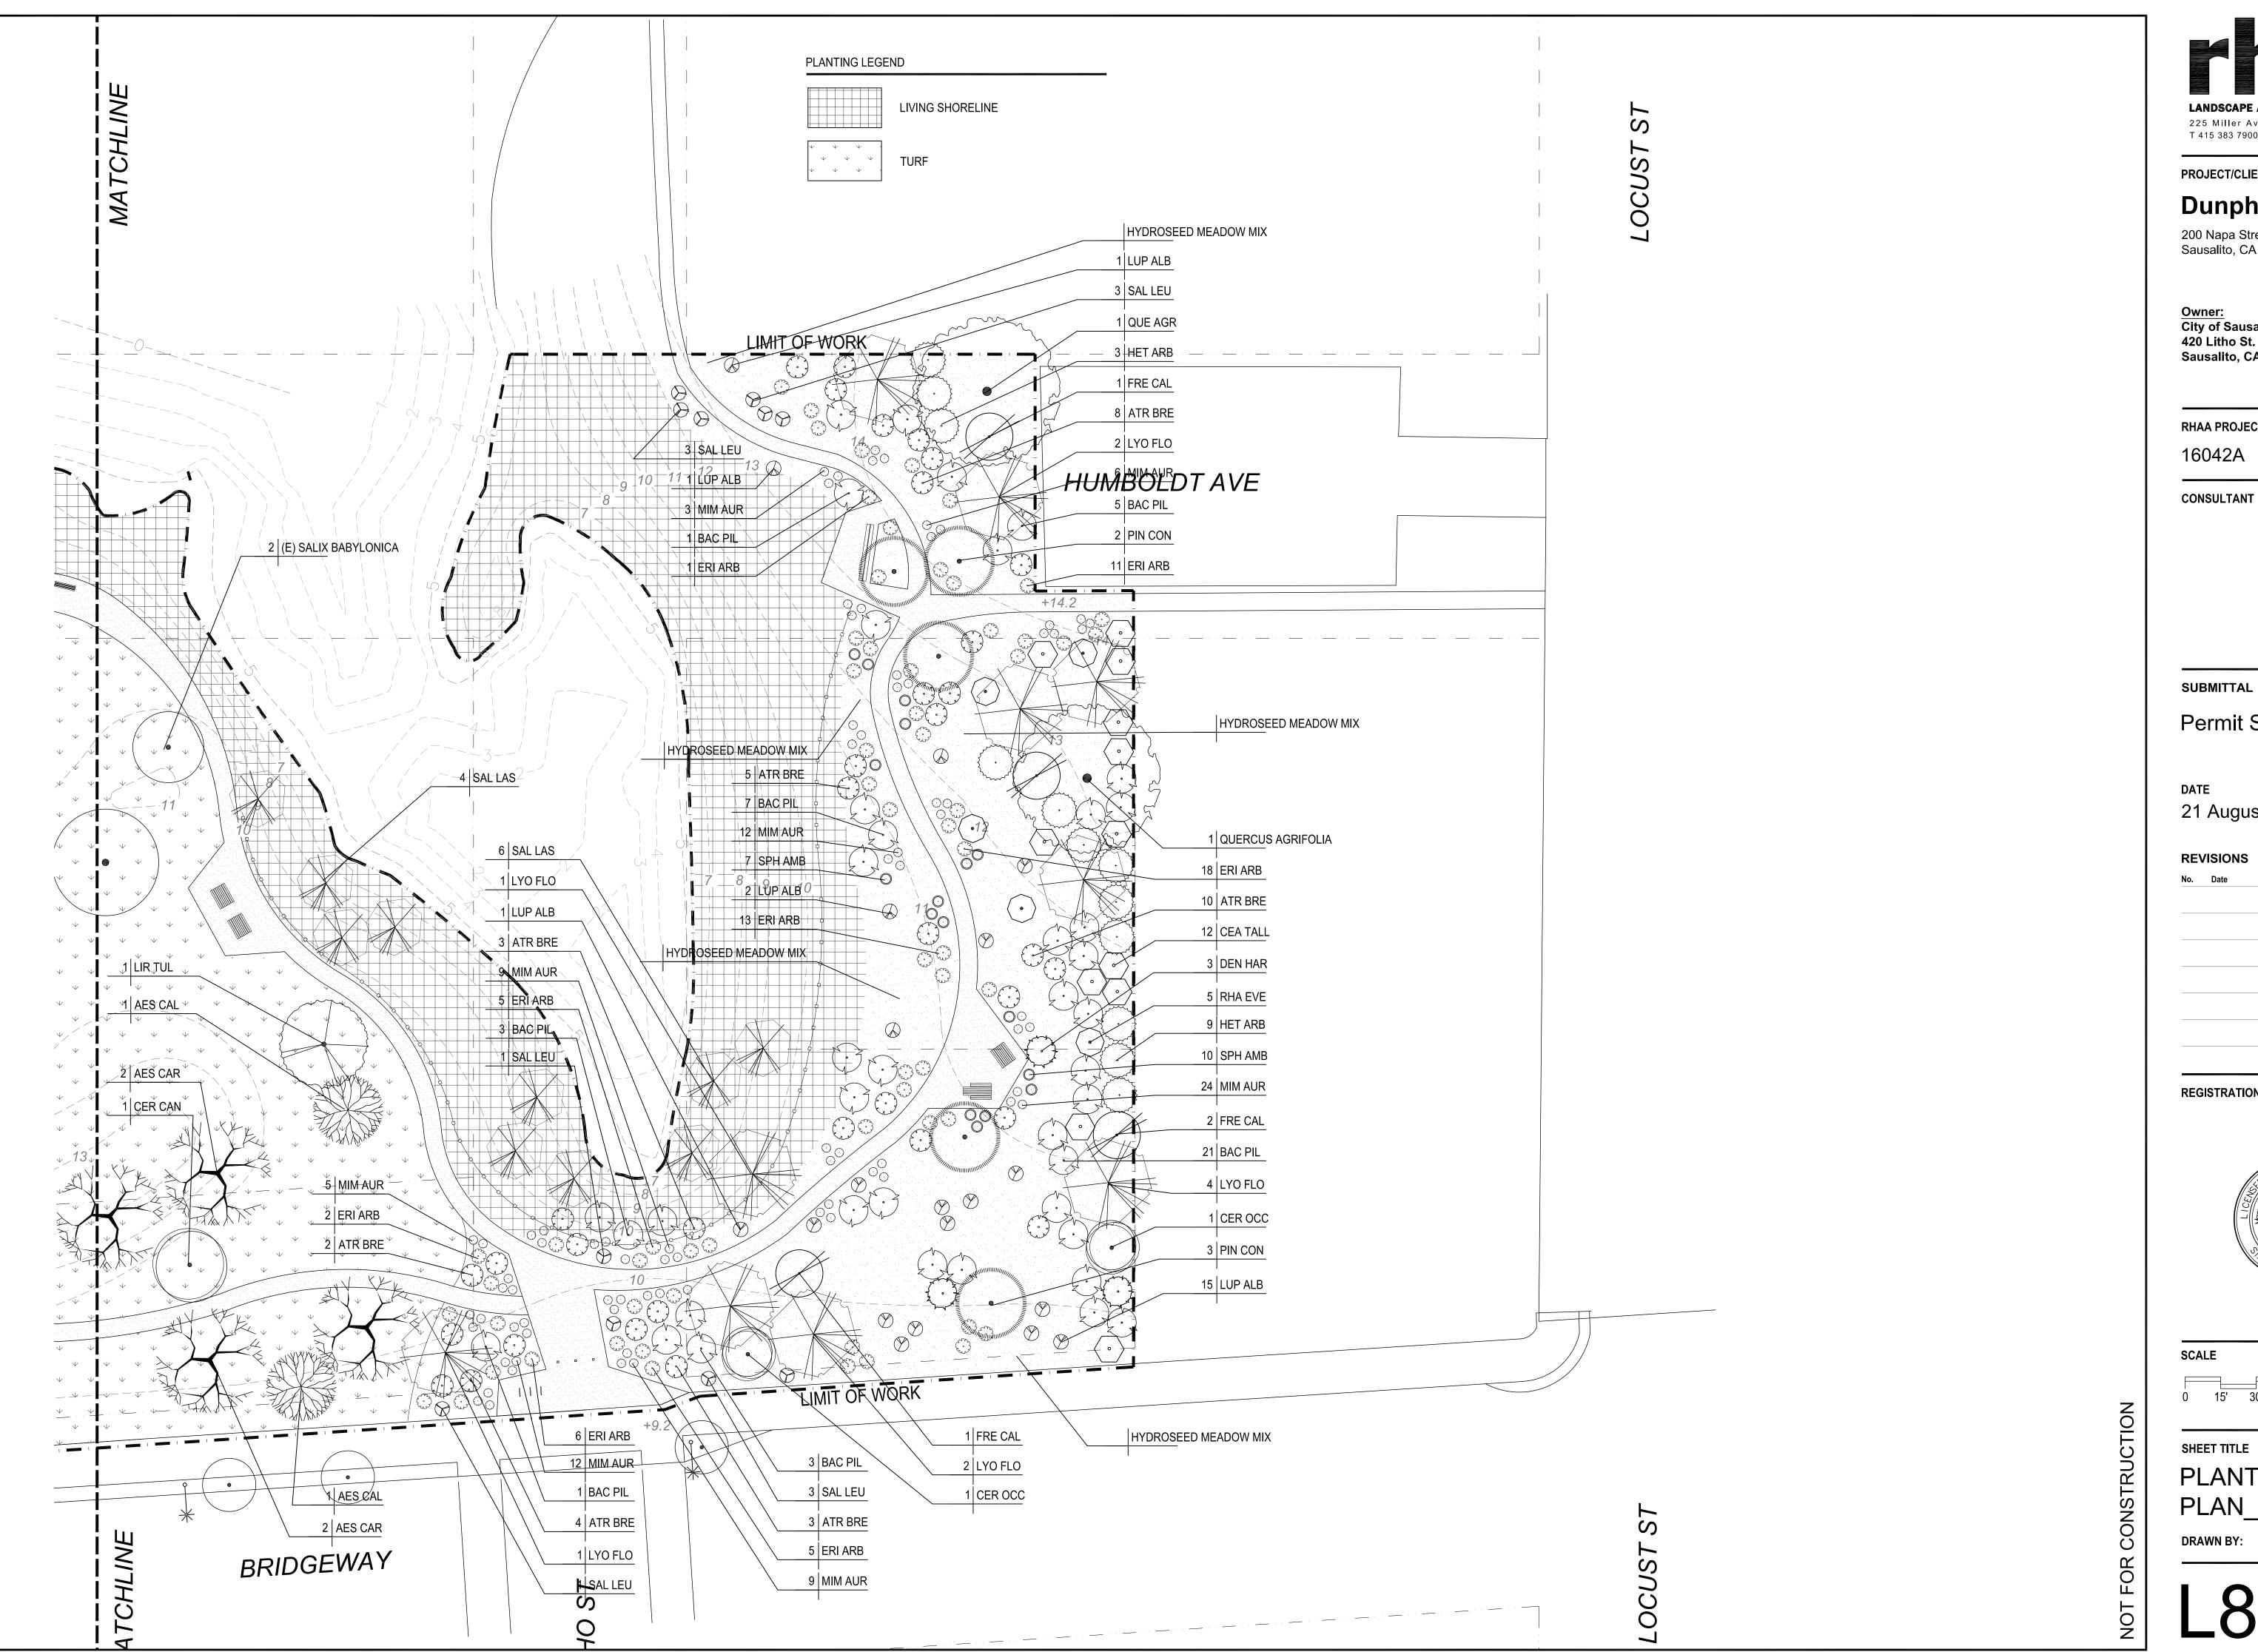
SOILS PLACEMENT



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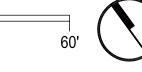
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21 August 2017
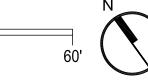
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PLANTING PLAN\_Park West

DRAWN BY:

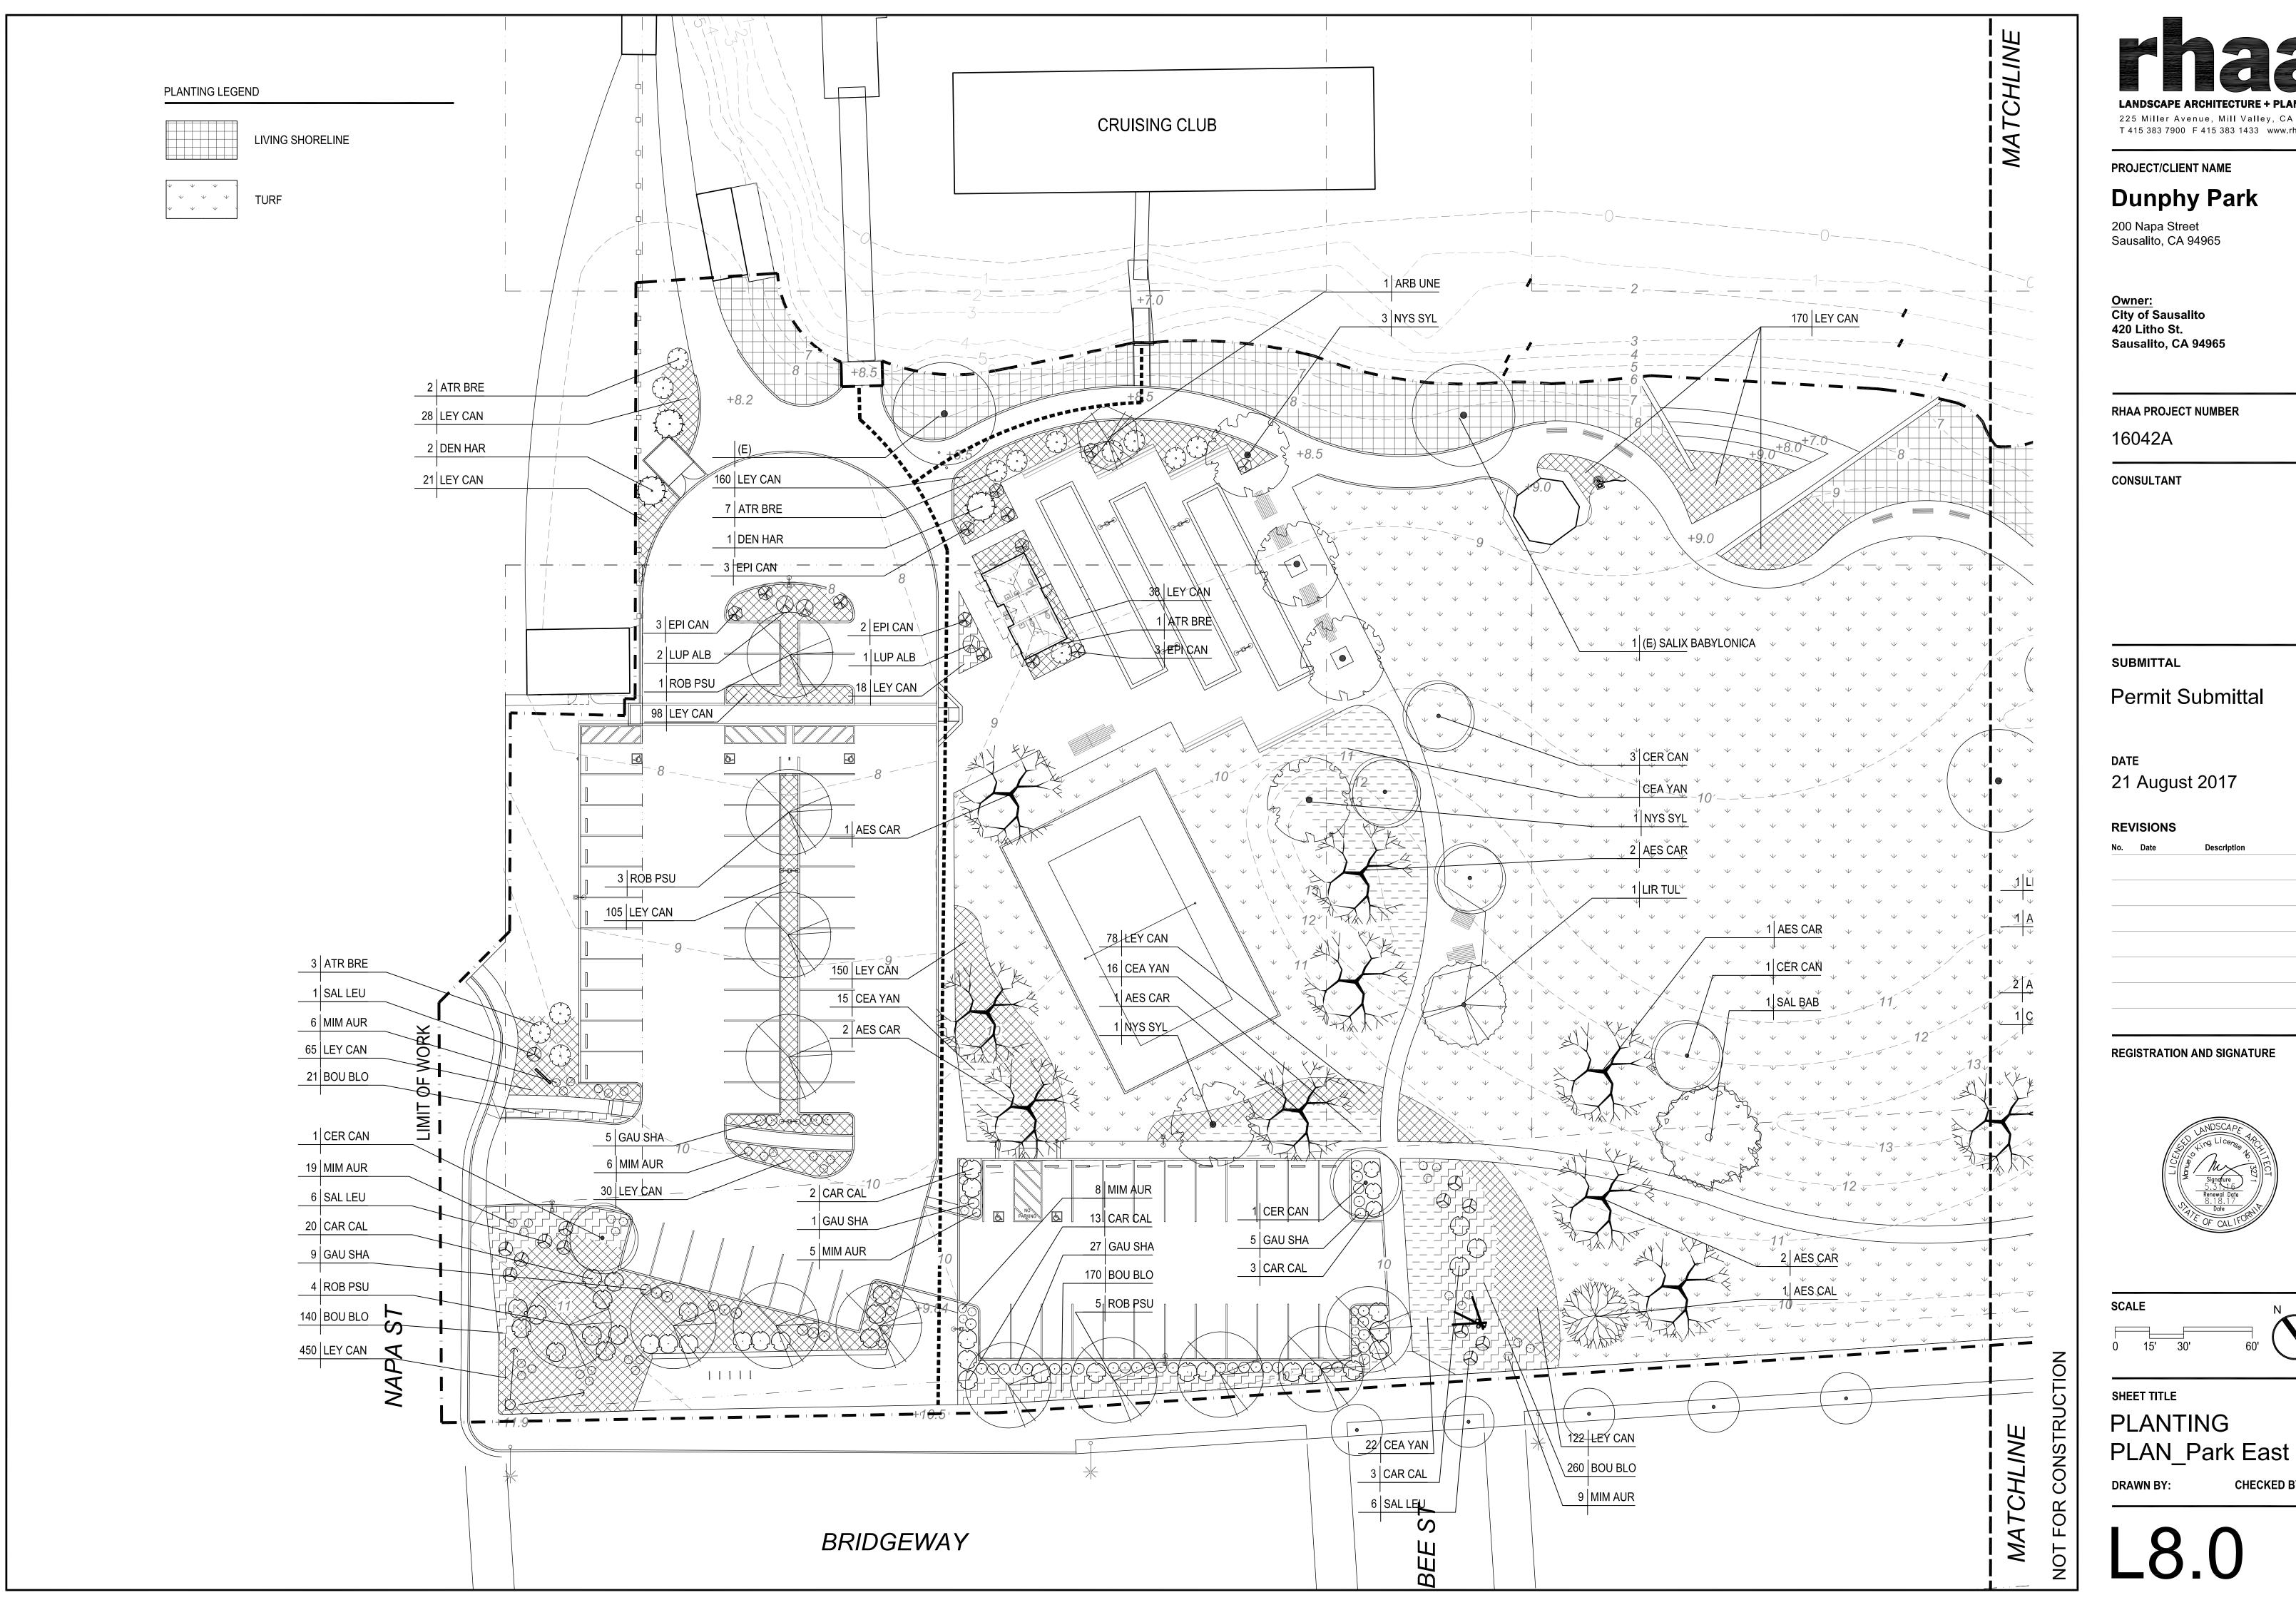SYMBOL	SCIENTIFIC	COMMON	HEIGHT	SPREAD	Native (y/n)	Water Use	Source	SIZE	SPACE	QTY
	SHRUB									
	Atriplex lentiformis 'breweri'	Brewer Saltbush	5'-7'	6'-8'	Υ	Low	BCDC	15G	SEE PLAN	48
-	Arctostaphylos densiflora 'Howard McMinn'	Howard McMinn Manzanita	6-10'	6-12'	Υ	Low	FODP	15G	SEE PLAN	-
$\bigcirc$	Baccharis pilularis	Coyote Brush	3'-9'	3'-12'	Υ	Low	FODP	5G	SEE PLAN	41
0	Carpenteria californica	Bush Anemone	4'-6'	4'-6'	Υ	Low	FODP	15G	SEE PLAN	41
$\odot$	Ceanothus 'Cynthia Postan'	Cynthia Postan Wild Lilac	6'-8'	6'-8'	Υ	Low	FODP	15G	SEE PLAN	12
$\odot$	Dendronmecon harfordii	Island Bush Poppy	8-12'	8-12'	Υ	Low		15G	SEE PLAN	6
8	Epilobium canum 'Catalina'	California fuchsia	3'-4'	4'-5'	Υ	Very Low	BCDC	5G	SEE PLAN	13
0	Eriogonum arborescens	Santa Cruz Island Buckwheat	2'-6'	3'-5'	Υ	Low	BCDC	5G	SEE PLAN	64
-	Eriogonum latifolium	Coast Buckwheat	1'	3'	Υ	Low	BCDC	5G	SEE PLAN	-
-	Eriogonum umbellatum	Sulphur Buckwheat	1'	3'	Υ	Low		5G	SEE PLAN	-
Ø	Fremontodendron californicum	Flannel Bush	15'-20'	10-15'	Υ	Low	BCDC	24" Box	SEE PLAN	4
0	Gaultheria shallon	Salal	4'-10'	6'-12'	Υ	Moderate	BCDC	15G	SEE PLAN	48
0	Heteromeles arbutifolia	Toyon	6'-10'	6'-10'	Υ	Low	FODP	15G	SEE PLAN	11
<b>⊗</b>	Lupinus albifrons	Silver Bush Lupine	5'	5'	Υ	Low	BCDC	5G	SEE PLAN	23
0	Mimulus auranticus	Sticky Monkey Flower	2'	2'-3'	Υ	Low	BCDC	5G	SEE PLAN	133
$\odot$	Rhamnus californica 'Eve Case'	Coffee Berry	4'-8'	4'-8'	Υ	Low	BCDC	15G	SEE PLAN	5
8	Salvia leucophylla	Purple Sage	2'-3'	3'-4'	Υ	Low	BCDC	5G	SEE PLAN	24
0	Sphaeralcea ambigua	Apricot Mallow	3'-4'	2'-3'	Υ	Very Low		5G	SEE PLAN	17
	GRASS									
	Bouteloua gracilis 'Blonde Ambition'	Blonde Ambition Gramma	2'	2'	Υ	Low		1G	18" OC	609
	Leymus condensatus 'Canyon Prince'	Canyon Prince Wild Rye	4'	3'	Υ	Low	BCDC	1G	24" OC	1589
	GROUNDCOVER		•					·		
	Ceanothus 'Yankee Point'	Yankee Point Wild Lilac	2'-3'	8'-10'	Υ	Low	FODP	5G	6' OC	125
	TURF		•							
* * * * * * * * * * * * * * * * * * *	Salt-tolerant Sod	Seashore Paspalum (alt = Red	Molate Fe	escue)						62834 sqft
	LIVING SHORELINE							·		
	Salix lasiolepis	Arroyo willow	less 30'	Less 30'	Y	Low	BCDC	24" Box	SEE PLAN	10
	Baccharis douglasii (glutinosa)	Marsh Baccharis	3'	3'	Υ	Low	BCDC	15G		
	Limonium californicum	Sea Lavender	1'-2'		Υ		BCDC	5G	1	
	Distichlis spicata	salt grass			Υ		BCDC	Flats	1	24797 sqft
	Dudleya farinosa	Bluff Lettuce	1'		Υ	Low	BCDC	1G	1	•
	sarcocornia pacifica	pickleweed	1'-2'		Υ		BCDC	Flats	1	
<u> </u>										

	MEADOW GRASSES HYDROS	SEED MIX		
SYMBOL	SCIENTIFIC NAME	COMMON NAME	QUANTITY	
	HORDEUM CALIFORNICUM	CALIFORNIA BARLEY		
	MELICA CALIFORNICA	CALIFORNIA ONIONGRASS		
	NASSELLA CERNUA	NODDING NEEDLEGRASS		
	NASSELLA PULCHRA	PURPLE NEEDLEGRASS		
	POA SECUNDA	NATIVE PINE BLUEGRASS		
	CLARKIA CONCINNA	RED RIBBONS		
	GILIA CAPITATA	BLUE-THIMBLE FLOWER	23,804 SQ. FT	
	ESCHOLZIA	CALIFORNIA POPPY		
	LASTHENIA	GOLDFIELDS		
	LUPINE BICOLOR	MINATURE LUPINE		
	MADIA ELEGANS	COMMON MADIA		
	NEMOPHILA	BABY BLUE EYES		
	PHACELIA	CALIFORNIA DESERT BLUEBELLS		

YPE	SCIENTIFIC	COMMON	HEIGHT	SPREAD	NATIVE (y/n)	WATER USE	SOURCE	SIZE	QTY
REES									
	Aesculus californica	California Buckeye	15'-30'	15'-30'	Y	Low	BCDC	36" Box	3
	Aesculus x carnea	Red Horse Chestnut	to 30'	to 20'	N	Moderate		36" Box	13
	Arbutus unedo	Strawberry Tree	15'-30'	15'-30'	N	Low	FODP	24" Box	1
· ·	Cercis canadensis	Eastern Redbud	20'-30'	20'-30'	N	Moderate		24" Box	7
	Cercis occidentalis	Western Redbud	10'-15'	10'-15'	Υ	Low	BCDC	24" Box	2
	Liriodendron tulipifera	Tulip Tree	to 60'	to 30'	N	Moderate		36" Box	2
	Lyonothamnus floribundus 'aspenifolius'	Catalina Is. Ironwood	25'-35'	15'	Υ	Low	FODP	24" Box	10
	Nyssa Sylvatica	Sour Gum, Tupelo	25'-35'	20'-30'	N	Moderate		36" Box	5
C C C C C C C C C C C C C C C C C C C	Pinus contorta var. 'contorta'	Shore Pine	20'-30'	20'-30'	Υ	Low	BCDC	24" Box	5
	Robinia psuedoacacia	BlackLocust	40'-50'	30'-40'	N	Moderate		24" Box	13
John W. C.	Salix babylonica	Weeping Willow	30'-45'	30'-45'	N	Moderate	FODP	36" Box	1
	Salix lasiolepis	Arroyo willow	less 30'	Less 30'	Υ	Low	BCDC	24" Box	10
	Quercus agrifolia	Coast Live Oak	30'-45'	30'-45'	Υ	Low	FODP	36" Box	2



## **Dunphy Park**

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RHAA PROJECT NUMBER

16042A

CONSULTANT

SUBMITTAL

Permit Submittal

DATE 21 August 2017

REVISIONS

Date Descri

REGISTRATION AND SIGNATURE



SHEET TITLE
PLANTING
SCHEDULE

CHECKED B

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#### **TREES**




ROBINIA PSUEDOACACIA BLACK LOCUST 40'H x 30'W



LIRIODENDRON TULIPIFERA
TULIP TREE
50'H x 25'W



ARBUTUS UNEDO STRAWBERRY TREE 20'H x 15'W

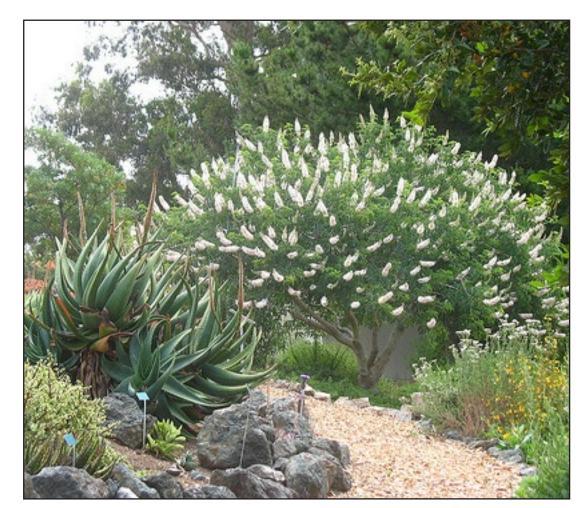

AESCULUS CALIFORNICA CALIFORNIA BUCKEYE 20'H x 20'W



SALIX BABYLONICA
WEEPING WILLOW
30'H x 30'W



SALIX LASIOLEPIS ARROYO WILLOW 30'H x 30'W



LYONOTHAMNUS FLORIBUNDUS ASPLENIFOLIUS CATALINA ISLAND IRONWOOD 30'H x 15'W



CERCIS CANADENSIS
EASTERN REDBUD
25'H x 25'W



AESCULUS X CARNEA
HORSE-CHESTNUT
30'H x 20'W



QUERCUS AGRIFOLIA COAST LIVE OAK 40'H x 40'W



PINUS CONTORTA VAR. CONTORTA SHORE PINE 25'H x 20'W



CERCIS OCCIDENTALIS
WESTERN REDBUD
15'H x 15'W



ALNUS RUBRA RED ALDER 40'H X 25'W



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SCALE

SHEET TITLE
PLANTING

PAWN RV:

PALETTE

CHECKED BY:

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#### LARGE SHRUBS



**LUPINUS ALBIFRONS** SILVER BUSH LUPINE 5'H x 5'W



**GAUTHERIA SHALLON** SALAL 7'H x 9'Wt



**CEANOTHUS 'CYNTHIA POSTAN'** CYNTHIA POSTAN WILD LILAC 7'H x 7'W



**BACCHARIS PILULARIS COYOTE BRUSH** 6'H x 8'W




**ATRIPLEX LENTIFORMIS 'BREWERII' BREWER SALTBUSH** 6'H x 8'W



8'H x 10'W



**RHAMNUS CALIFORNICA 'EVE CASE' EVE CASE COFFEE BERRY** 6'H x 6'Wt'

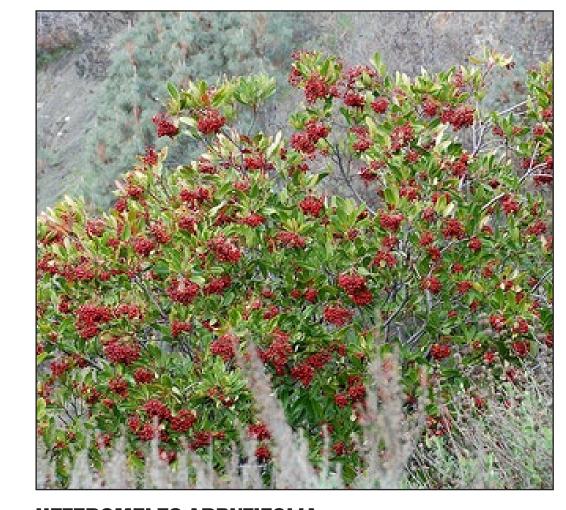

**HETEROMELES ARBUTIFOLIA TOYON** 8'H x 8'W



**DENDRONMECON HARFORDII ISLAND BUSH POPPY** 10'H x 10'W



**CARPENTERIA CALIFORNICA BUSH ANEMONE** 6'H x 5'W



**ARCTOSTAPHYLOS DENSIFLORA 'HOWARD MCMINN'** HOWARD MCMINN MANZANITA

#### NATIVE HABITAT RESTORATION AREA



MEDIUM & SMALL SHRUBS **ERIOGONUM ARBORESCENS**, SANTA CRUZ ISLAND BUCKWHEAT **ERIOGONUM LATIFOLIUM**, COAST BUCKWHEAT **ERIOGONUM UMBELLATUM**, SULPHUR BUCKWHEAT **MIMULUS AURANTICUS**, STICKY MONKEY FLOWER **SALVIA LEUCOPHYLLA**, PURPLE SAGE **SPHAERALCEA AMBIGUA**, *APRICOT MALLOW* 

HERBACEOUS PERENNIALS

**ACHILLEA MILLEFOLIUM**, YARROW **DICHELOSTEMMA IDA-MAIA**, FIRECRACKER FLOWER **ESCHSCHOLZIA CALIFORNICA**, CALIFORNIA POPPY **IRIS DOUGLASIANNA**, DOUGLAS IRIS SOLIDAGO CALIFORNICA, CALIFORNIA GOLDENROD **VERBENA GOODINGII**, PINK VERBENA

**GRASSES** 

**BOUTELOUA GRACILIS**, BLONDE AMBITION GRAMMA GRASS **CAREX PANSA**, DUNE SEDGE **CAREX DIVULSA**, BERKELEY SEDGE **DESCHAMPSIA CESPITOSA VAR HOLCIFORMIS** FESTUCA RUBRA, CREEPING RED FESCUE **LEYMUS CONDENSATUS 'CANYON PRINCE'**, CANYON PRINCE RYE

\*ALSO SEE LARGE SHRUBS ABOVE.

#### LIVING SHORELINE





**SHRUBS** ATRIPLEX LENTIFORMIS 'BREWERII', BREWER SALTBUSH **BACHARIS DOUGLASII, MARSH BACCHARIS BACCHARIS PILULARIS, COYOTE BRUSH LIMONIUM CALIFORNICUM**, SEA LAVENDER

**GRASSES DISTICHLIS SPICATA**, SALT GRASS **SPARTINA FOLIOSA**, CORDGRASS

SUCCULENTS **DUDLEYA FARINOSA**, BLUFF LETTUCE **SARCOCORNIA PACIFICA**, PICKLEWEED

SHEET TITLE

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PROJECT/CLIENT NAME

**Dunphy Park** 

City of Sausalito 420 Litho St. Sausalito, CA 94965

200 Napa Street Sausalito, CA 94965

**RHAA PROJECT NUMBER** 16042A

CONSULTANT

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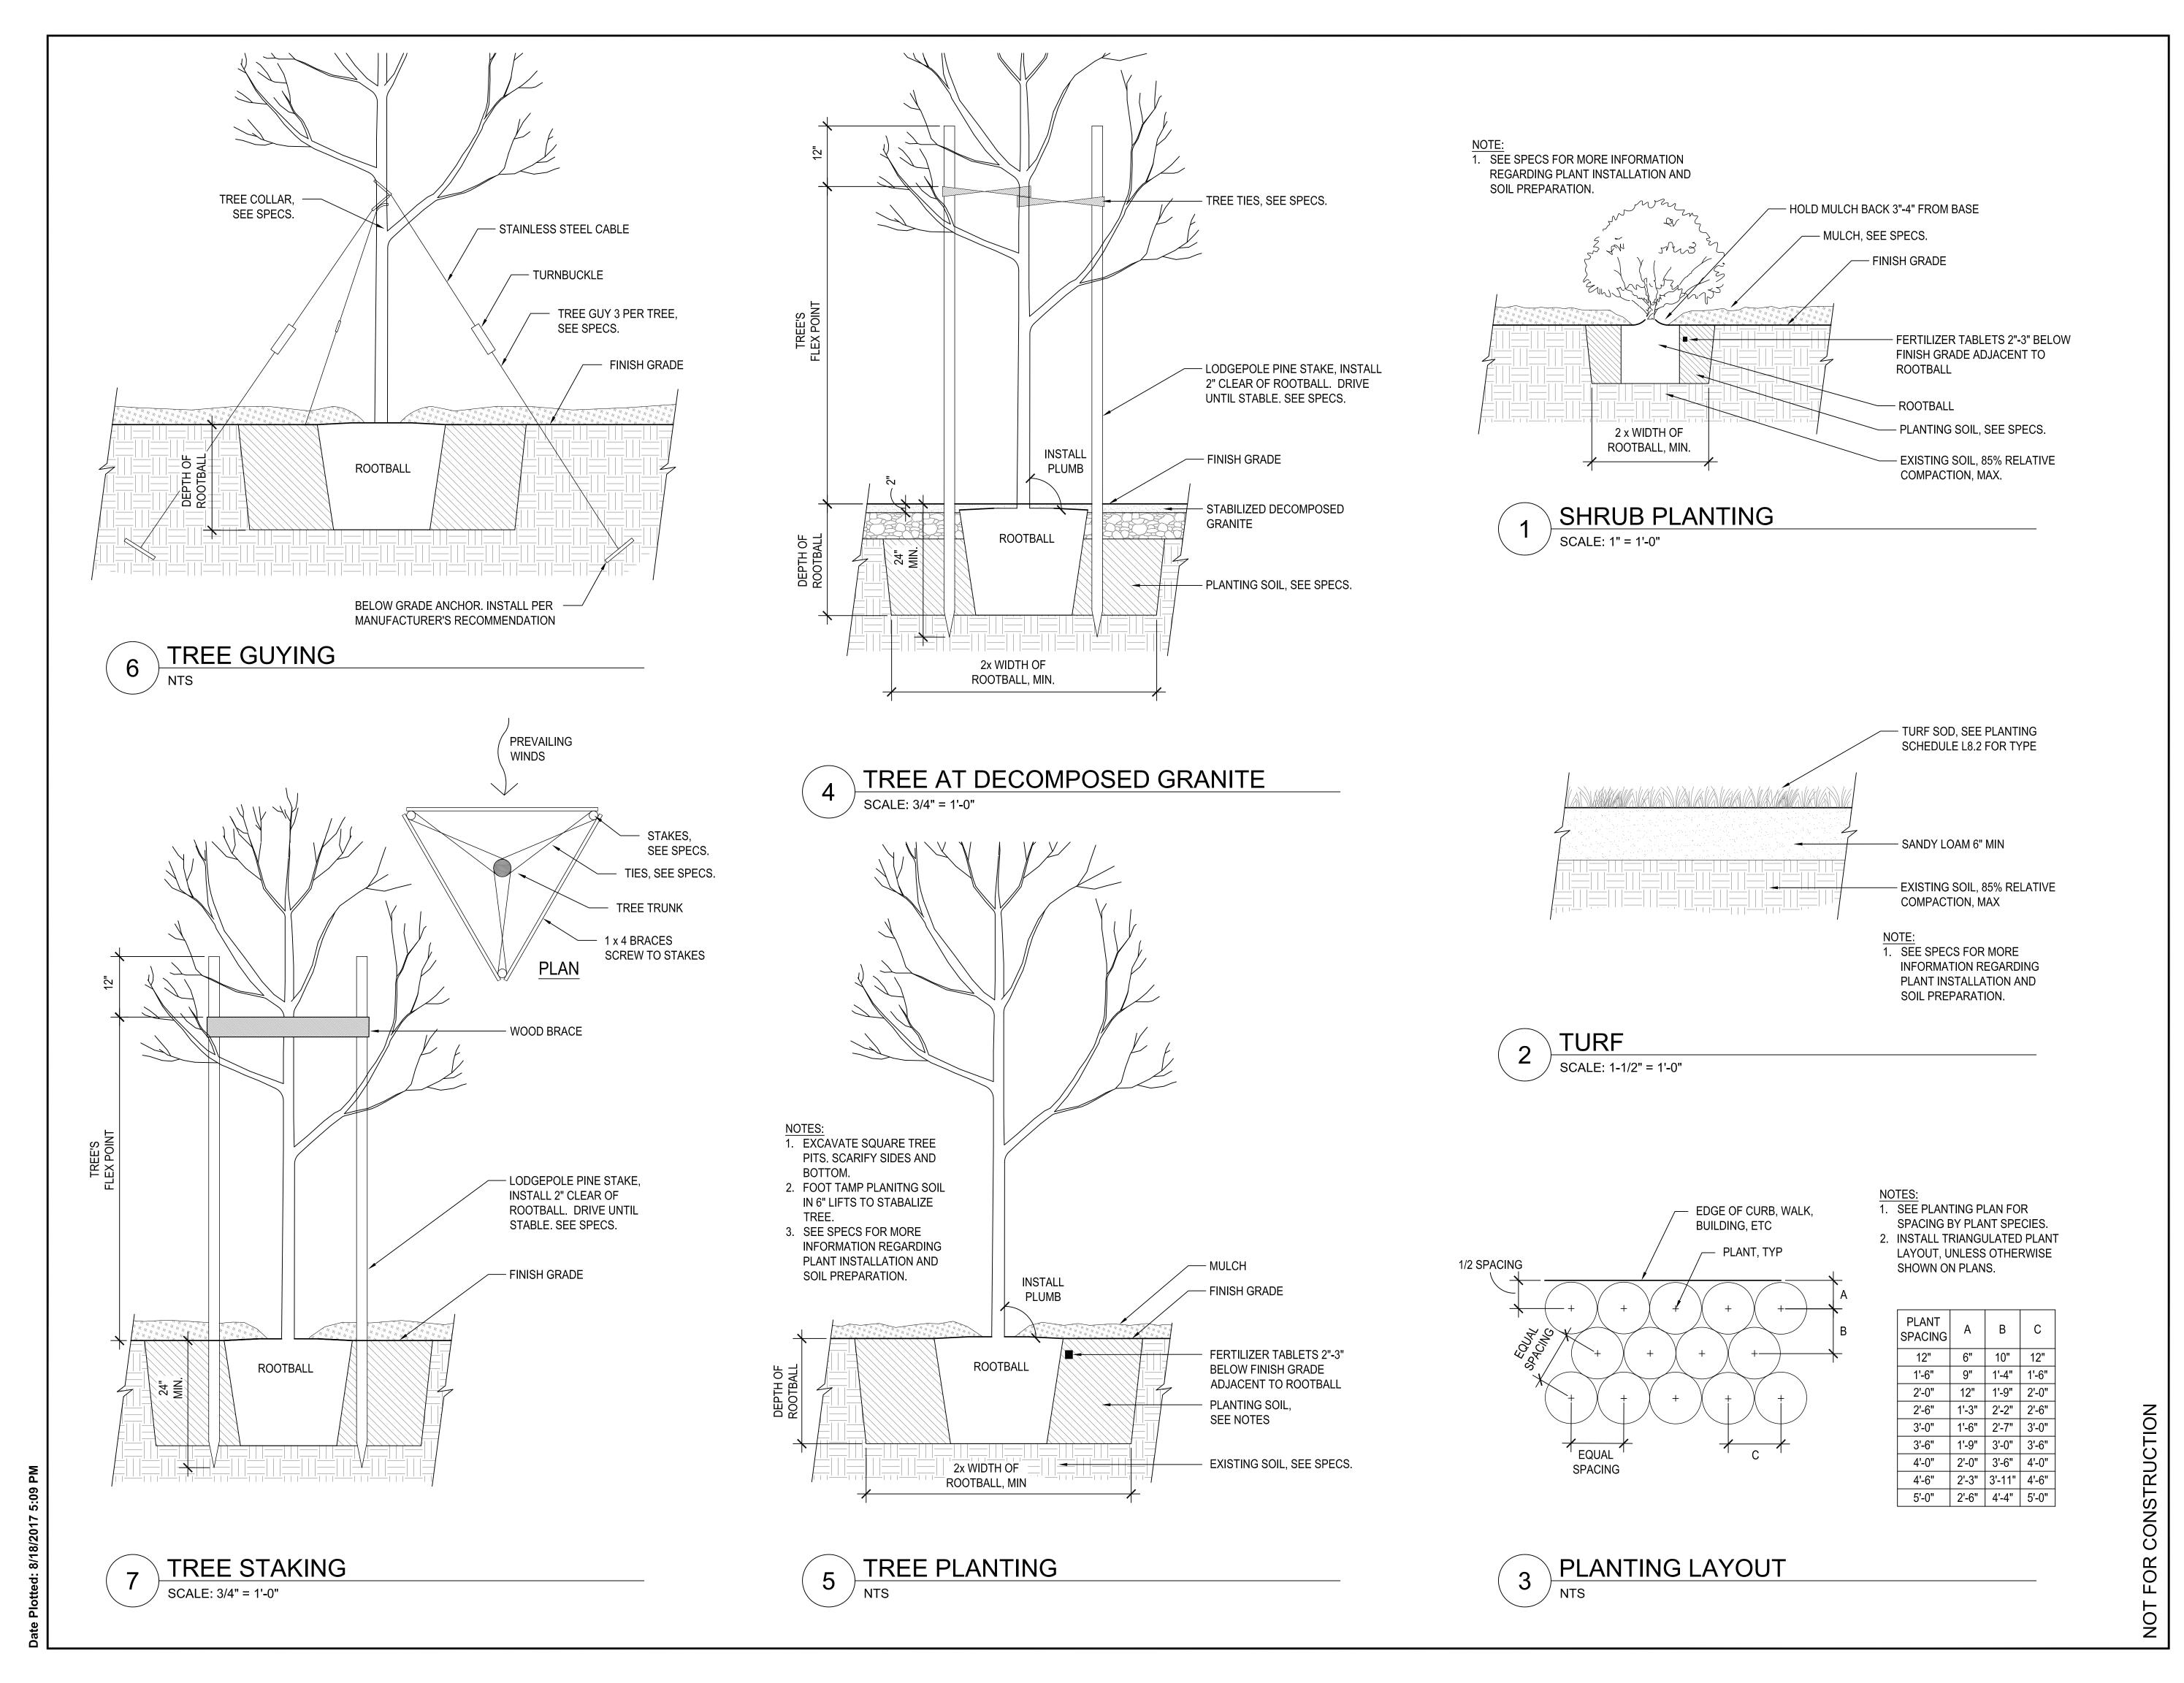
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**SCALE** 

**PLANTING** PALETTE





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PROJECT/CLIENT NAME

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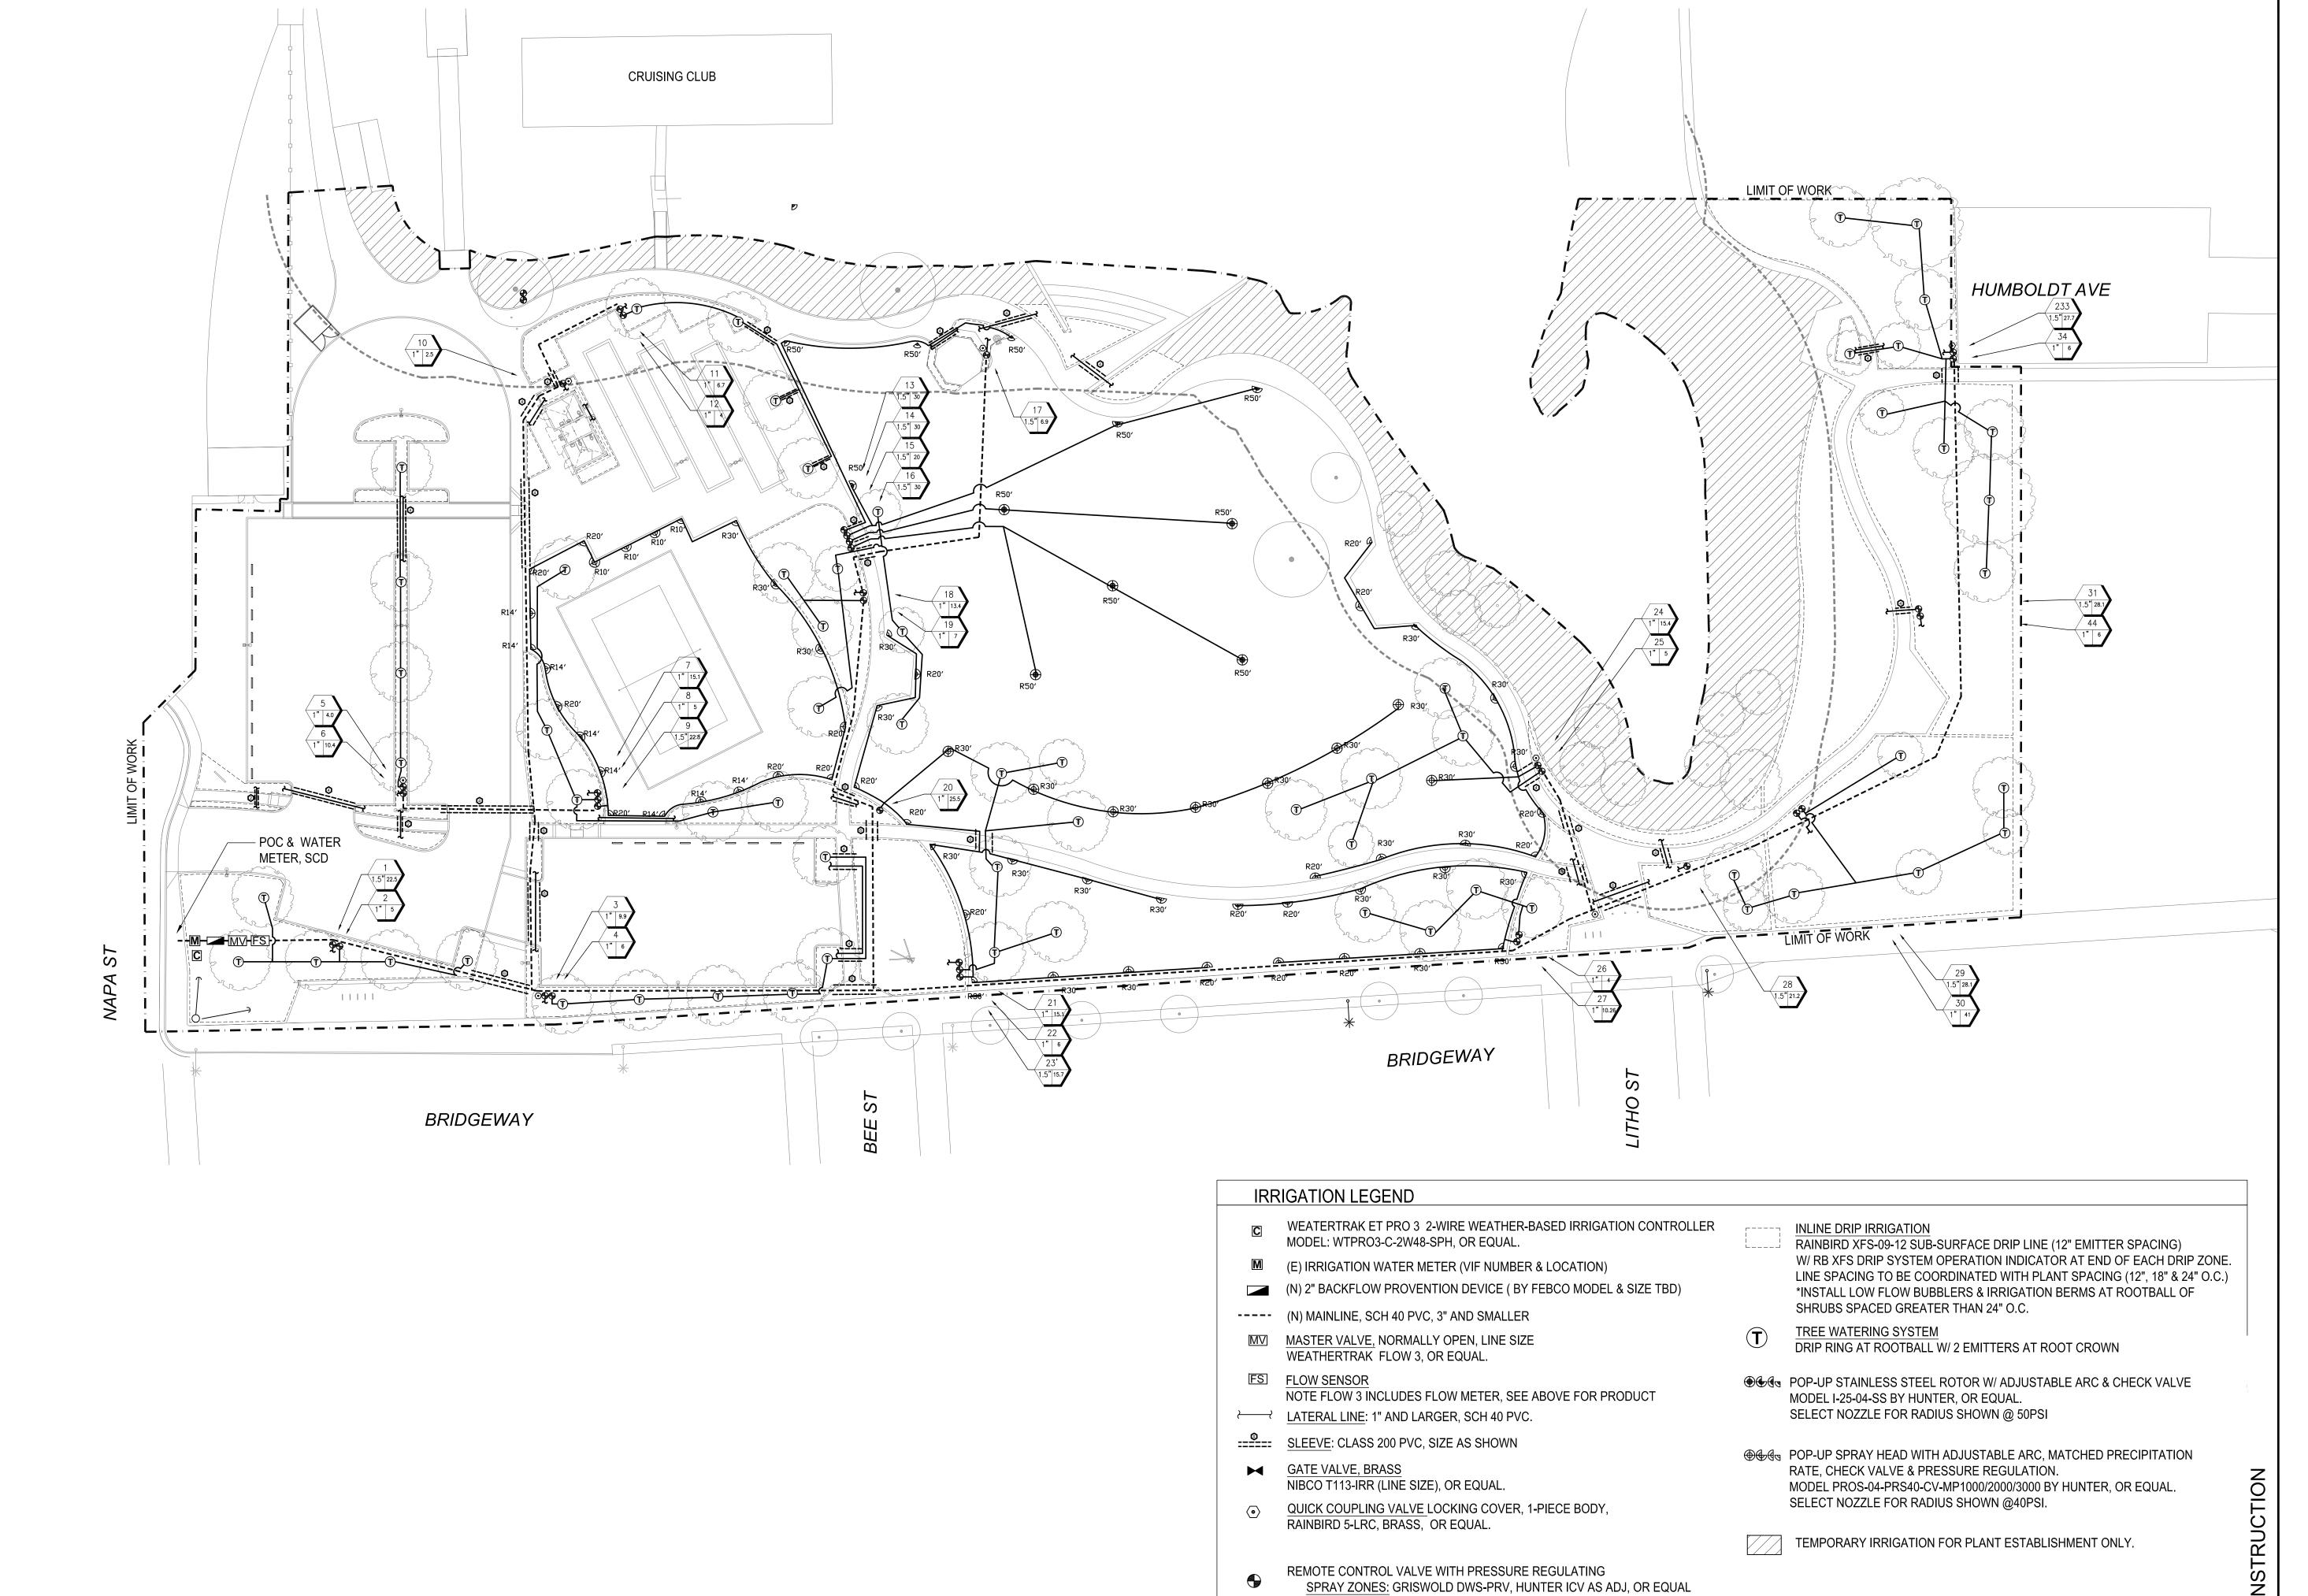
**REGISTRATION AND SIGNATURE** 



**SCALE** 

SHEET TITLE **PLANTING DETAILS** 

DRAWN BY:



DRIP ZONES: HUNDER ICZ WITH FILTER, OR EQUAL.

— CONTROLLER / STATION NUMBER

FLOW RATE (GPM)

— VALVE SIZE (INCHES)

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**SCALE** 



SHEET TITLE

IRRIGATION PLAN

DRAWN BY:

TYPICAL VALVE SIZING


51 - 100 GPM: 2"

CLASS 200 PVC LATERAL LINE SIZING


0 - 6 GPM: 0.75" 29 - 45 GPM: 2.0" 00 - 25 GPM: 1.0" VALVE

7 - 12 GPM: 1.0" 46 - 65 GPM: 2.5" 26 - 35 GPM: 1.25"


13 - 28 GPM: 1.5" 66 - 100 GPM: 3.0" 36 - 50 GPM: 1.5"

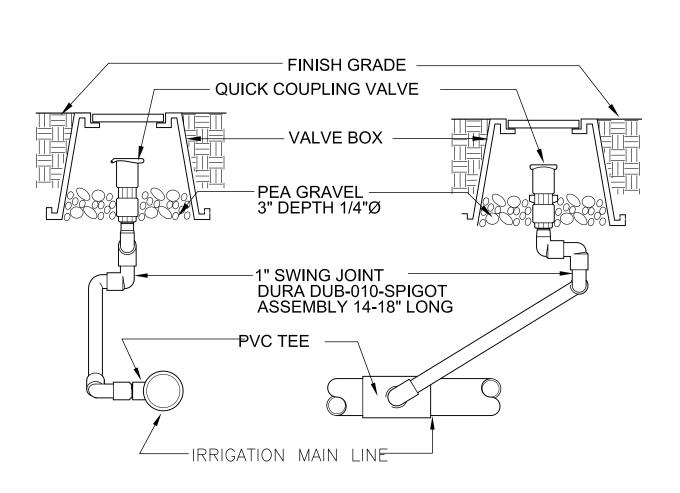




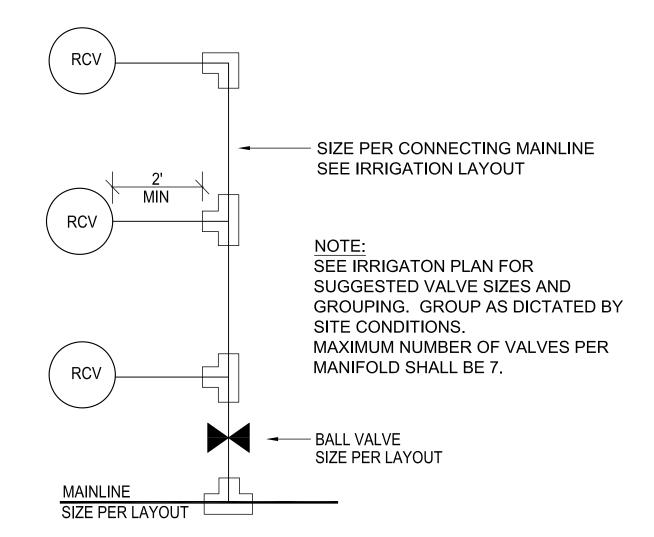


REMOTE CONTROL VALVES - CONNECTION

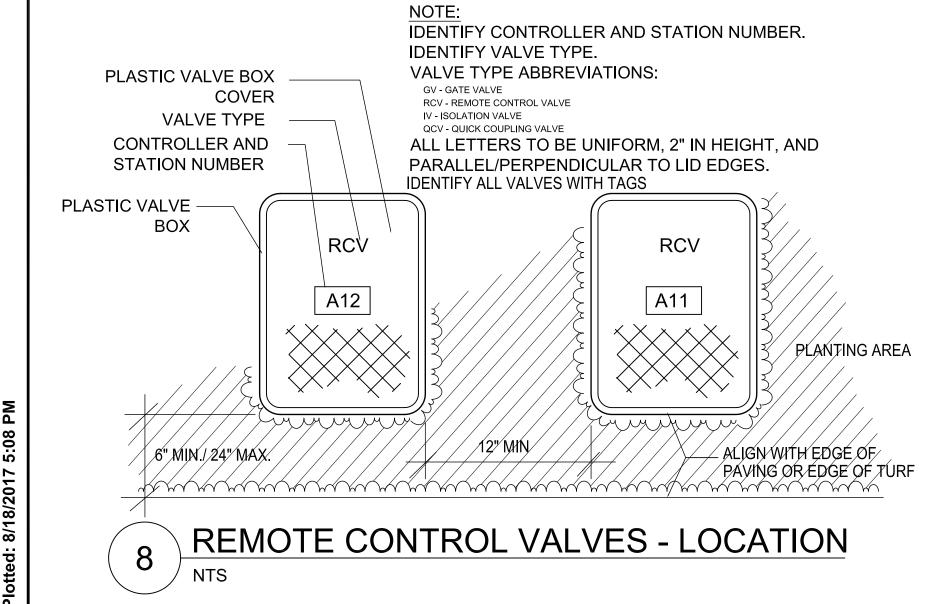


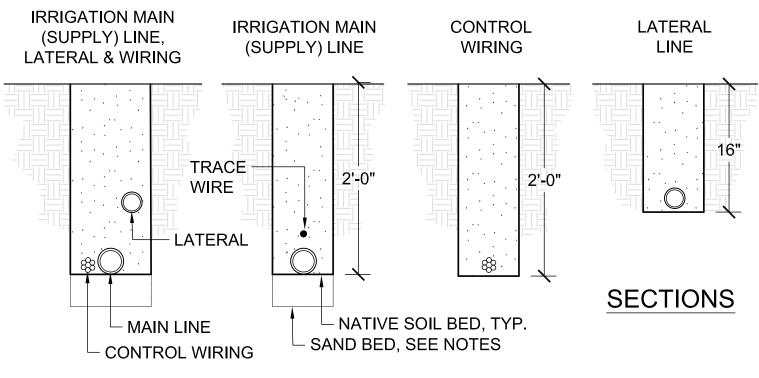


- 3. PROVIDE 36" COVER OVER ALL PIPE AND PIPE SLEEVES UNDER ROADWAYS,
- 4. PROVIDE SEPARATE SLEEVES FOR ALL WIRES CROSSING UNDER ROADWAYS,


#### **IRRIGATION TRENCHING** 3

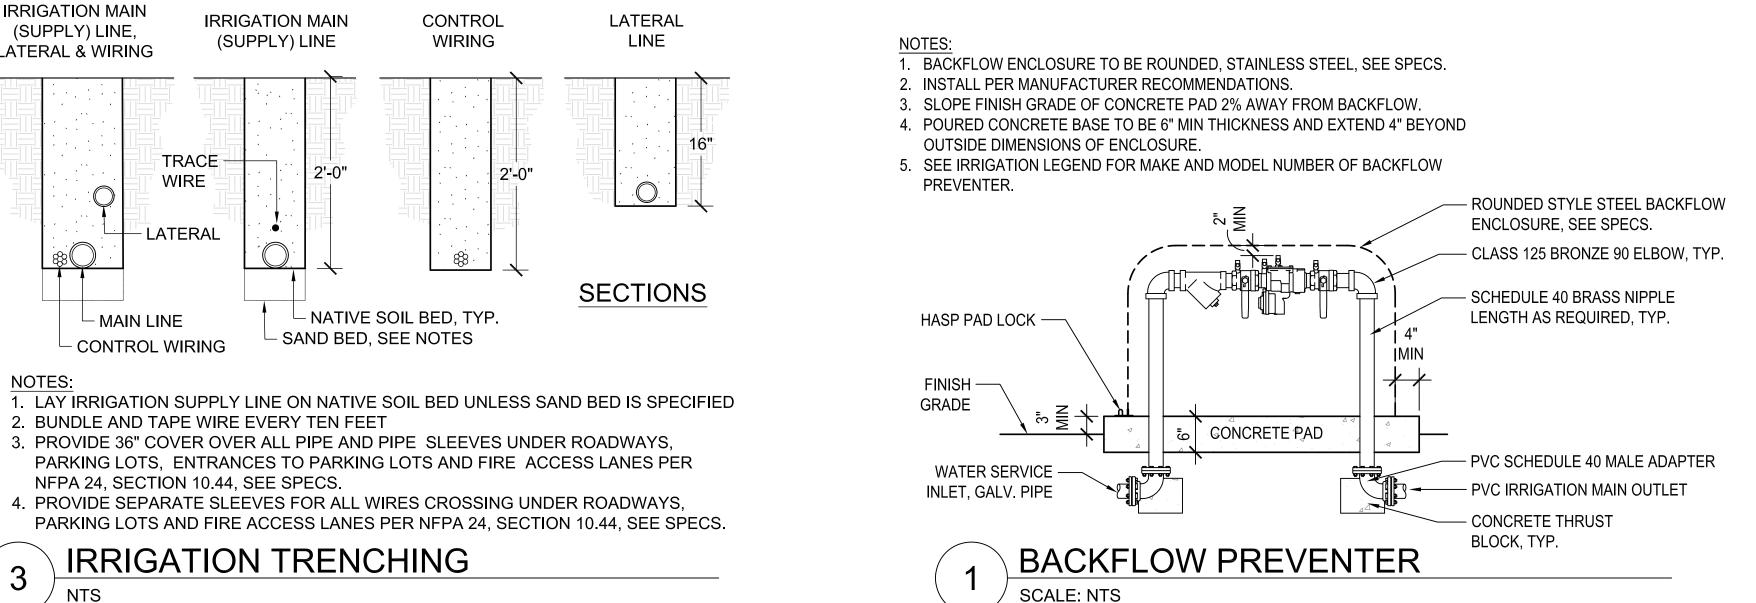

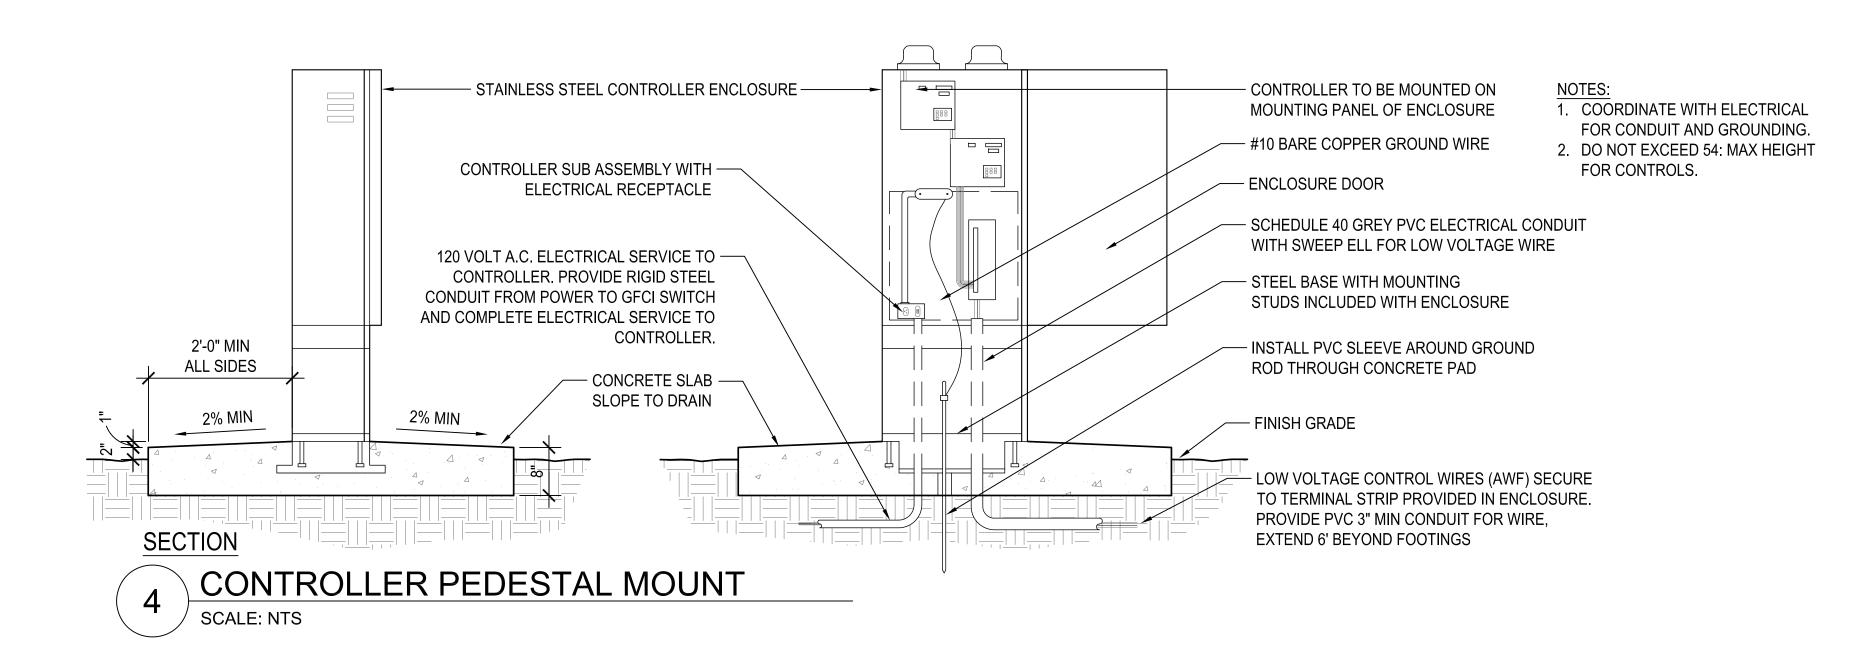

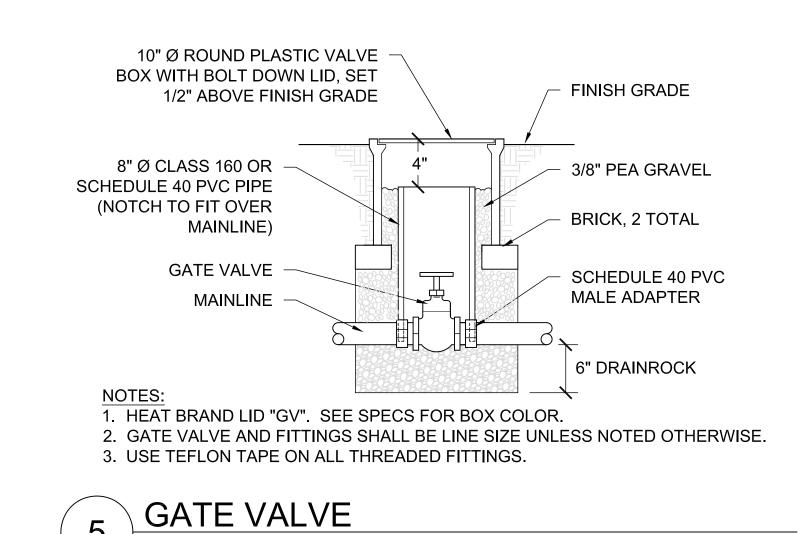

NTS

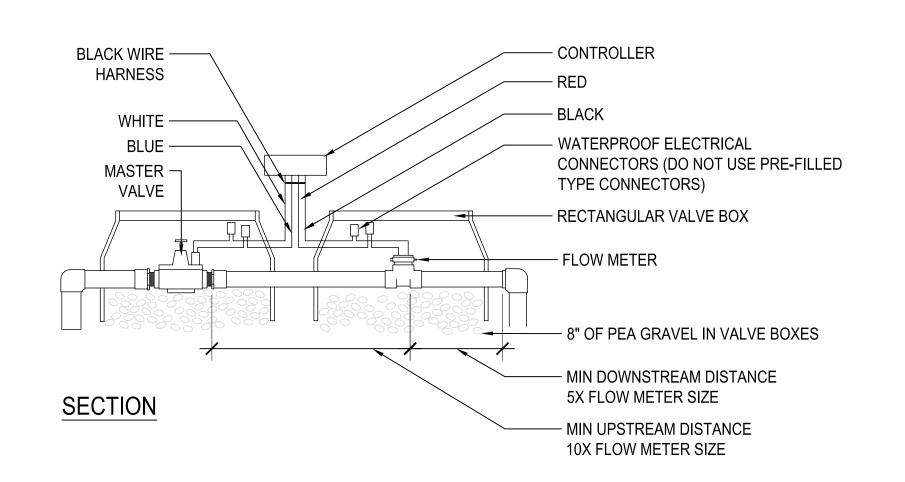

MASTER VALVE & FLOW METER SCALE: NTS

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RHAA PROJECT NUMBER

16042A

CONSULTANT

**SUBMITTAL** 

Permit Submittal

DATE

21 August 2017

REVISIONS

Description

**REGISTRATION AND SIGNATURE** 



**SCALE** 

SHEET TITLE **IRRIGATION DETAILS** 

**DRAWN BY:**