

LANDSCAPE ARCHITECTURE + PLANNING
225 Miller Avenue, Mill Valley, CA 94941
T 415 383 7900 F 415 383 1433 www.rhaa.com

PROJECT/CLIENT NAME

Dunphy Park

200 Napa Street Sausalito, CA 94965

Owner: City of Sausalito 420 Litho St. Sausalito, CA 94965

RHAA PROJECT NUMBER

16042A

CONSULTANT

SUBMITTAL

Permit Submittal

DATE

21 August 2017

REVISIONS

No. Date Description

REGISTRATION AND SIGNATURE




SCALE 0 15' 30' 60'

IRRIGATION DETAILS

DRAWN BY:

CHECKED BY:

L9.2

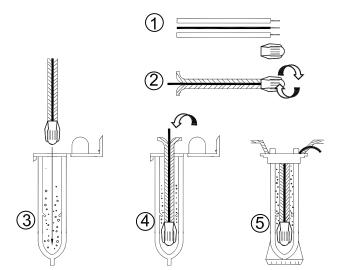



NOTES

- 1. STRIP WIRES APPROXIMATELY 1/2" (12.7 MM) TO EXPOSE WIRE.
- 2. TWIST CONNECTOR AROUND WIRES CLOCKWISE UNTIL HAND TIGHT, DO NOT OVERTIGHTEN.
- 3. INSERT WIRE ASSEMBLY INTO PLASTIC TUBE UNTIL WIRE CONNECTOR SNAPS PAST LIP IN BOTTOM OF TUBE.
- 4. PLACE WIRES WHICH EXIT TUBE IN WIRE EXIT HOLES AND CLOSE CAP UNTIL IT
- 5. INSPECT FINAL SPLICE ASSEMBLY TO BE SECURE AND FINISHED.

WATERPROOF WIRE CONNECTION


NTS

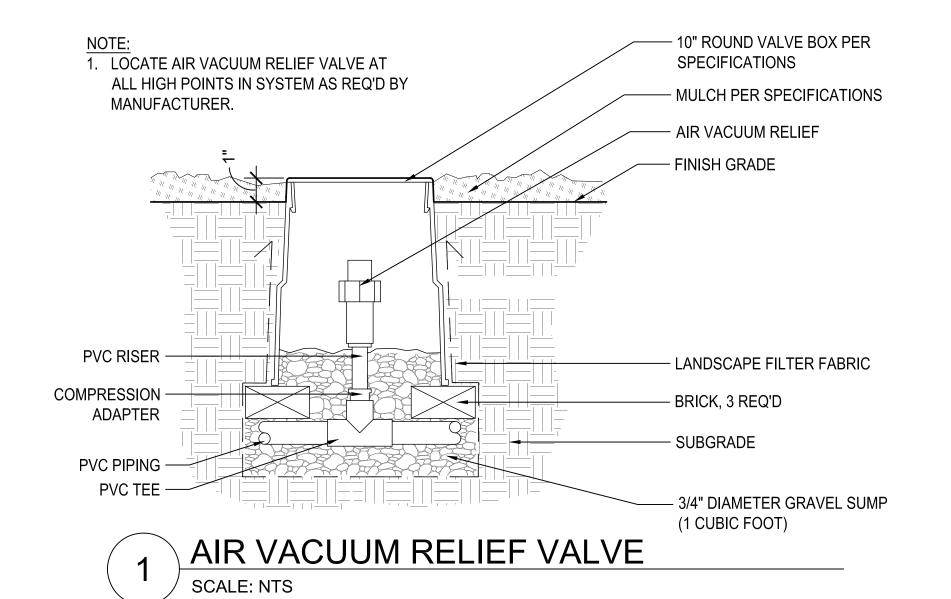

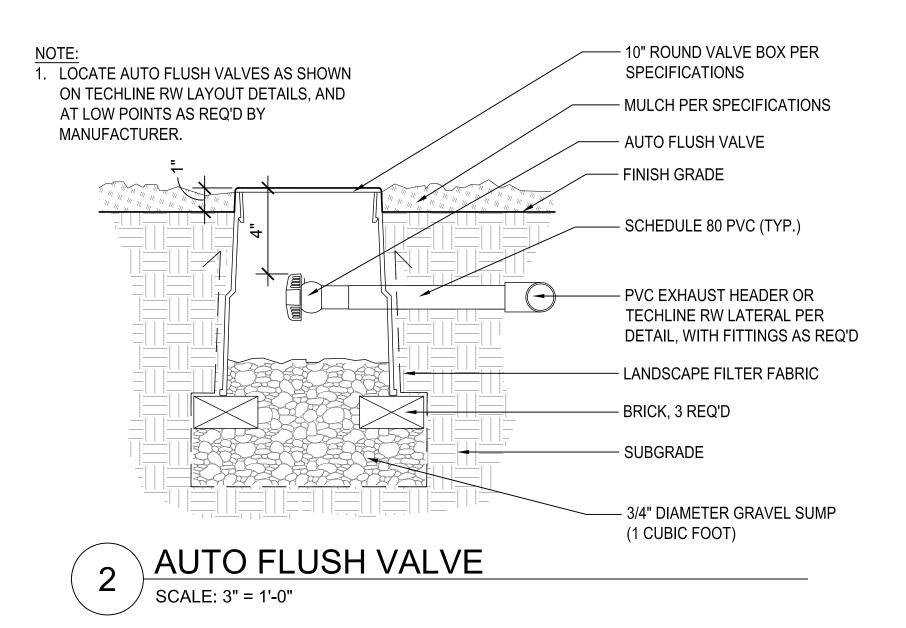

NOTE:

1. LOCATE INDICATOR AT THE FARTHEST
AND/OR HIGHEST POINT ON THE ZONE.

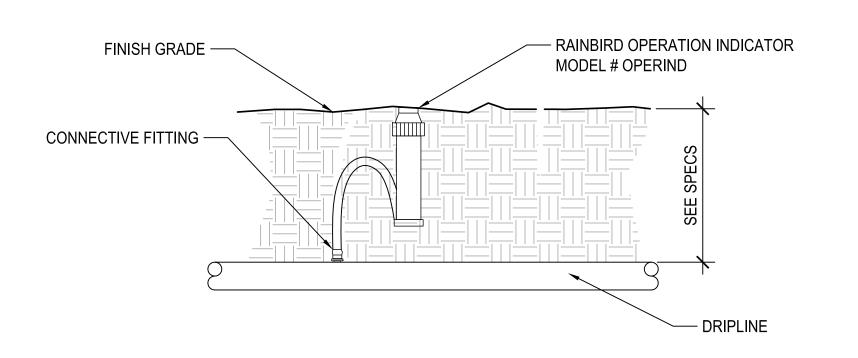

8 DRIP OPERATION INDICATOR



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SCALE				N
0	15'	30'	60'	

SHEET TITLE
IRRIGATION
DETAILS

DRAWN BY

CHECKED BY:

L9.3

DUNPHY PARK

SAUSALITO, CALIFORNIA

GENERAL NOTES


1. THE DESIGN SHOWN IN THESE DOCUMENTS WAS BASED ON THE FOLLOWING: A. CITY OF SAUSALITO CODE ORDINANCES.

D. REQUIREMENTS OF ALL PERMITS APPLICABLE TO THIS PROJECT.

- B. ALL GUIDELINES AS SET FORTH BY THE GEOTECHNICAL STUDY REPORT: DUNPHY PARK IMPROVEMENTS BY RGH CONSULTANTS, DATED JUN 9, 2015.
- C. THE GEOTECHNICAL REPORT SHALL BE INCLUDED AS PART OF THE WORKING DOCUMENTS AND THE CONTRACTOR SHALL FOLLOW ALL RECOMMENDATIONS OF THIS REPORT.
- 2. TOPOGRAPHIC BASE SURVEY AS ILLUSTRATED ON THESE PLANS BY LINDA A. CARRUTHERS & ASSOCIATES, DATED DECEMBER 9, 2013 AND REVISED JUNE 15, 2017.
- THE SUBSURFACE OF THE CONSTRUCTION SITE MAY BE SENSITIVE FOR PALEONTOLOGICAL RESOURCES. IF PALEONTOLOGICAL RESOURCES ARE ENCOUNTERED DURING PROJECT SUBSURFACE CONSTRUCTION, ALL GROUND—DISTURBING ACTIVITIES WITHIN 50 FEET SHALL BE REDIRECTED AND THE COMMUNITY DEVELOPMENT AGENCY, PLANNING DIVISION SHALL BE CONTACTED, AS WELL AS OTHER CONSULTING AGENCIES AS APPROPRIATE, AND A QUALIFIED PALEONTOLOGIST TO ASSESS THE SITUATION, AND MAKE RECOMMENDATIONS FOR THE TREATMENT OF THE DISCOVERY. PROJECT PERSONNEL SHALL NOT COLLECT OR MOVE ANY PALEONTOLOGICAL MATERIALS. PALEONTOLOGICAL RESOURCES INCLUDE FOSSIL PLANTS AND ANIMALS, AND SUCH TRACE FOSSIL EVIDENCE OF PAST LIFE AS TRACKS. ANCIENT MARINE SEDIMENTS MAY CONTAIN INVERTEBRATE FOSSILS SUCH AS SNAILS, CLAM AND OYSTER SHELLS, SPONGES, AND PROTOZOA, AND VERTEBRATE FOSSILS SUCH AS FISH, WHALE, AND SEA LION BONES. VERTEBRATE LAND MAMMALS MAY INCLUDE BONES OF MAMMOTH, CAMEL, SABER—TOOTH CAT, HORSE, AND BISON. PALEONTOLOGICAL RESOURCES ALSO INCLUDE PLANT IMPRINTS, PETRIFIED WOOD, AND ANIMAL TRACKS.
- 4. IF HUMAN REMAINS ARE ENCOUNTERED DURING PROJECT ACTIVITIES, WORK WITHIN 50 FEET OF THE DISCOVERY SHALL BE REDIRECTED AND THE TOWN CORONER NOTIFIED IMMEDIATELY. AT THE SAME TIME, AN ARCHAEOLOGIST SHALL BE CONTACTED TO ASSESS THE SITUATION AND CONSULT WITH AGENCIES AS APPROPRIATE. PROJECT PERSONNEL SHALL NOT COLLECT OR MOVE ANY HUMAN REMAINS AND ASSOCIATED MATERIALS. IF THE HUMAN REMAINS ARE OF NATIVE AMERICAN ORIGIN, THE CORONER MUST NOTIFY THE NATIVE AMERICAN HERITAGE COMMISSION WITHIN 24 HOURS OF THIS IDENTIFICATION. THE NATIVE AMERICAN HERITAGE COMMISSION WILL IDENTIFY A MOST LIKELY DESCENDANT (MLD) TO INSPECT THE SITE AND PROVIDE RECOMMENDATIONS FOR THE PROPER TREATMENT OF THE REMAINS AND ASSOCIATED GRAVE GOODS.

GRADING NOTES

- 1. ALL GRADING AND DRAINAGE TO COMPLY WITH RECOMMENDATIONS IN SOILS REPORT ENTITLED "GEOTECHNICAL STUDY REPORT: DUNPHY PARK IMPROVEMENTS", BY RGH CONSULTANTS, DATED: JUNE 9, 2015.
- 2. ALL GRADING SHALL CONFORM WITH THE CITY OF SAUSALITO CODE ORDINANCES.
- THE CONTRACTOR OR ANY SUBCONTRACTOR SHALL NOTIFY UNDERGROUND SERVICE ALERT ONE CALL PROGRAM 48 HOURS IN ADVANCE OF PERFORMING EXCAVATION WORK BY CALLING THE TOLL-FREE NUMBER 800-227-2600. EXCAVATION IS BEING 18 OR MORE INCHES IN DEPTH BELOW THE EXISTING GROUND.
- 4. ACTUAL GRADING SHALL BEGIN WITHIN 30 DAYS OF VEGETATION REMOVAL OR THE AREA SHALL BE PLANTED TO CONTROL EROSION. SURFACE PLANT GROWTH ONLY, WHICH DOES NOT EXCEED 4 INCHES IN DEPTH.
- 5. CONTRACTOR SHALL NOTIFY THE CITY 48 HOURS PRIOR TO THE INTENTION TO COMMENCE
- 6. A COPY OF ALL COMPACTION TESTS AND FINAL GRADING REPORT SHALL BE SUBMITTED TO THE CITY PRIOR TO SCHEDULING ANY INSPECTIONS.
- 7. PERMANENT CUT AND FILL SLOPES SHALL BE NO STEEPER THAN TWO HORIZONTAL TO ONE VERTICAL (2H:1V) PER GEOTECHNICAL ENGINEER'S REPORT. TEMPORARY CUT SLOPES SHALL BE REVIEWED AND APPROVED BY GEOTECHNICAL ENGINEER.
- 8. PROVIDE 5 FT OF 2% MINIMUM SLOPE FOR PAVED AREAS, 3% MINIMUM SLOPE FOR SOFTSCAPE AREAS AWAY FROM BUILDINGS ON ALL SIDES PER GEOTECH REPORT UNLESS NOTED OTHERWISE.
- 9. SOIL COMPACTION SHALL BE A MINIMUM OF 90% RELATIVE COMPACTION FOR FILLS. ROAD SUBGRADES SHALL BE COMPACTED TO A 95% RELATIVE COMPACTION.
- 10. THE CONTRACTOR AGREES THAT IN ACCORDANCE WITH GENERALLY ACCEPTED CONSTRUCTION PRACTICES, CONSTRUCTION CONTRACTOR WILL BE REQUIRED TO ASSUME SOLE AND COMPLETE RESPONSIBILITY FOR THE JOB SITE CONDITIONS DURING THE COURSE OF CONSTRUCTION OF THE PROJECT, INCLUDING SAFETY OF ALL PERSONS AND PROPERTY, THAT THIS REQUIREMENT SHALL BE MADE TO APPLY CONTINUOUSLY AND NOT BE LIMITED TO NORMAL WORKING HOURS.
- 11. TREE PROTECTION FENCING SHALL BE INSTALLED IN ACCORDANCE WITH PROJECT SCOPE PRIOR TO CONSTRUCTION. SEE EROSION CONTROL PLAN IN THIS PERMIT SET.
- 12. GRADING OR ANY OTHER OPERATION THAT CREATES DUST SHALL BE STOPPED IMMEDIATELY IF DUST AFFECTS ADJACENT PROPERTIES. MUD TRACKED ONTO ONTO STREETS OR ADJACENT PROPERTIES SHALL BE REMOVED IMMEDIATELY AS DIRECTED BY A TOWN INSPECTOR.
- 13. THIS PLAN REFERENCES AN EXISTING TOPOGRAPHIC SURVEY PREPARED BY LINDA A. CARRUTHERS & ASSOCIATES, DATED DECEMBER 9, 2013. THE CONTRACTOR IS RESPONSIBLE FOR VERIFICATION OF EXISTING TOPOGRAPHICAL INFORMATION PRIOR TO COMMENCEMENT OF ANY CONSTRUCTION.

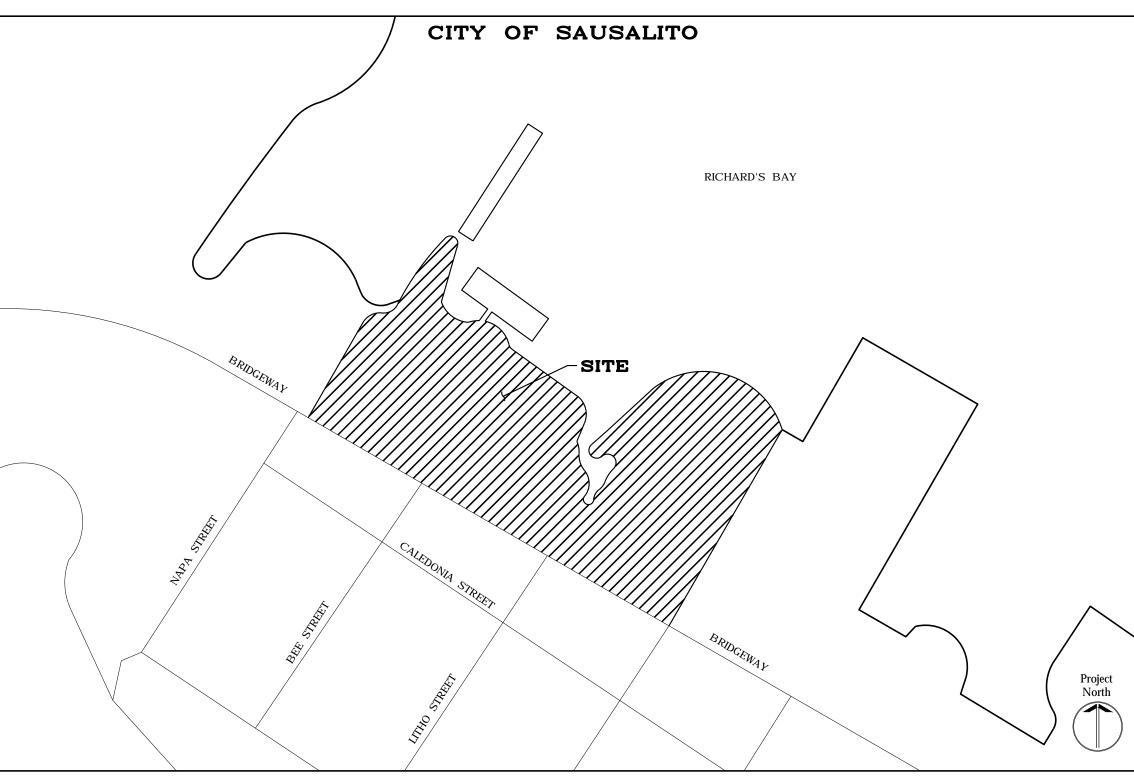

LOCATION MAP

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SURVEY NOTES

- 1. THE BASIS OF BEARINGS FOR THIS SURVEY IS NORTH 58°39'36" WEST BETWEEN FOUND STD. CITY MONUMENTS ON BRIDGEWAY AS SHOWN HEREON.
- 2. THE BENCHMARK USED FOR THIS SURVEY IS A 2.5" BRASS DISK SET IN THE CENTER LINE ISLAND OF NAPA STREET AND BRIDGEWAY, HAVING AN ELEVATION OF 13.67 FEET NAVD 1988.
- J. THE TYPES, LOCATIONS, SIZES AND/OR DEPTHS OF EXISTING UNDERGROUND UTILITIES AS SHOWN THE TOPOGRAPHICAL SURVEY ARE APPROXIMATE AND OBTAINED FROM SOURCES OF VARYING RELIABILITY. ONLY ACTUAL EXCAVATION WILL REVEAL THE TYPES, EXTENT, SIZES, LOCATIONS, AND DEPTHS OF SUCH UNDERGROUND UTILITIES. A REASONABLE EFFORT HAS BEEN MADE TO LOCATE AND DELINEATE ALL KNOWN UNDERGROUND UTILITIES. HOWEVER, THE ENGINEER CAN ASSUME NO RESPONSIBILITY FOR THE OCMPLETENESS OR ACCURACY OF ITS DELINEATION OF SUCH UNDERGROUND UTILITIES WHICH MAY BE ENCOUNTERED, BUT WHICH ARE NOT SHOWN ON THIS SURVEY.
- 4. THE CONTRACTOR AND/OR OWNER SHALL PROVIDE ALL SURVEYING AND STAKING NECESSARY FOR THE ENTIRE PROJECT.
- 5. AFTER ALL PERMITS ARE OBTAINED, THE CIVIL ENGINEER WILL PROVIDE THE CONTRACTOR WITH DIGITAL FILES OF LAYOUT PLANS FOR STAKING PURPOSES.

UTILITY NOTES

- 1. AVAILABLE INFORMATION CONCERNING THE EXTENT AND LOCATION OF EXISTING UTILITIES IS SHOWN ON THE PLAN, BUT CONTRACTOR IS CAUTIONED IT DOES NOT NECESSARILY REPRESENT ACTUAL UTILITY LOCATIONS SIZES OR MATERIALS. IT IS THE CONTRACTOR'S RESPONSIBILITY TO VERIFY THE LOCATION OF ALL EXISTING UTILITIES, INCLUDING BUT NOT LIMITED TO, WATER, SEWER, ELECTRIC, COMMUNICATIONS, GAS, AND STORM DRAIN, PRIOR TO COMMENCING EXCAVATION OR BELOW GRADE DEMOLITION.
 - A. CONTACT UNDERGROUND UTILITY LOCATOR TO HAVE UTILITIES LOCATED AND MARKED NOT LESS THAN 2 WORKING DAYS, AND NOT MORE THAN 14 WORKING DAYS PRIOR TO EXCAVATION.

 B. AS NOTED ON THE PLANS, POTHOLING MAY BE REQUIRED IN SOME AREAS
 - TO CONFIRM THAT MINIMUM REQUIRED VERTICAL CLEARANCES CAN BE ACHIEVED.
- 2. PIPE MATERIALS AND METHODS OF INSTALLATION, INCLUDING TRENCH EXCAVATION AND BACKFILL, SHALL BE IN ACCORDANCE WITH THE APPLICABLE DETAILS PER PLAN AND WITH ALL APPLICABLE MANUFACTURER'S RECOMMENDATIONS.
- 3. PIPES SHALL BE LAID TRUE TO PROPOSED LINE AND GRADE, WITH NO HORIZONTAL DEVIATIONS OR BELLIES. ALL PIPE JOINTS SHALL BE TIGHT AND FULLY SEALED, SO AS TO ACHIEVE WATER—TIGHT OR SOIL—TIGHT JOINTS, AS APPROPRIATE FOR THE SPECIFIC PIPE TYPE.
- 4. PROPOSED UTILITY STRUCTURES SHALL CONFORM TO THE DETAILS SHOWN ON THE PLANS, AND SHALL BE INSTALLED VERTICALLY PLUMB ON A FULLY COMPACTED BASE. STRUCTURES SHALL BE BACKFILLED IN ACCORDANCE WITH THE APPLICABLE DETAIL PER PLAN, AND THE TOP OF EACH STRUCTURE SHALL BE SET SO ALL EXPOSED PORTIONS (FRAME, GRATE, COVER, ETC.) CONFORM TO ADJACENT GRADE UNLESS OTHERWISE NOTED.
- 5. ALL WORK PERFORMED TO RESET EXISTING UTILITY BOXES OR STRUCTURES TO PROPOSED GRADE SHALL BE IN ACCORDANCE WITH THE RESPECTIVE OWNER'S (UTILITY COMPANY OR AGENCY) STANDARDS AND REQUIREMENTS. CONTRACTOR IS RESPONSIBLE FOR OBTAINING EACH UTILITY OWNER'S APPROVAL UPON COMPLETION. AS APPLICABLE IN THE EVENT AN EXISTING STRUCTURE IS BROKEN OR OTHERWISE DAMAGED BEYOND THE POINT OF REUSE, IT SHALL BE REPLACED OR RETROFITTED AS DIRECTED BY THE RESPECTIVE UTILITY OWNER.
- 6. IF A UTILITY OWNER REQUIRES THAT ALL WORK RELATING TO A SPECIFIC BOX RETROFIT OR REPLACEMENT BE EXECUTED BY ITS OWN FORCES OR BY A SEPARATE, UTILITY—CERTIFIED CONTRACTOR, THE CONTRACTOR SHALL PROVIDE INFORMATION TO AND COORDINATE WITH THAT OWNER, TO THE EXTENT NECESSARY TO FULLY FACILITATE THE RECONSTRUCTION WORK.

SHEET LIST

C0.0	NOTES AND ABBREVIATIONS
C1.0	SITE IMPROVEMENT PLAN
C2.0	GRADING PLAN
C2.1	GRADING PLAN
C3.0	DRAINAGE AND UTILITY PLAN
C3.1	DRAINAGE AND UTILITY PLAN
C4.0	DETAILS
C4.1	DETAILS
C4.2	DETAILS
C5.0	EROSION CONTROL PLAN

ABBREVIATIONS

EROSION CONTROL DETAILS

	-,		
AB	AGGREGATE BASE	MIN	MINIMUM
AC	ASPHALT CONCRETE	N	NORTH
AD	AREA DRAIN	OC	ON CENTER
ADA	AMERICANS WITH DISABILITIES ACT	(P)	PROPOSED
BC	BOTTOM OF CURB	PA	PLANTED AREA
BS	BOTTOM OF STEP	PED	PEDESTRIAN
BW	BOTTOM OF WALL / BACK OF WALK	PIP	PROTECT IN PLACE
C&G	CURB & GUTTER	PL	PROPERTY LINE
СВ	CATCH BASIN	POC	POINT OF CONNECTION
CF	CUBIC FEET	PSI	POUNDS PER SQUARE INCH
CL	CENTERLINE	PVMT	PAVEMENT
СО	CLEAN OUT	RCP	REINFORCED CONCRETE PIPE
CONC	CONCRETE	RET	RETAINING
DI	DRAINAGE INLET	RIM	TOP OF STRUCTURE GRATE/ CO
DS	DOWN SPOUT	RW	•
DW			RAINWATER LEADER
Ε	EAST	S	
(E)		SAP	
EB			SOFTSCAPE CLEANOUT
EC		SD	
	ELEVATION		SHERWOOD DESIGN ENGINEERS
ELEC		SDMH	
	EDGE OF PAVEMENT		SEE ELECTRICAL PLANS
EVA			
FC	FACE OF CURB	SLP	SEE LANDSCAPE PLANS
FEMA	FEDERAL EMERGENCY	SMP	SEE MECHANICAL PLANS
I CIVIA	MANAGEMENT AGENCY	SPD	SEE PLUMBING DRAWINGS
FFE	FINISHED FLOOR ELEVATION	SPRK	FW SPRINKLER LINE
FG	FINISH GRADE	SQ	SQUARE
FH	FIRE HYDRANT	SS	SANITARY SEWER
FL	FLOWLINE	SSC0	SANITARY SEWER CLEAN OUT
FS	FINISH SURFACE	SSMH	SANITARY SEWER MANHOLE
FT	FEET	SSP	SEE STRUCTURAL PLANS
FW	FIRE WATER	STD	STANDARD
G	GAS	SW	SIDEWALK
GB	GRADE BREAK	TB	TOP OF BANK
GM	GAS METER	TBD	TO BE DETERMINED
GV		TBM	TEMPORARY BENCHMARK
	GATE VALVE		
GW	GRAY WATER	TBR	TO BE REMOVED
HP uT	HIGH POINT	TC TD	TOP OF CURB
HT	HEIGHT		TRENCH DRAIN
INV	INVERT OF PIPE OR CHANNEL	TEL	TELEPHONE
IRR	IRRIGATION POY	TEMP	TEMPORARY
JB	JUNCTION BOX	TG	TOP OF GRATE
JP	JOINT POLE	TS	TOP OF STEP
LA	LANDSCAPE ARCHITECT	T₩	TOP OF WALL
LF	LINEAR FEET	TYP	TYPICAL
LP	LIGHT POLE/ LOW POINT	UG	UNDERGROUND
LT	LEFT	W	WATER
MAX	MAXIMUM	WALK	WALKWAY/SIDEWALK
		WALK WM WS	WALKWAY/SIDEWALK WATER METER WATER SURFACE

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CONSULTANT



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DATE

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REVISIONS

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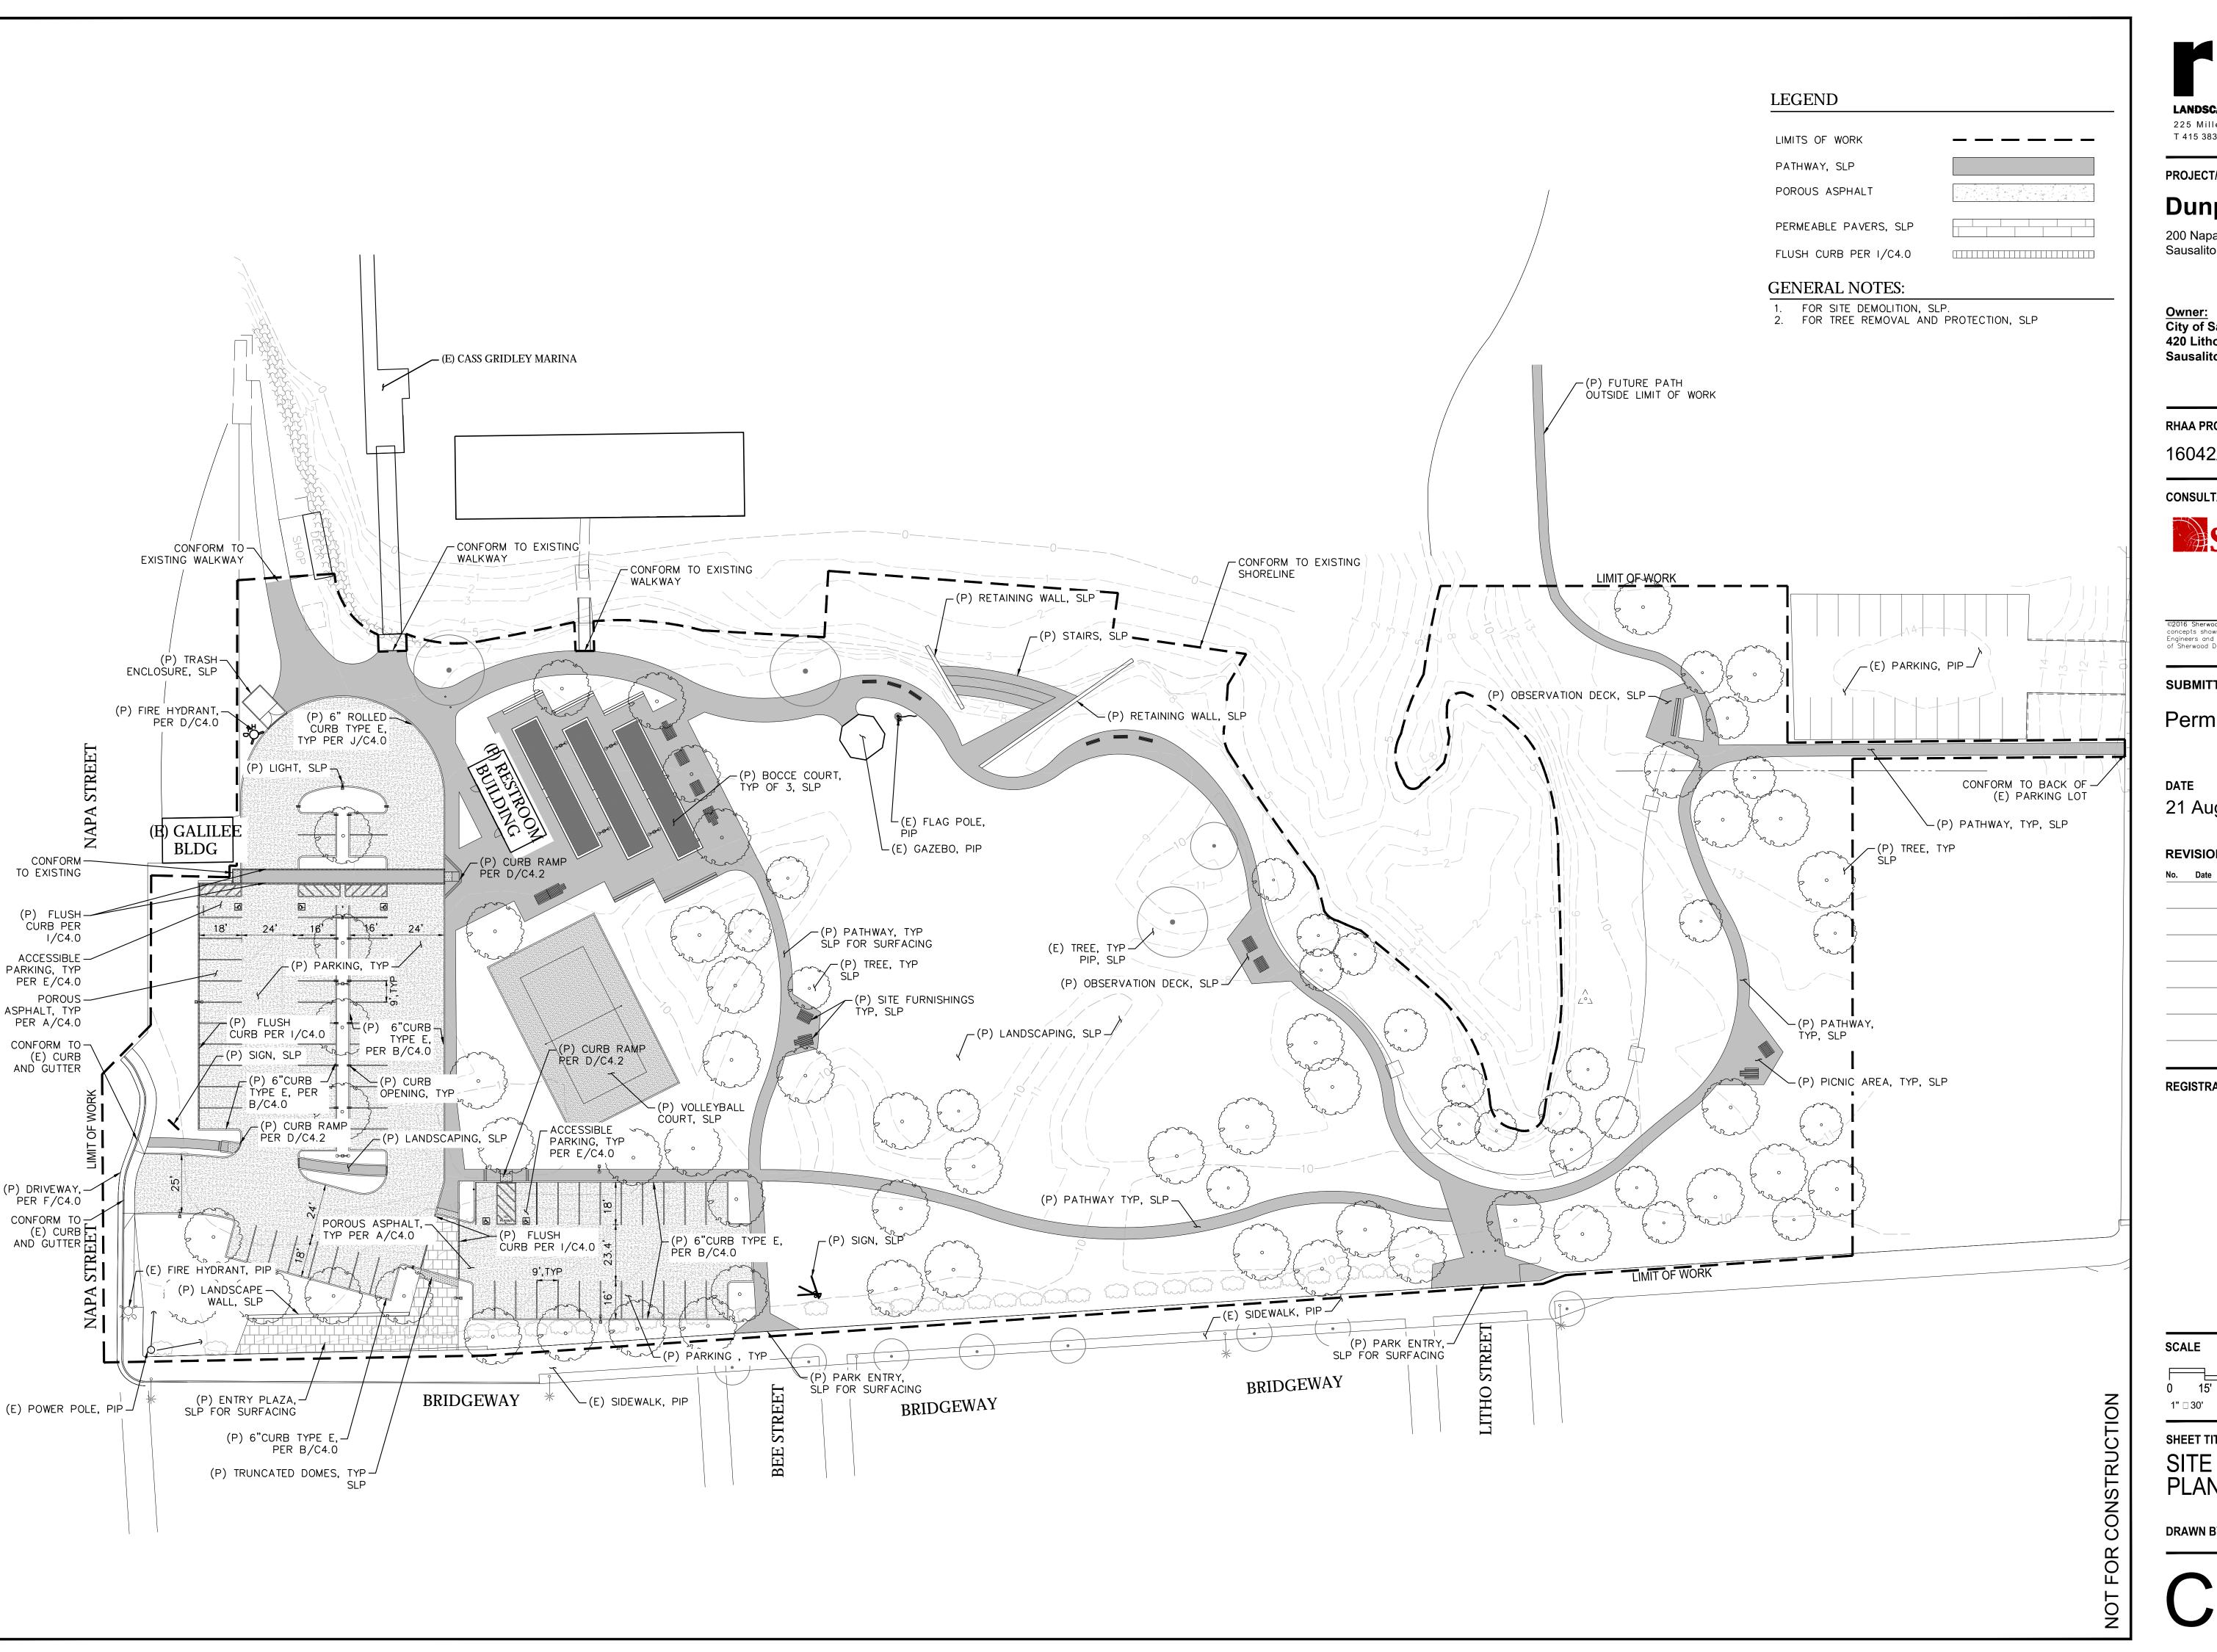


SHEET TITLE
NOTES AND
ABBREVIATIONS

DRAWN BY: JG

CHECKED BY: MW

C0.0





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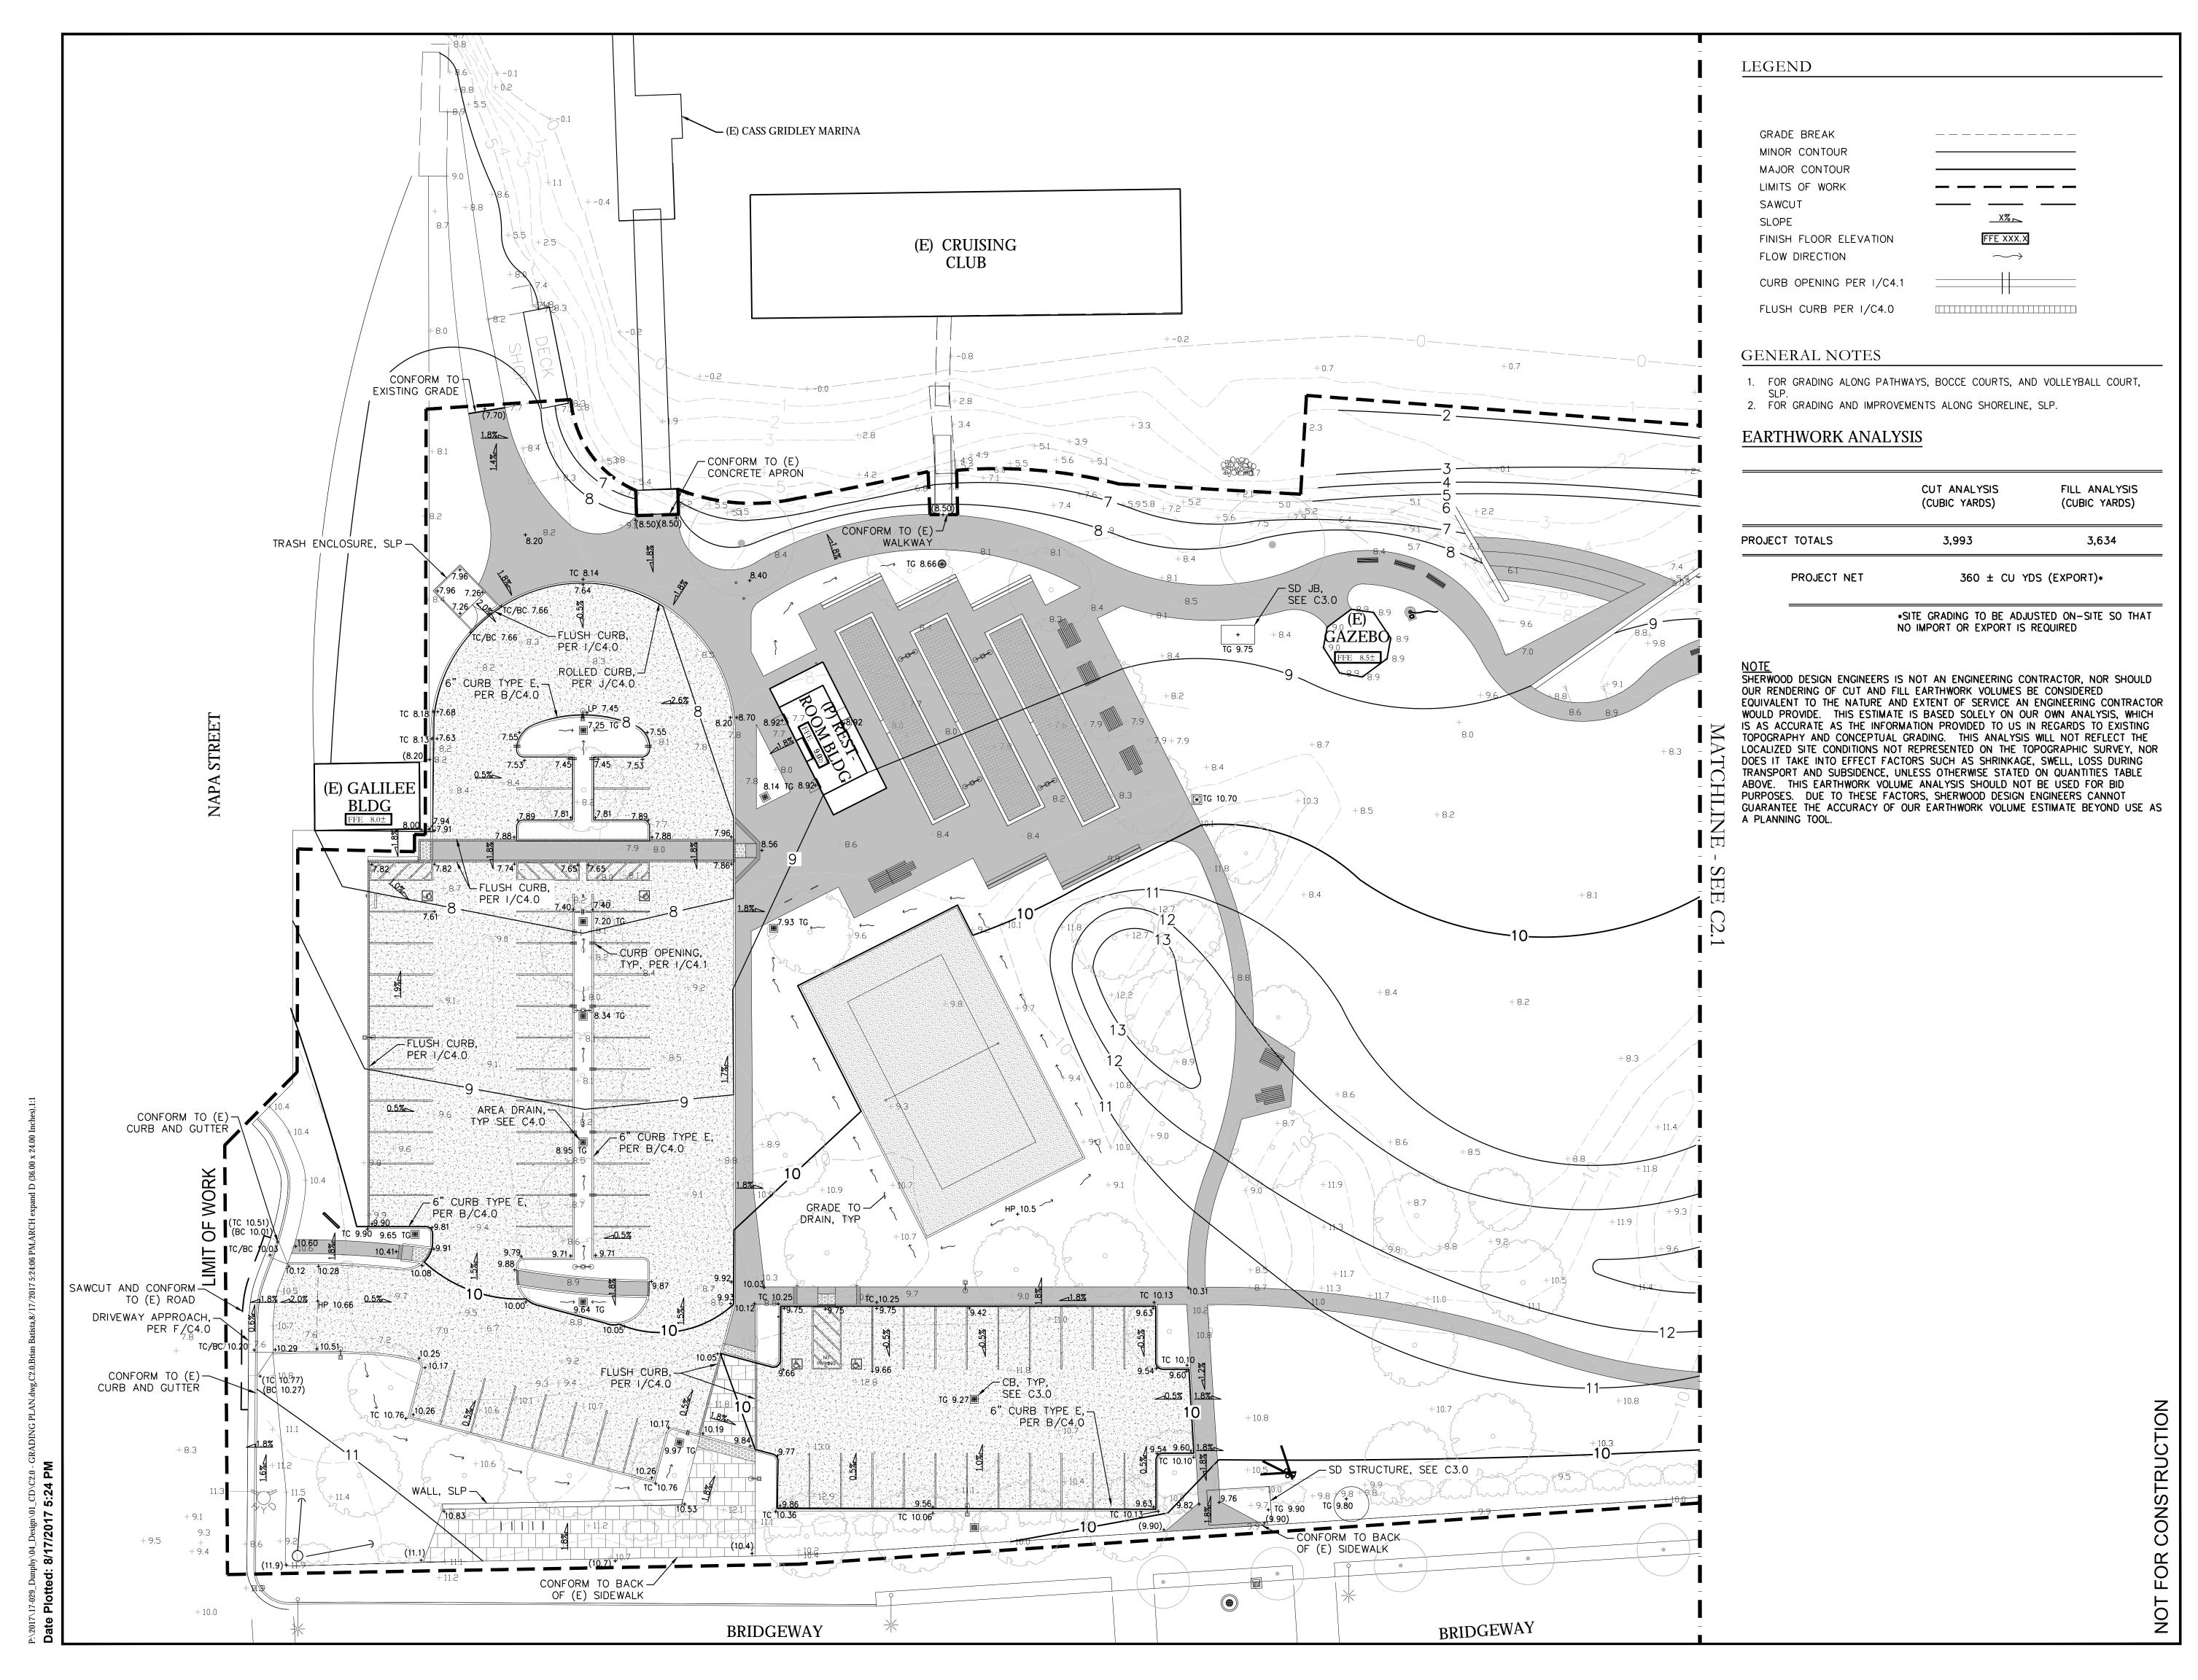


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SHEET TITLE SITE IMPROVEMENT PLAN

DRAWN BY: JG

CHECKED BY: MW



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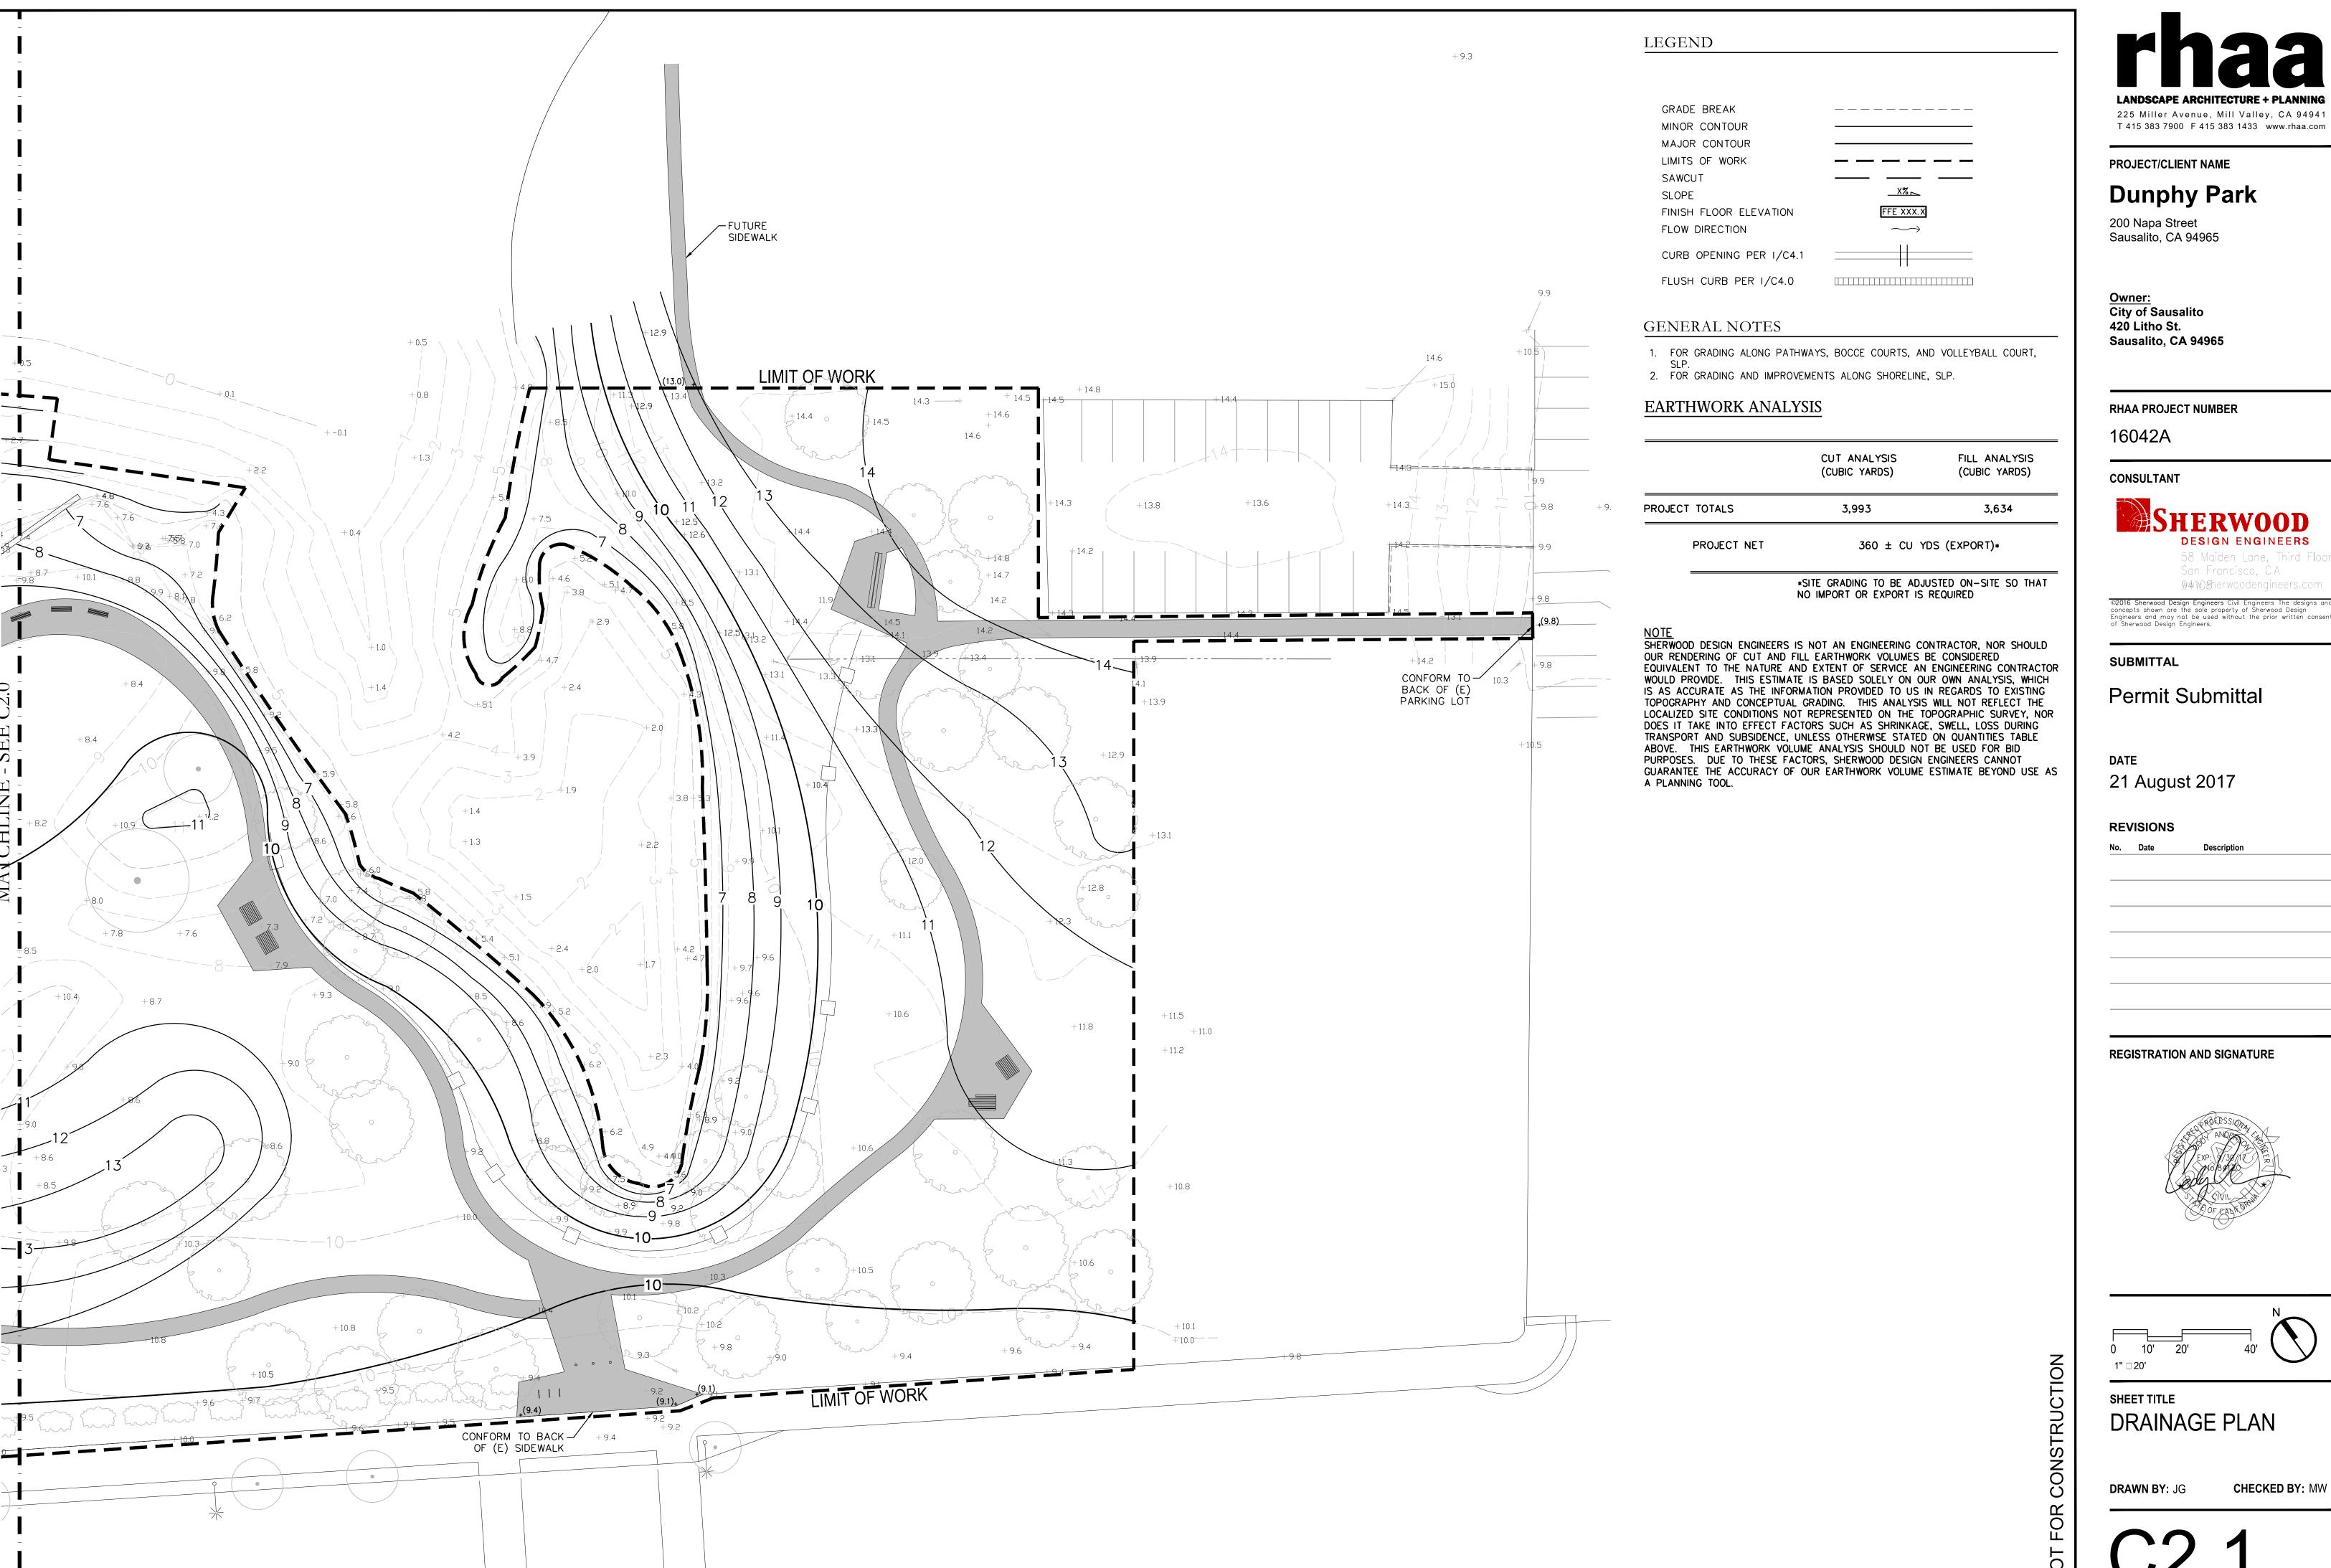


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SHEET TITLE
GRADING PLAN

DRAWN BY: JG **CHECKED BY:** MW

C2.0



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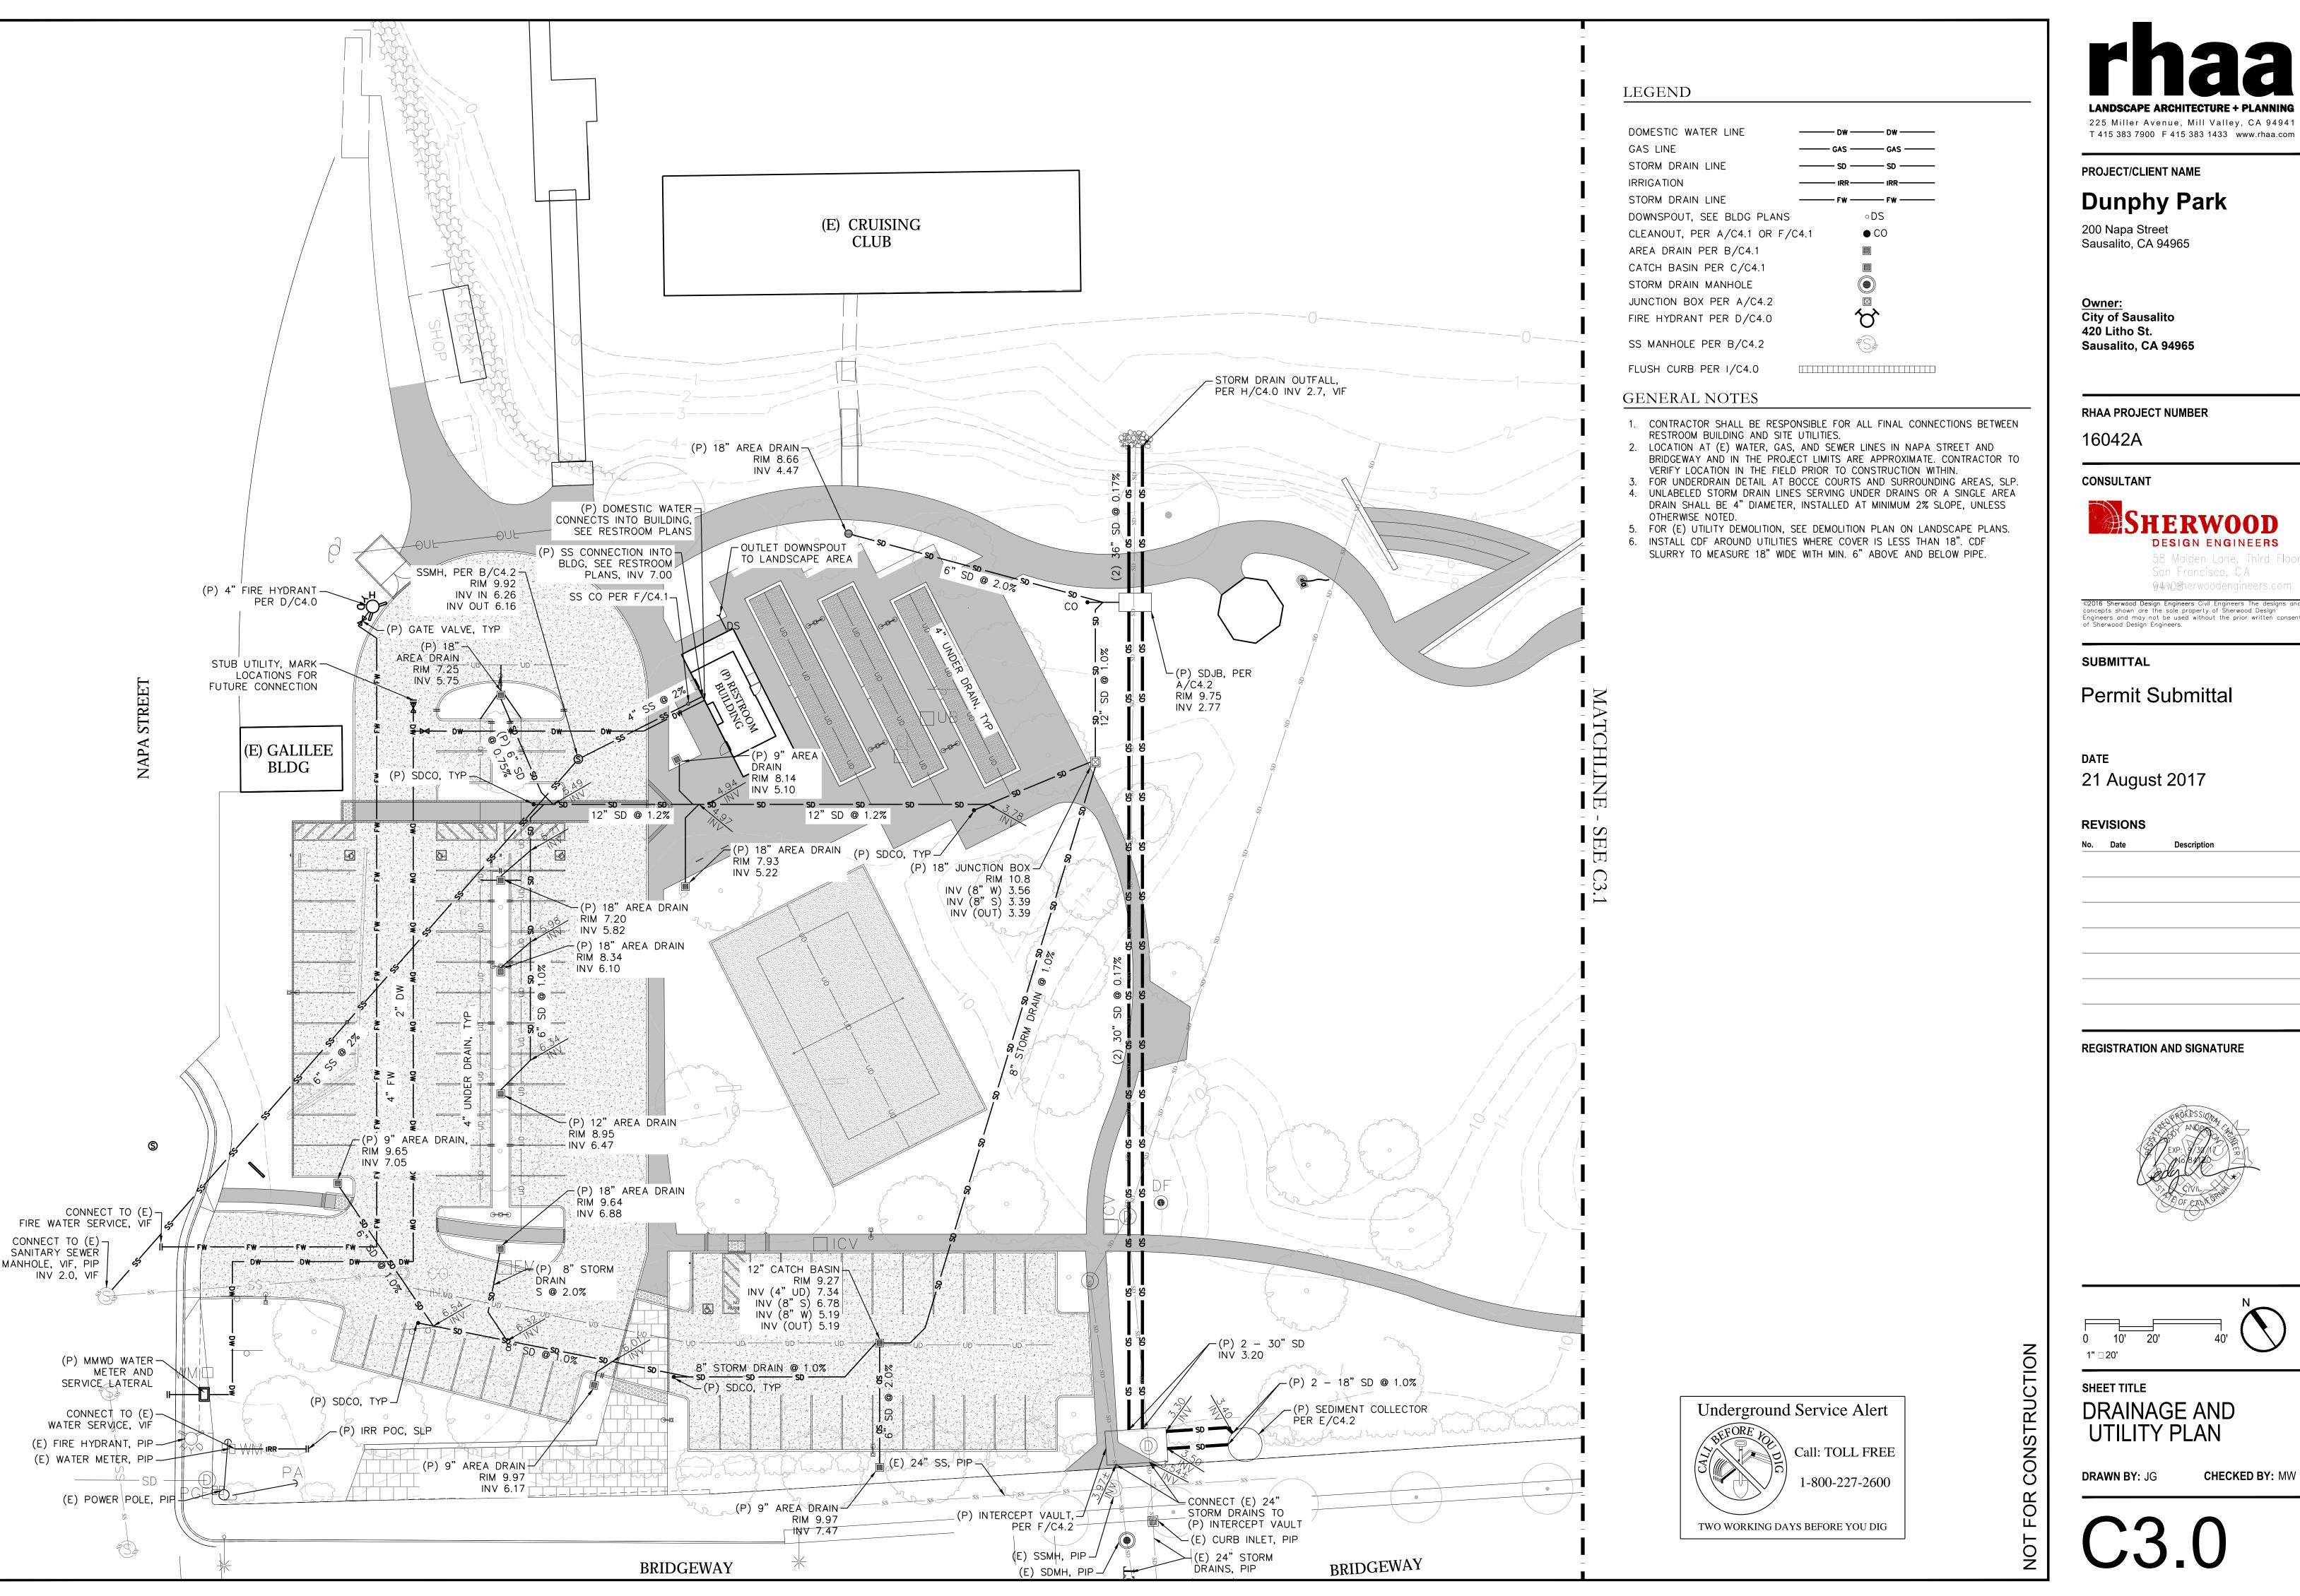
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SHEET TITLE DRAINAGE PLAN



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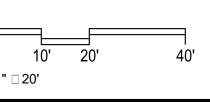
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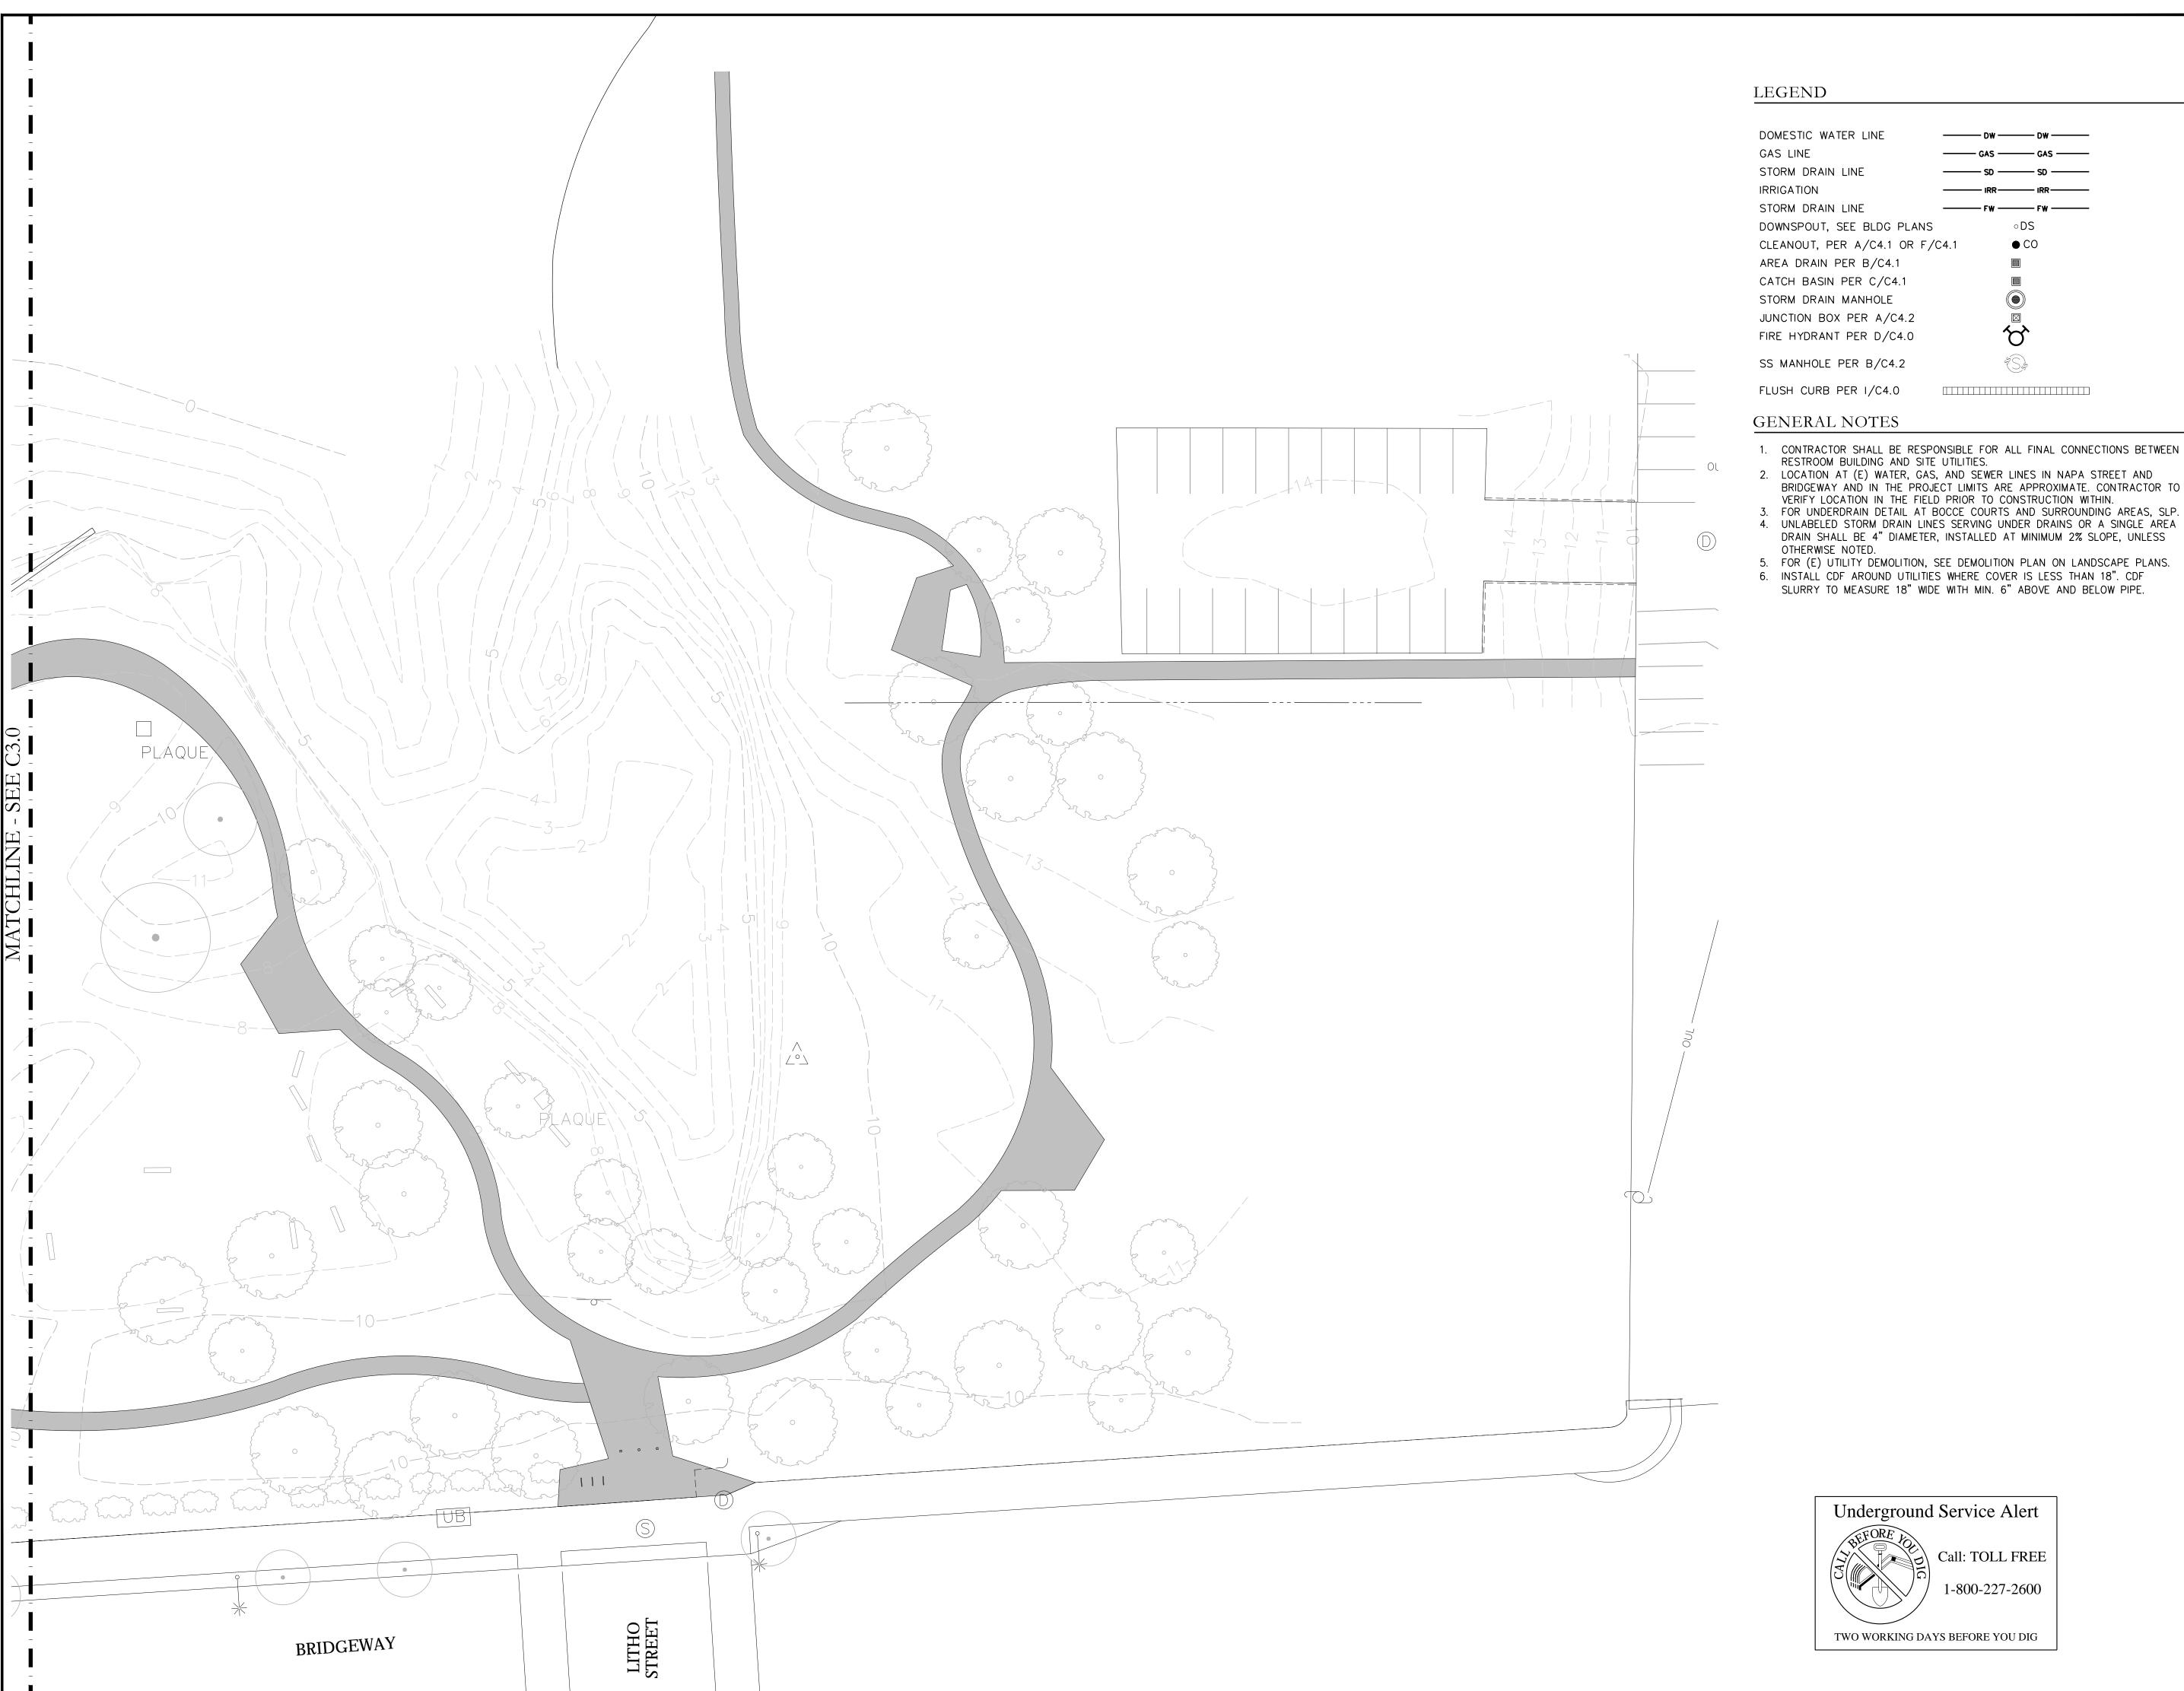
REGISTRATION AND SIGNATURE





SHEET TITLE DRAINAGE AND

CHECKED BY: MW



CO CLEANOUT, PER A/C4.1 OR F/C4.1

- 1. CONTRACTOR SHALL BE RESPONSIBLE FOR ALL FINAL CONNECTIONS BETWEEN RESTROOM BUILDING AND SITE UTILITIES.
- 2. LOCATION AT (E) WATER, GAS, AND SEWER LINES IN NAPA STREET AND BRIDGEWAY AND IN THE PROJECT LIMITS ARE APPROXIMATE. CONTRACTOR TO VERIFY LOCATION IN THE FIELD PRIOR TO CONSTRUCTION WITHIN.
- 4. UNLABELED STORM DRAIN LINES SERVING UNDER DRAINS OR A SINGLE AREA DRAIN SHALL BE 4" DIAMETER, INSTALLED AT MINIMUM 2% SLOPE, UNLESS
- 5. FOR (E) UTILITY DEMOLITION, SEE DEMOLITION PLAN ON LANDSCAPE PLANS. 6. INSTALL CDF AROUND UTILITIES WHERE COVER IS LESS THAN 18". CDF
- SLURRY TO MEASURE 18" WIDE WITH MIN. 6" ABOVE AND BELOW PIPE.

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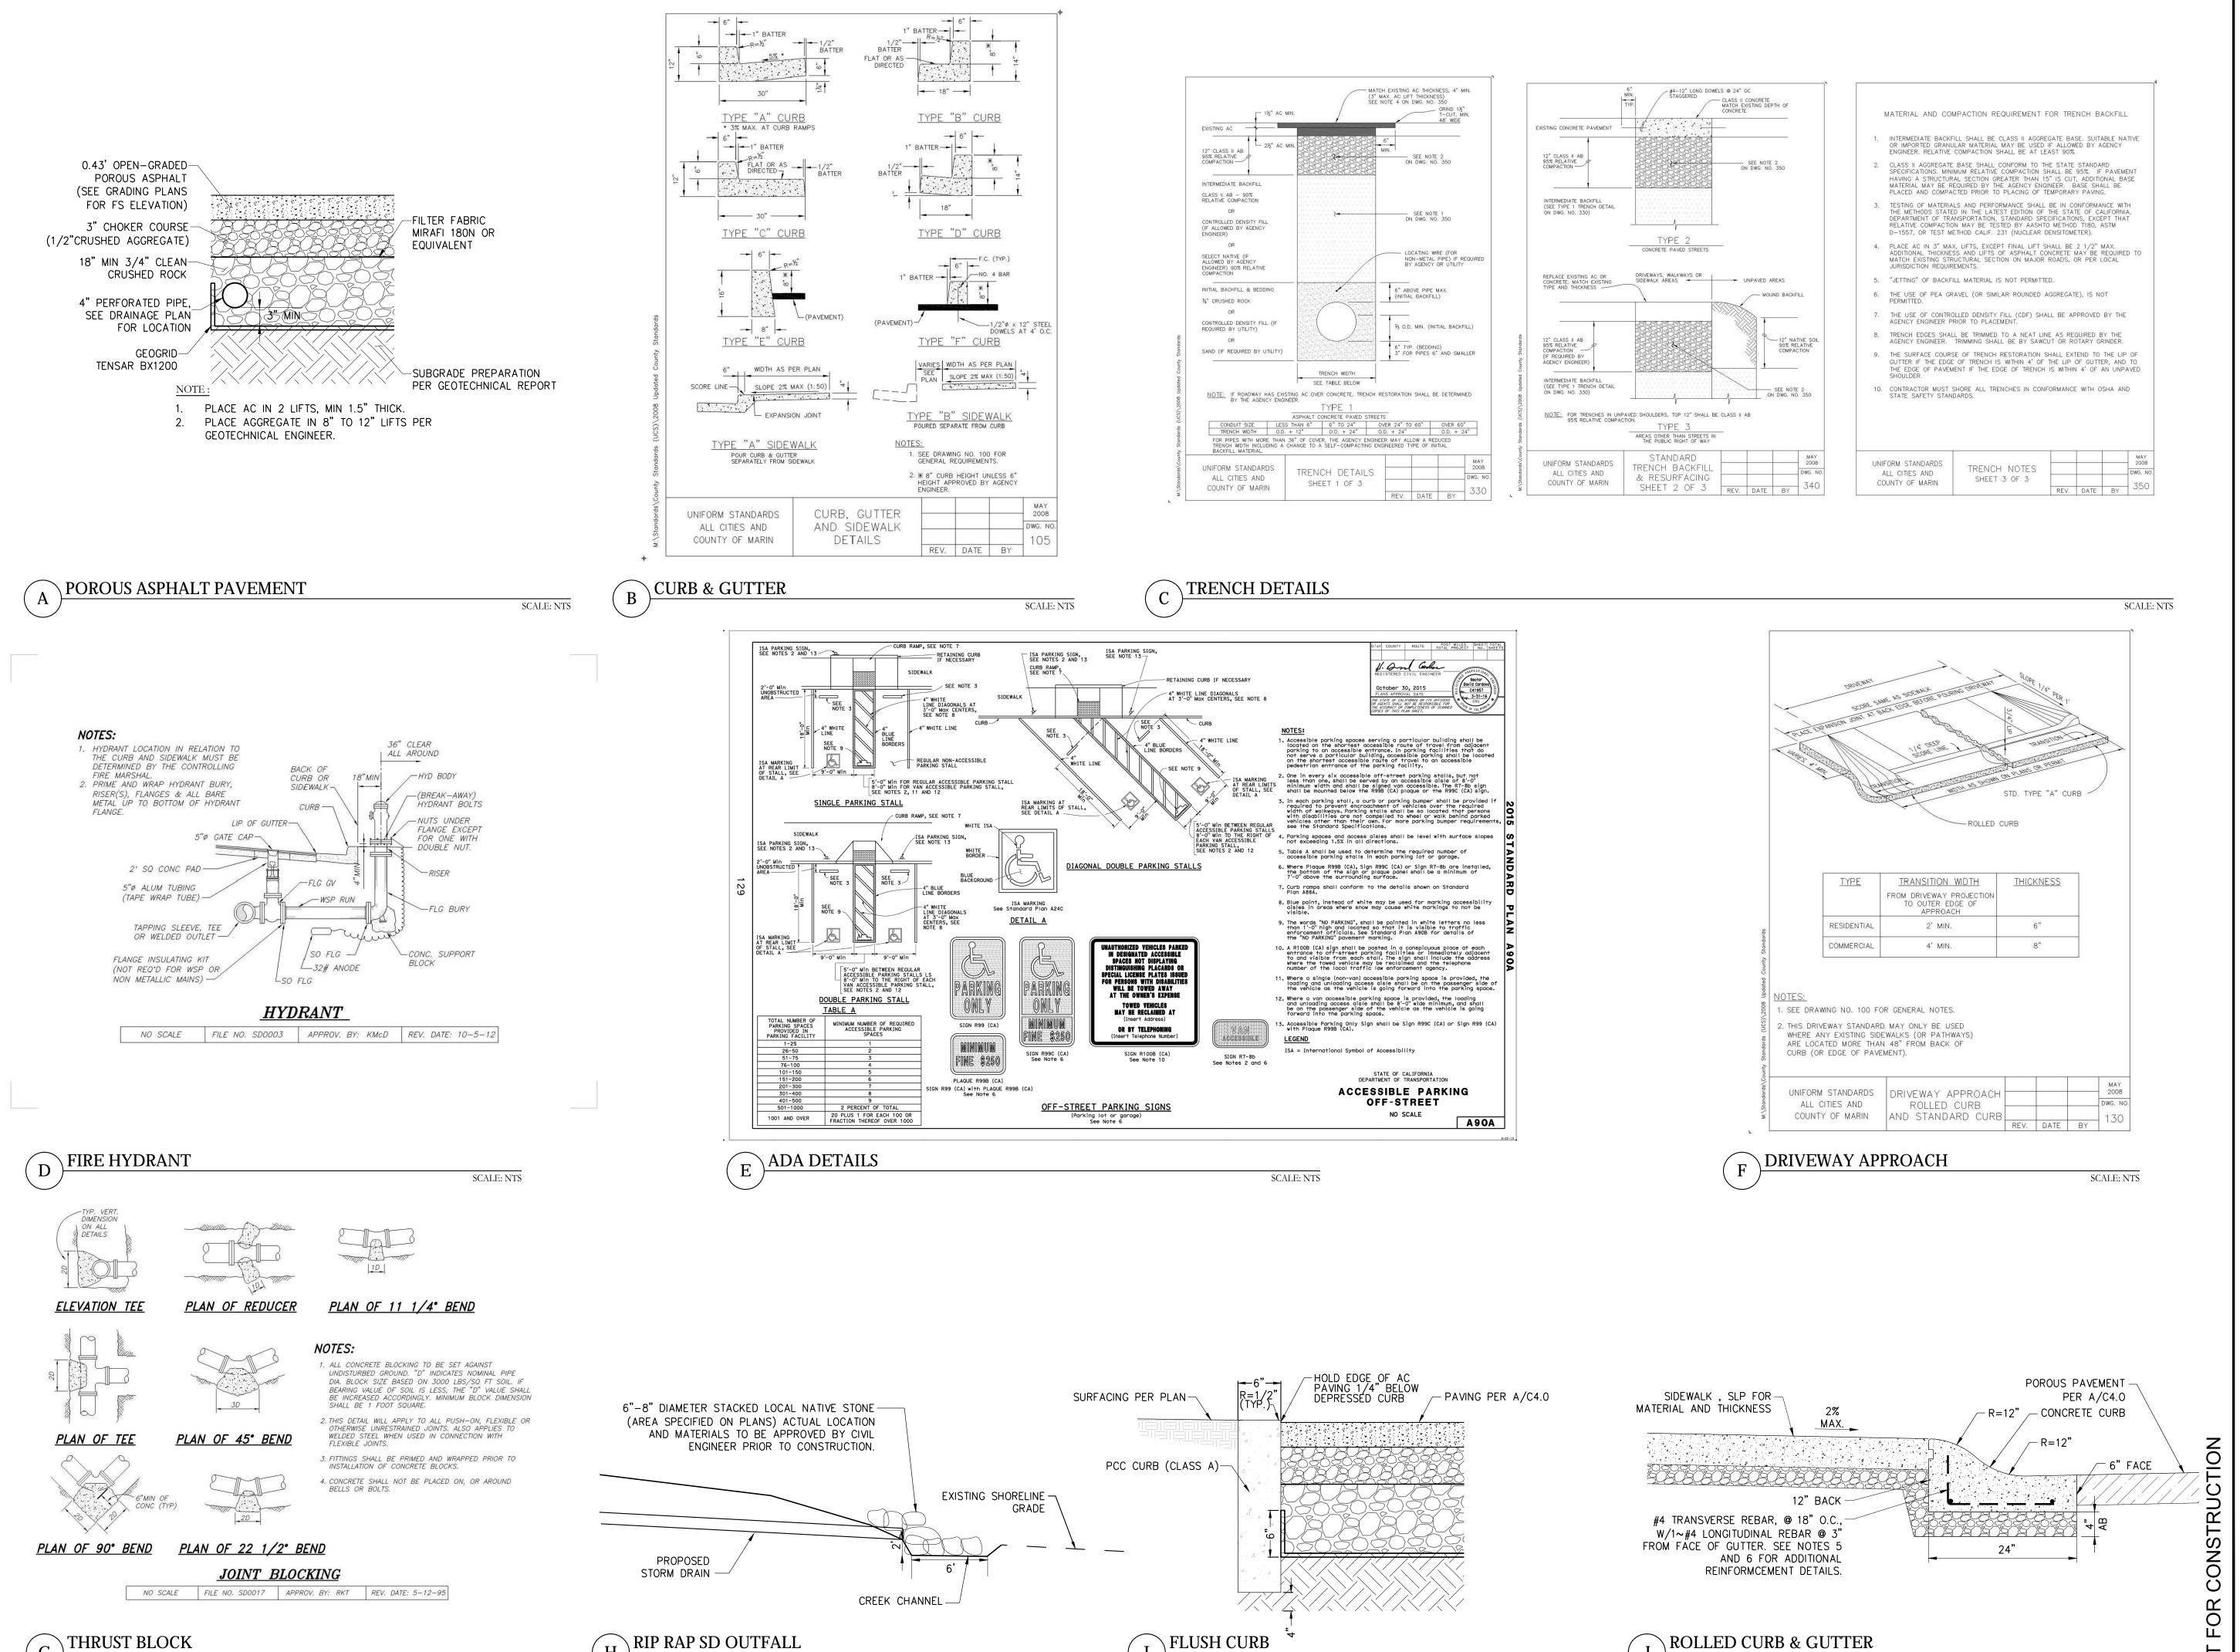
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	10'	20'	40'	
1" □	20'			

SHEET TITLE

DRAINAGE AND UTILITY PLAN



SCALE: NTS

RIP RAP SD OUTFALL

SCALE: NTS

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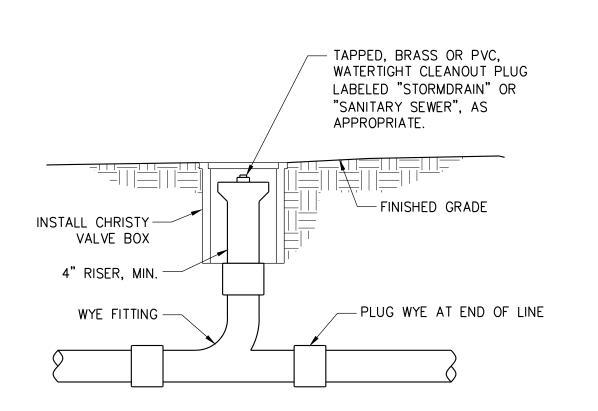
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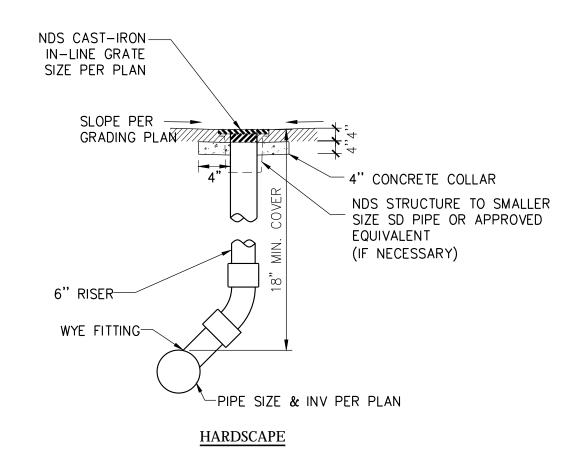
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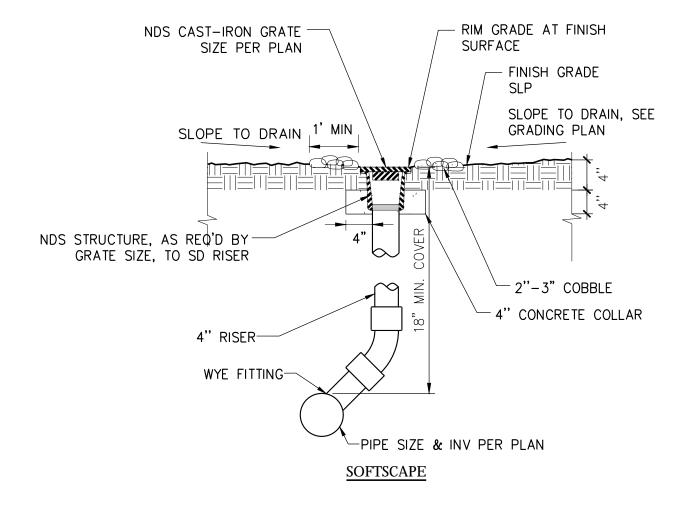
ROLLED CURB & GUTTER

SCALE: NTS

CHECKED BY: MW












HARDSCAPE AND SOFTSCAPE AREA DRAIN

SCALE: NTS

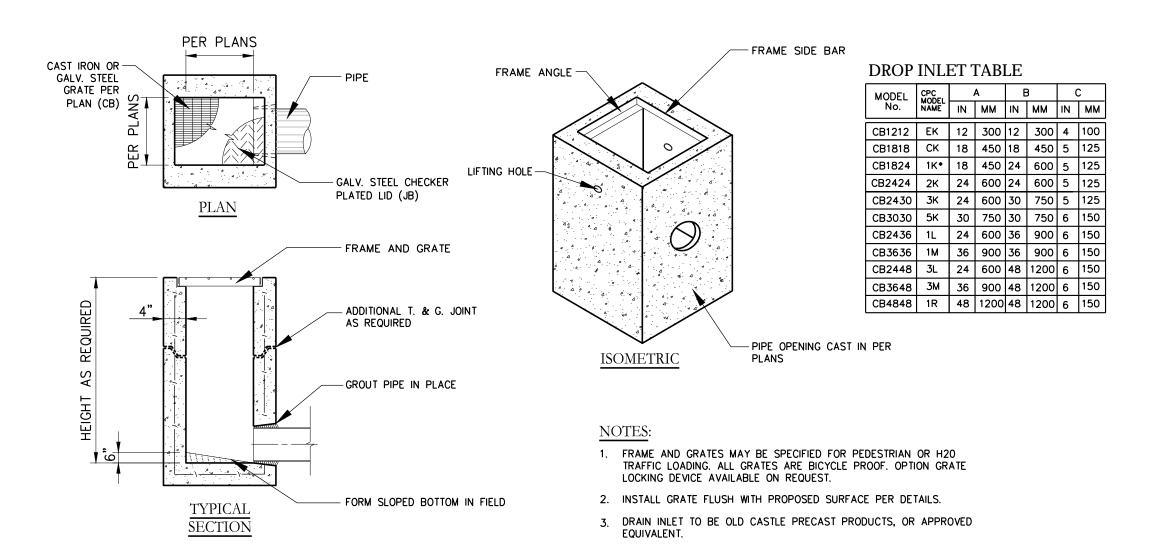

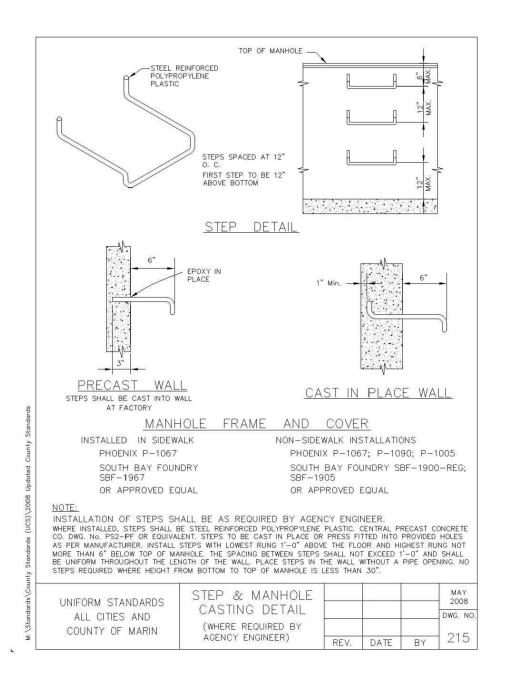

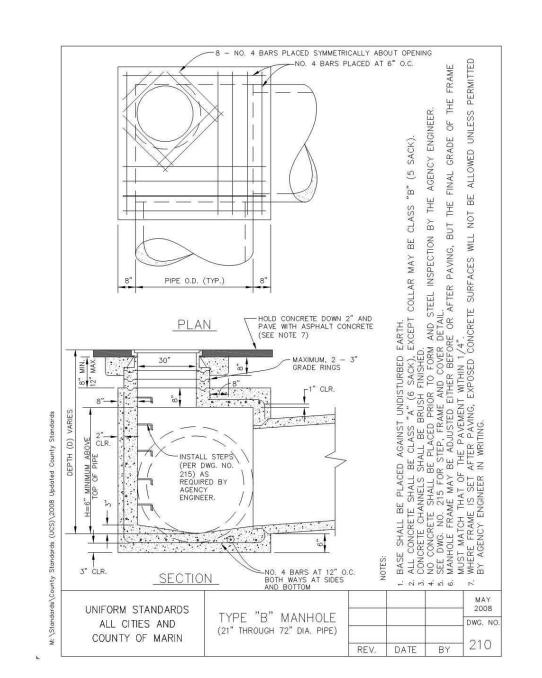





STORM DRAIN STEP & MANHOLE CASTING DETAIL





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SCALE: NTS

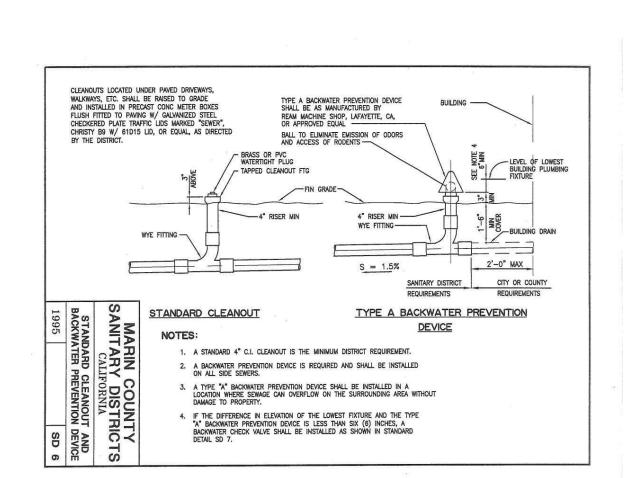

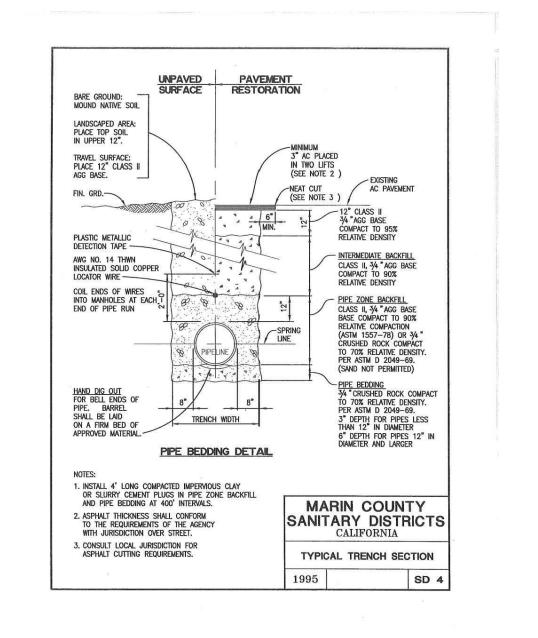

SANITARY SEWER CLEANOUT

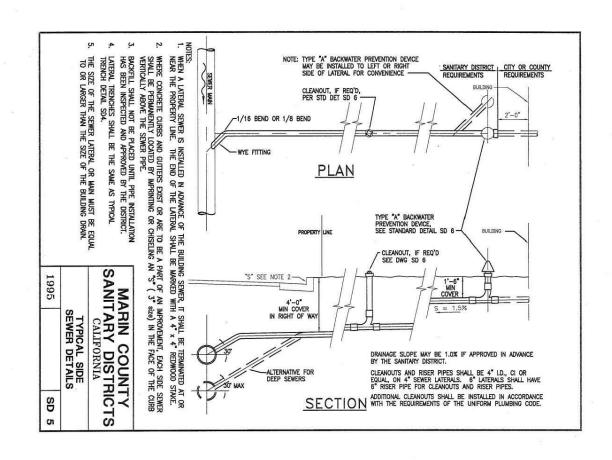TYPICAL SANITARY SEWER TRENCH SECTION

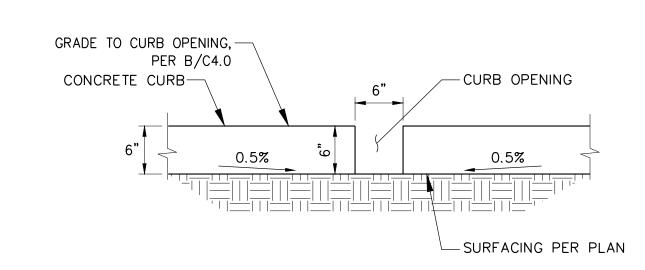TYPICAL SIDE SEWER DETAIL

CURB OPENING SCALE: NTS 225 Miller Avenue, Mill Valley, CA 94941 T 415 383 7900 F 415 383 1433 www.rhaa.com

PROJECT/CLIENT NAME

Dunphy Park

200 Napa Street Sausalito, CA 94965

City of Sausalito 420 Litho St. Sausalito, CA 94965

RHAA PROJECT NUMBER

16042A

CONSULTANT



58 Maiden Lane, Third Floor 94W08herwoodengineers.com

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Permit Submittal

21 August 2017

REVISIONS

Description

REGISTRATION AND SIGNATURE




SHEET TITLE **DETAILS**

DRAWN BY:


JUNCTION BOX

2. PROVIDE ACCESS STEPS (NOT SHOWN) PER D/C4.1

SCALE: NTS

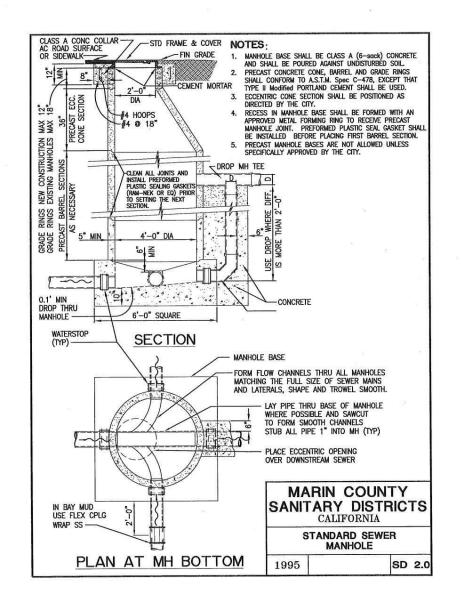


SEWER MANHOLE SCALE: NTS

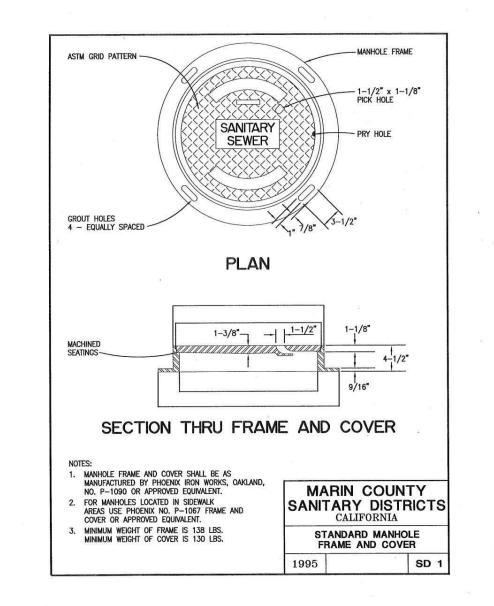

SEWER MANHOLE FRAME AND COVER

STANDARD DETAIL

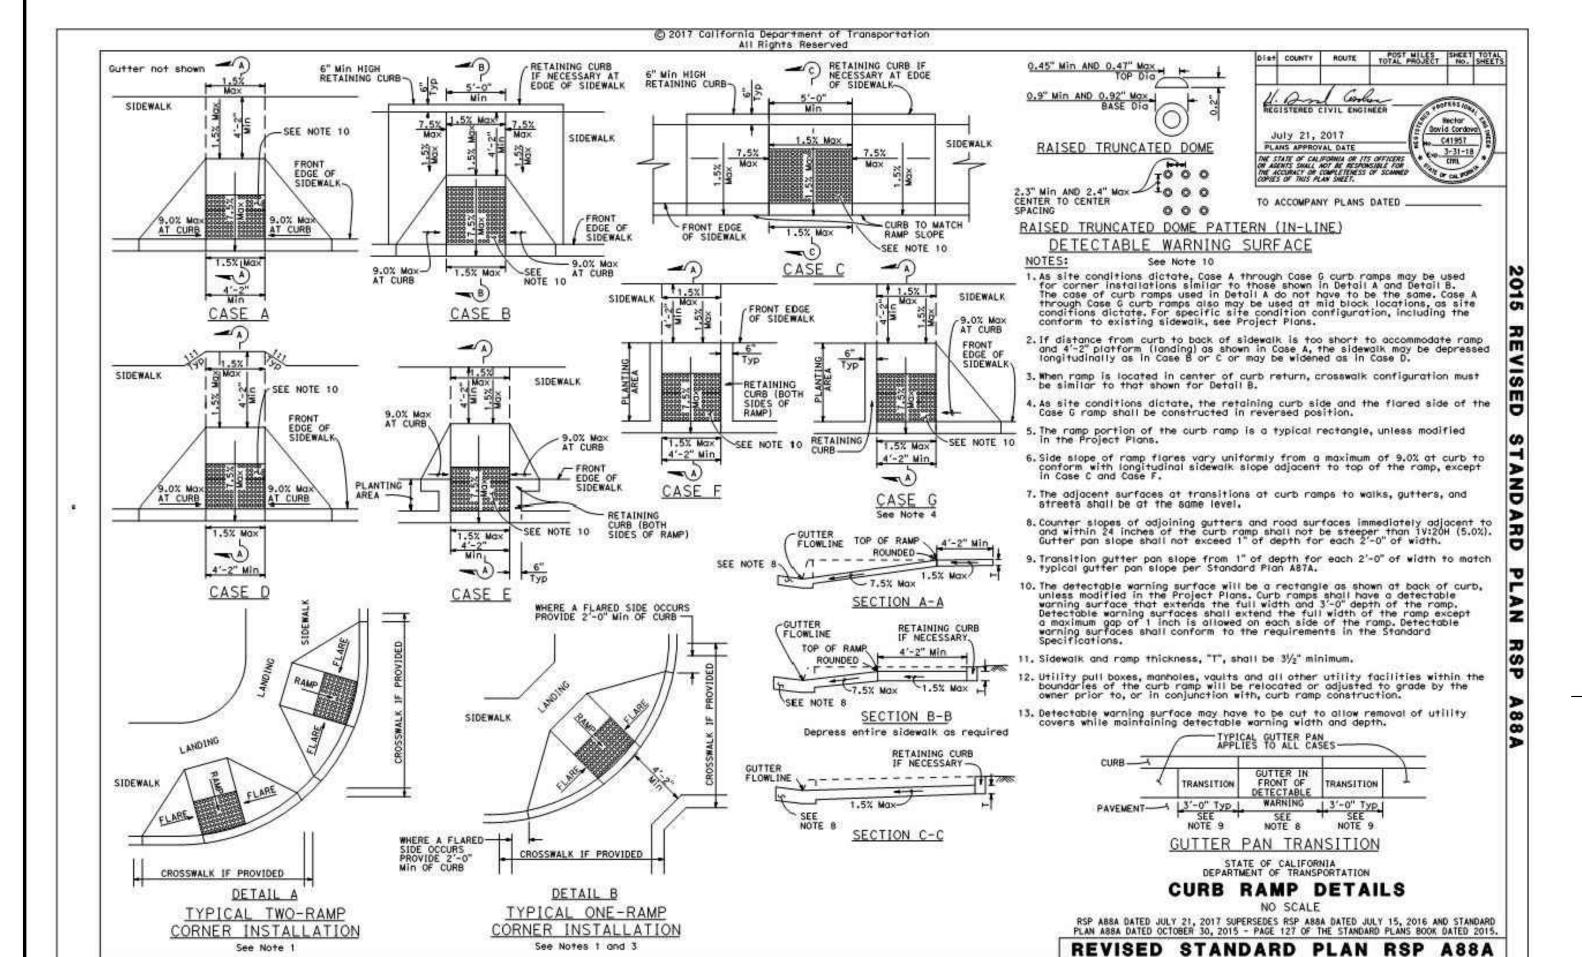

1. SLP FOR TRUNCATED DOMES

CDS5653-10-C DESIGN NOTES DS683-10-C RATED TREATMENT CAPACITY IS 14.0 CFS [396.5 Lt], OR PER LOCAL REGULATIONS. MAXIMUM HYDRAULIC INTERNAL BYPASS CAPACIT 50.0 CFS [1416 Lt], IF THE SITE CONDITIONS EXCEED 50.0 CFS [1416 Lt], AN UPSTREAM BYPASS STRUCTURE IS REQUIRED, THE STANDARD C055653-10-C CONFIGURATION IS SHOWN. ALTERNATE CONFIGURATIONS ARE AVAILABLE AND ARE LISTED BELOW. SOME CONFIGURATIONS MAY BE COMBINED TO SUIT SITE REQUIREMENTS. CONFIGURATION DESCRIPTION GRATED INLET ONLY (NO INLET PIPE)
GRATED INLET WITH INLET PIPE OR PIPES
CURB INLET ONLY (NO INLET PIPE) JRB INLET WITH INLET PIPE OR PIPES
PARATE OIL BAFFLE (SINGLE INLET PIPE REQUIRED FOR THIS CONFIGURATION) SEDIMENT WEIR FOR NUDEP / NUCAT CONFORMING UNITS SITE SPECIFIC DATA REQUIREMENTS THE OT TO PROVIDE ALL MATERIALS UNLESS NOTED OTHERWISE.


HENDING MARKEN WITH () ARE REFERRICE DIMENSIONS, ACTUAL DIMENSIONS MAY VARY.

FARRICATION FORWARD WITH () ARE REFERRICE DIMENSIONS, ACTUAL DIMENSIONS MAY VARY.

FARRICATION FORWARD WITH DETAILED STRUCTURE DIMENSIONS AND WEIGHTS, PLEASE CONTACT YOUR CONTECH ENGINEERED.

UTONS LUC REPRESENTATIVE. WAS CONTEINED SOON. STALIATION NOTES

ANY SUBBASE, BACKFILL DEPTH, AND/OR ANTI-FLOTATION PROVISIONS ARE SITE-SPECIFIC DESIGN CONSIDERATIONS AND SHALL BE SPECIFIED OF PROVIDED AS PROPERTY. D.
DE EQUIPMENT WITH SUFFICIENT LIFTING AND REACH CAPACITY TO LIFT AND SET THE CDS MANHOLE STRUCTURE
ADDROLL ESPITATIVICUS.
ADD JOINT SEALANT BETWEEN ALL STRUCTURE SECTIONS, AND ASSEMBLE STRUCTURE,
PROVIDE, INSTALL, AND GROUT PIPES. MATCH PIPE INVERTS WITH ELEVATIONS SHOWN.
TAKE APPROPRIATE MEASURES TO ASSURE UNIT IS WATER TIGHT, HOLDING WATER TO FLOWLINE INVERT MINIMUM, IT IS
TALL JOINTS BELOW PIPE INVERTS ARE GROUTED. CDS.

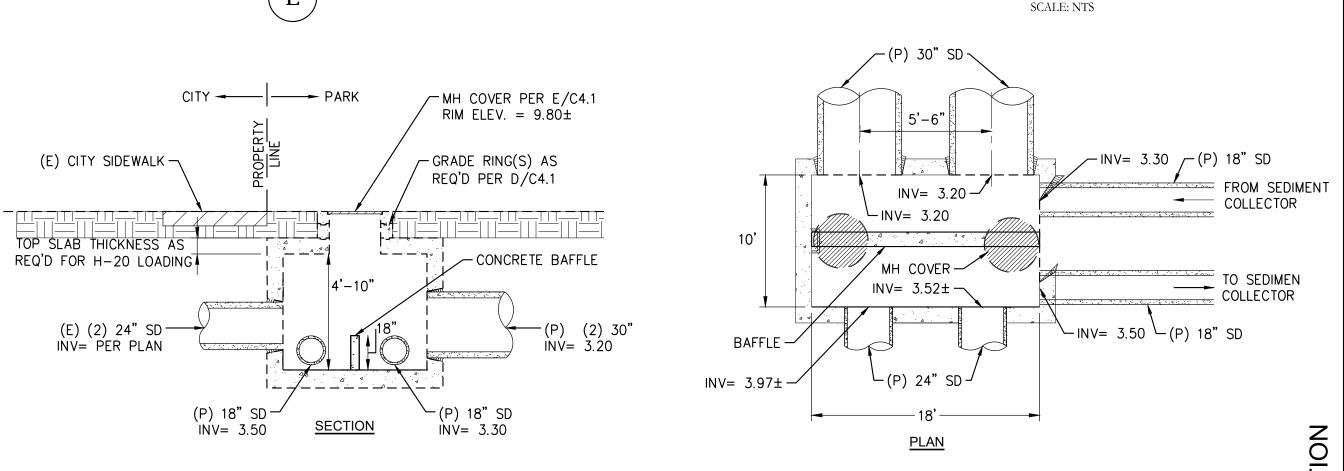

1. BOX TO BE JENSEN PRECAST OR EQUIVALENT. 2. PROVIDE ACCESS STEPS (NOT SHOWN) PER D/C4.1

SCALE: NTS

SEDIMENT TRAP

\INTERCEPT VAULT

SCALE: NTS



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Dunphy Park

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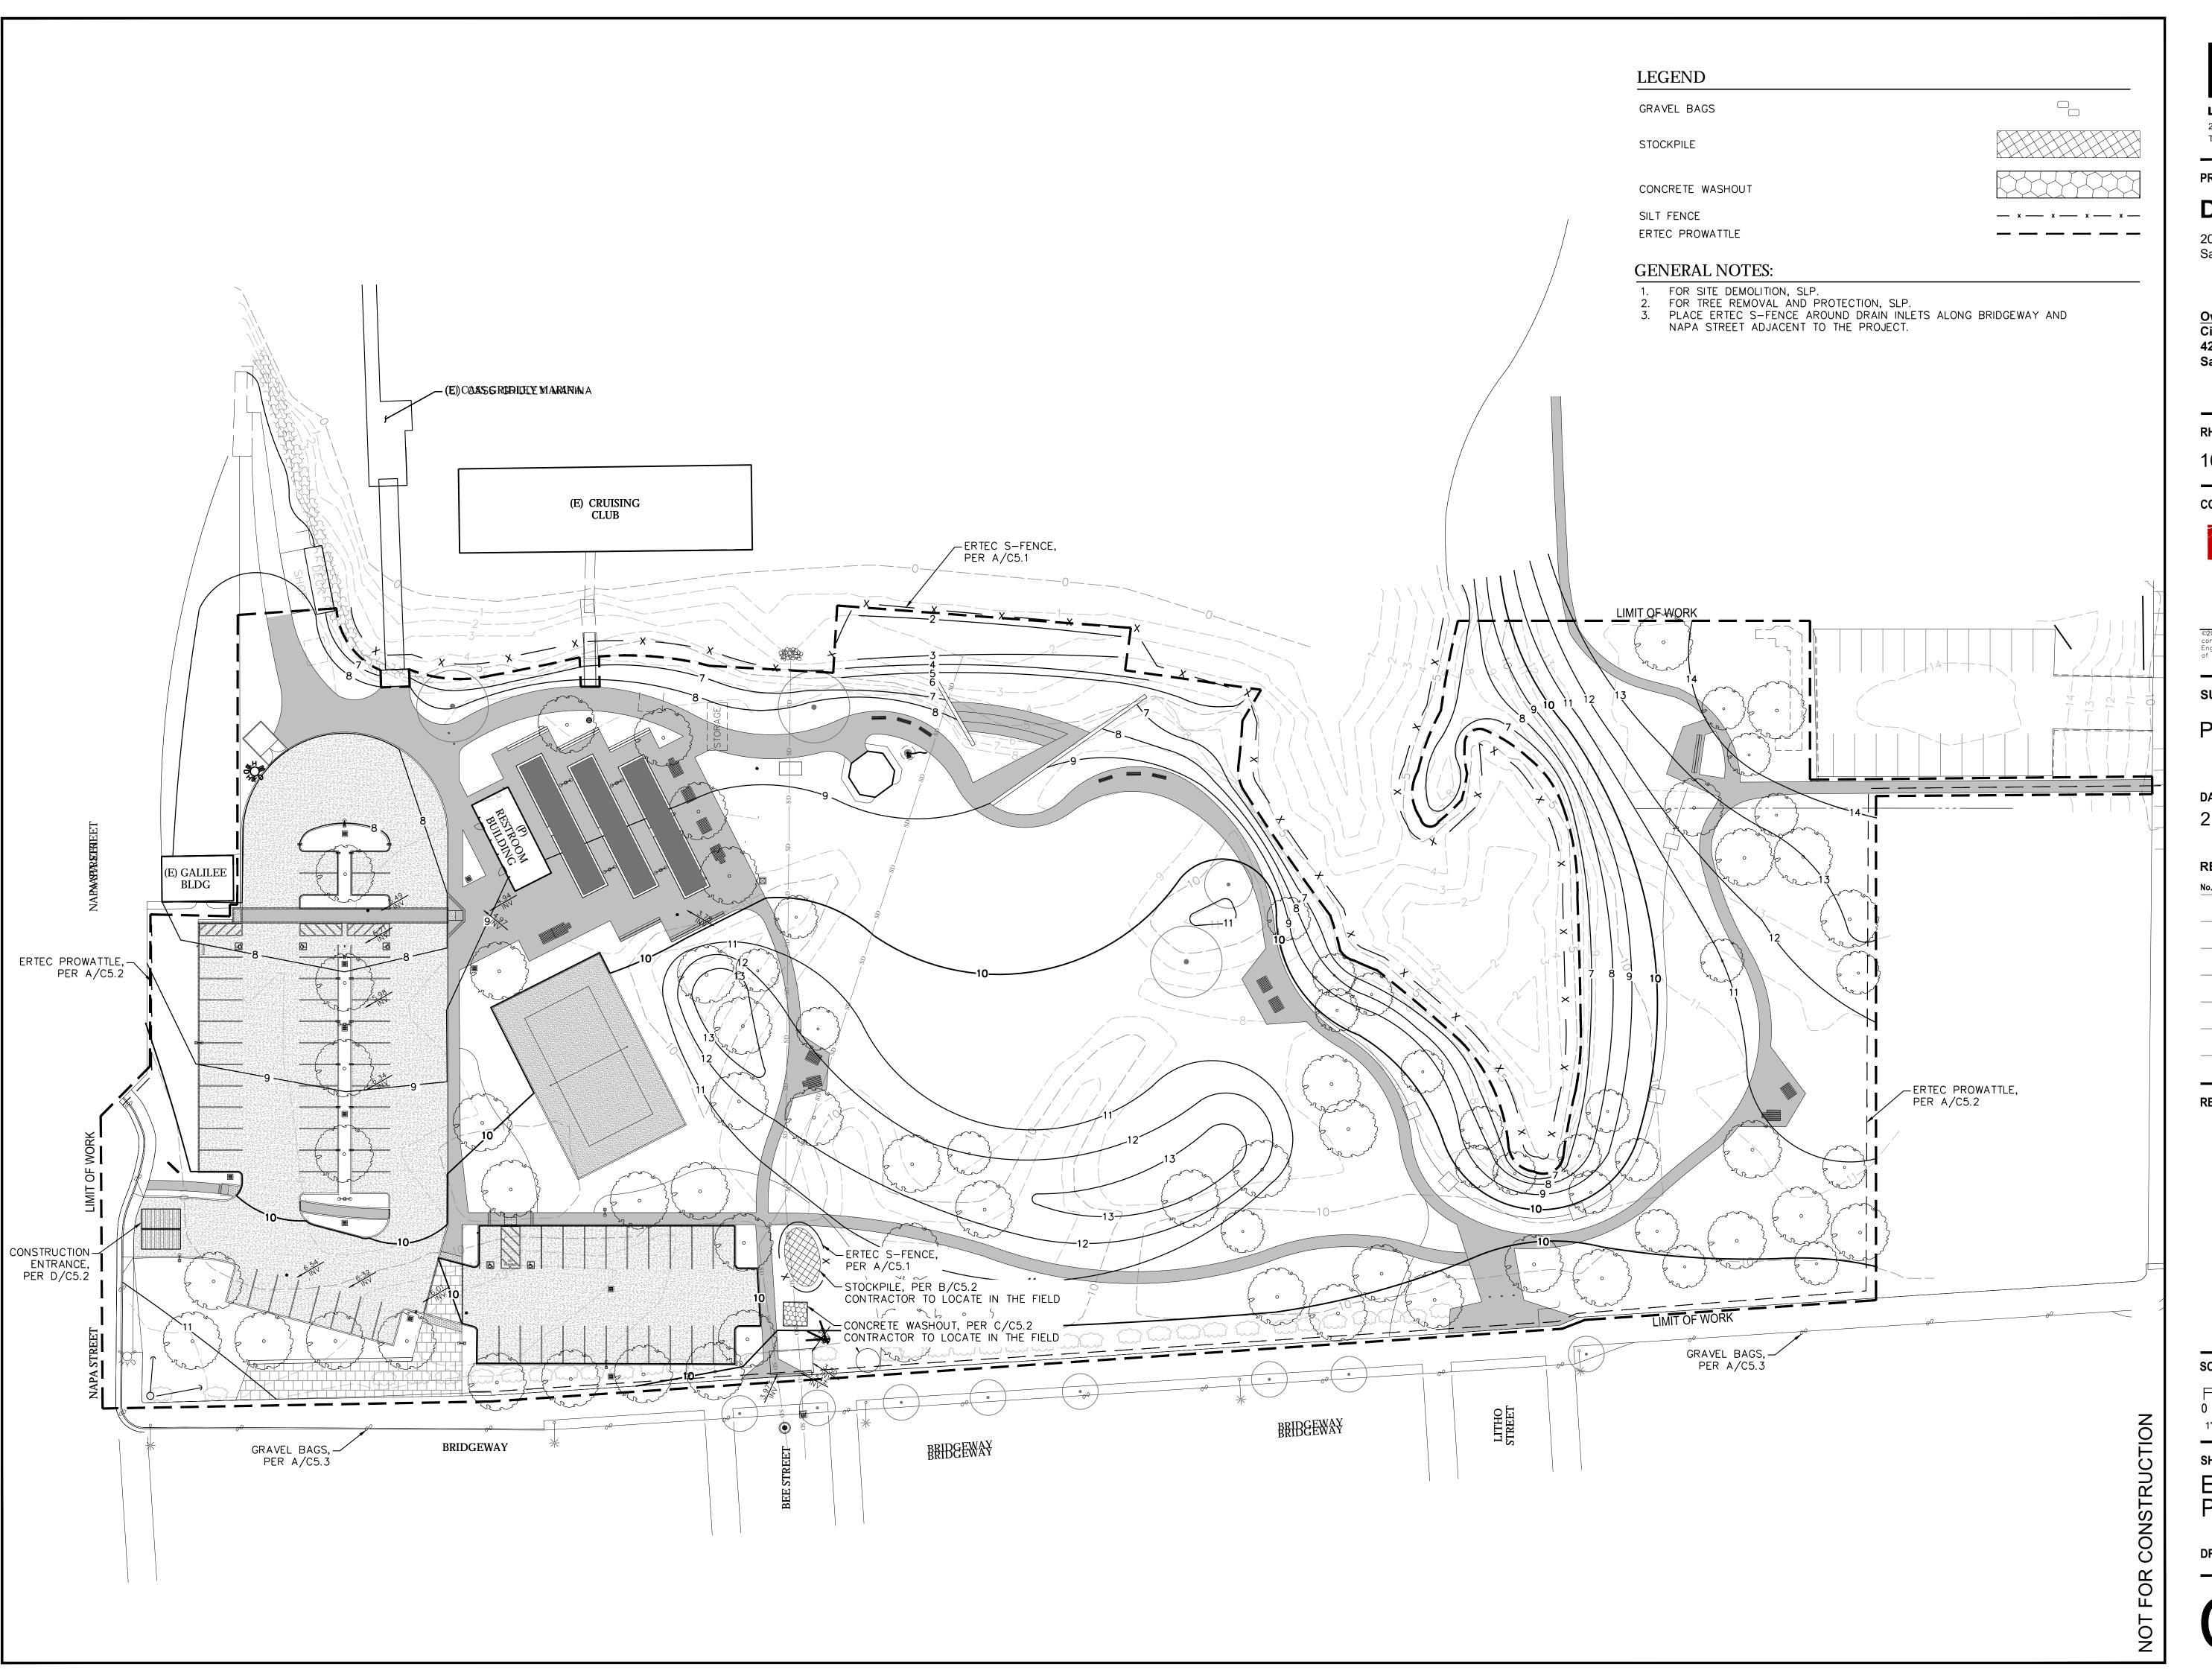
Description

REGISTRATION AND SIGNATURE



SHEET TITLE **DETAILS**

DRAWN BY:



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PROJECT/CLIENT NAME

Dunphy Park

200 Napa Street Sausalito, CA 94965

Owner: City of Sausalito 420 Litho St. Sausalito, CA 94965

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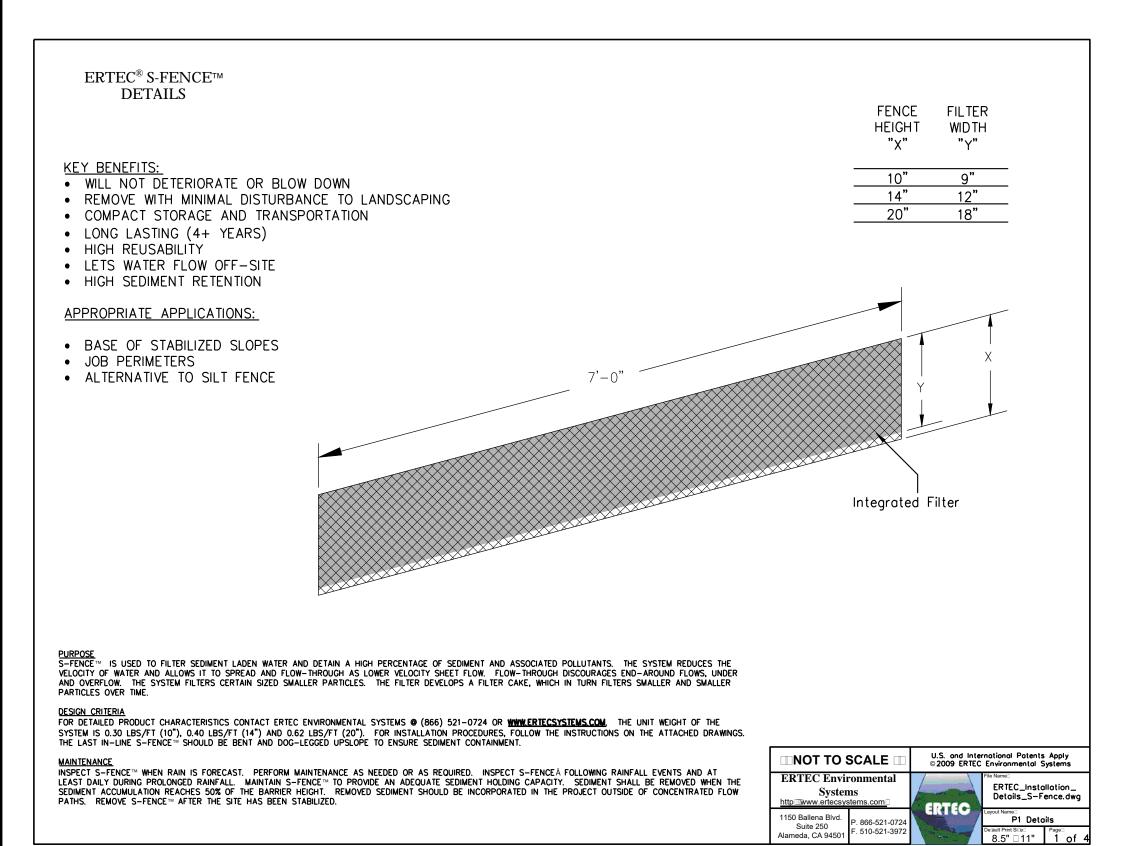
REGISTRATION AND SIGNATURE





SHEET TITLE **EROSION CONTROL** PLAN


DRAWN BY: JG

CHECKED BY: MW



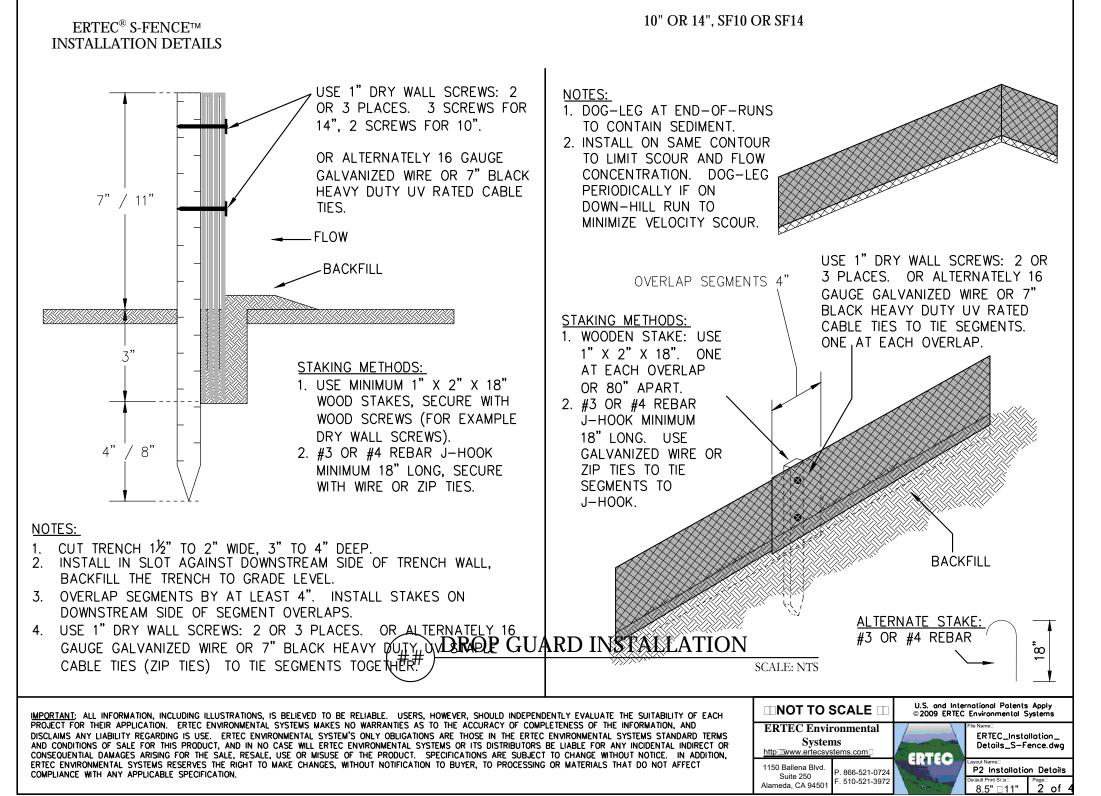

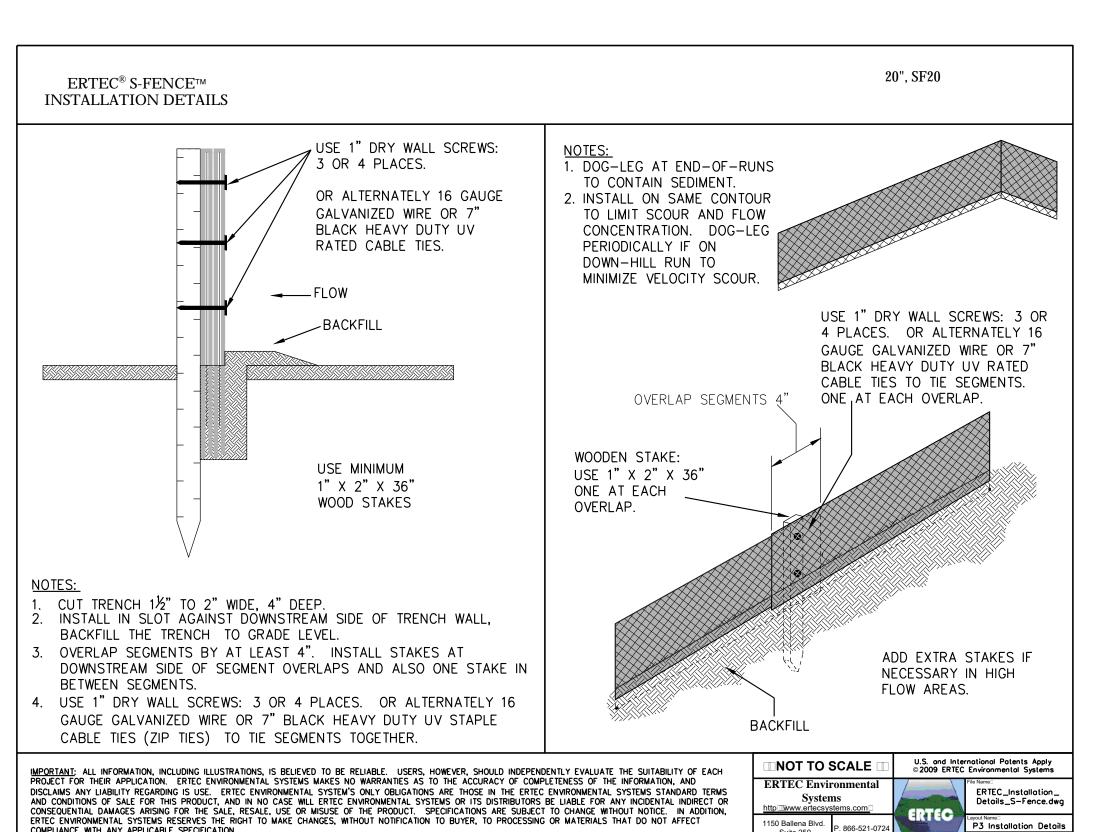

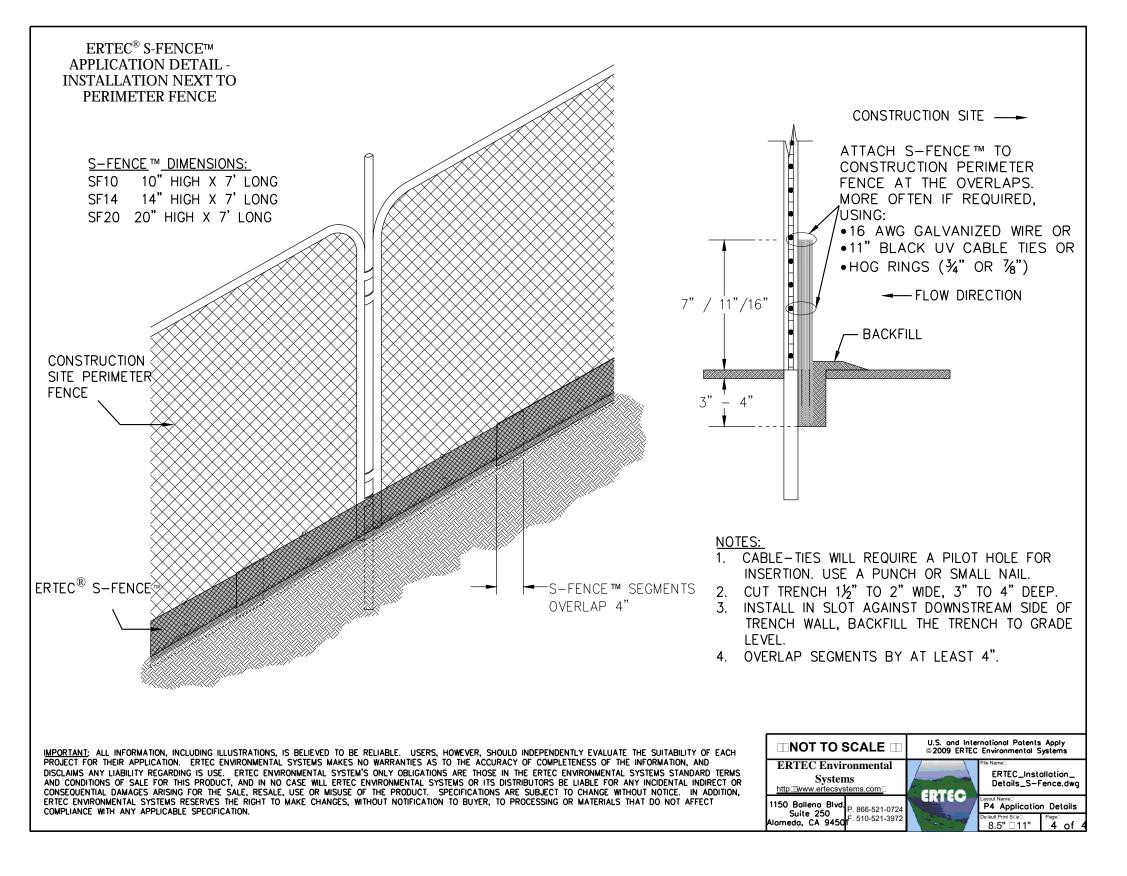

S-FENCE INSTALLATION

SCALE: NTS

LANDSCAPE ARCHITECTURE + PLANNING
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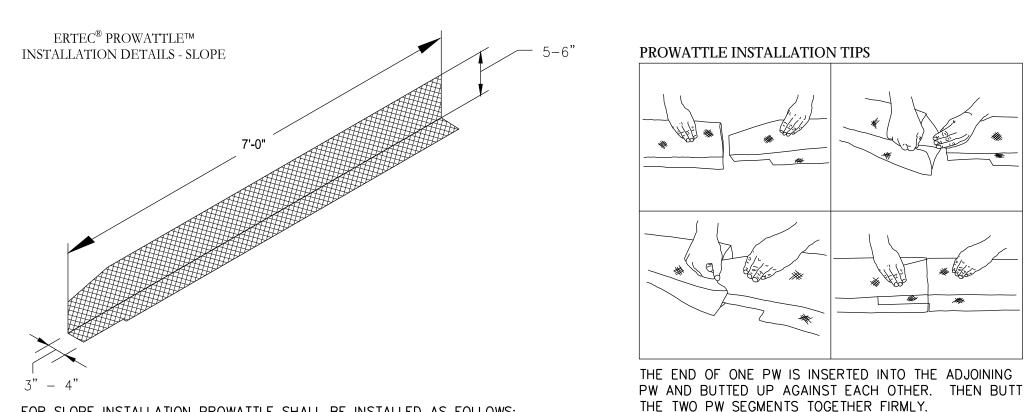


SHEET TITLE
EROSION CONTROL
DETAILS

DRAWN BY: JG

CHECKED BY: MW

C5.1



FOR SLOPE INSTALLATION PROWATTLE SHALL BE INSTALLED AS FOLLOWS: 1. A SHELF-CUT SHALL BE CONSTRUCTED 4" HORIZONTALLY INTO THE SLOPE.

2. STAKES SHALL BE INSTALLED ON SLOPES. INSTALL STAKES 5 FEET APART. STAKES SHALL BE DRIVEN FLUSH WITH THE TOP OF THE PROWATTLE. WOOD STAKES SHALL BE AT MINIMUM: 1" X 1" X 12". REBAR J-HOOK STAKES (#3 OR #4) MUST BE A MINIMUM OF 18" LONG. 3. PROWATTLE SHALL BE PLACED AS FOLLOWS:

1: 4 AND 1:10

1:10 AND FLATTER

FEET APART ALONG THE SLOPE SLOPE INCLINATION (VERTICAL: HORIZONTAL) 10 FEET 1:2 AND STEEPER 15 FEET 1:2 TO 1:4 20 FEET

4. THE SHELF-CUT FOR PROWATTLE SHALL BE CLEARED OF OBSTRUCTIONS INCLUDING, BUT NOT LIMITED TO, ROCKS, CLODS, AND DEBRIS GREATER THAN 1" IN DIAMETER PRIOR TO INSTALLATION.


5. PROWATTLE SHALL BE INSTALLED PARALLEL TO THE SLOPE CONTOUR. 6. PROWATTLE SHALL BE INSTALLED PRIOR TO THE APPLICATION OF OTHER TEMPORARY EROSION CONTROL OR SOIL STABILIZATION MATERIALS IN THE SAME AREA.


7. WHEN NO LONGER REQUIRED, PROWATTLE CAN BE REMOVED AND REUSED. CRACK LOOSE AND SHAKE SEDIMENT FROM PROWATTLE SEGMENT. IT IS NOT NECESSARY TO CLEAN PROWATTLE OF ALL REMAINING SEDIMENT PRIOR TO REUSE

(IT IS NOT NECESSARY TO PRESSURE-WASH PROWATTLE BETWEEN INSTALLATIONS). THE RESIDUAL SEDIMENT THAT REMAINS ON THE FILTER CAN BE BENEFICIAL AS A SECONDARY FILTER (FILTER CAKE) UPON SUBSEQUENT INSTALLATIONS. PRIOR TO REUSE, PERFORM 2-STEP QUALITY INSPECTION AS PER INSTALLATION GUIDE (WWW.ERTECSYSTEMS.COM).

50 FEET

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P1 Slope Detoils

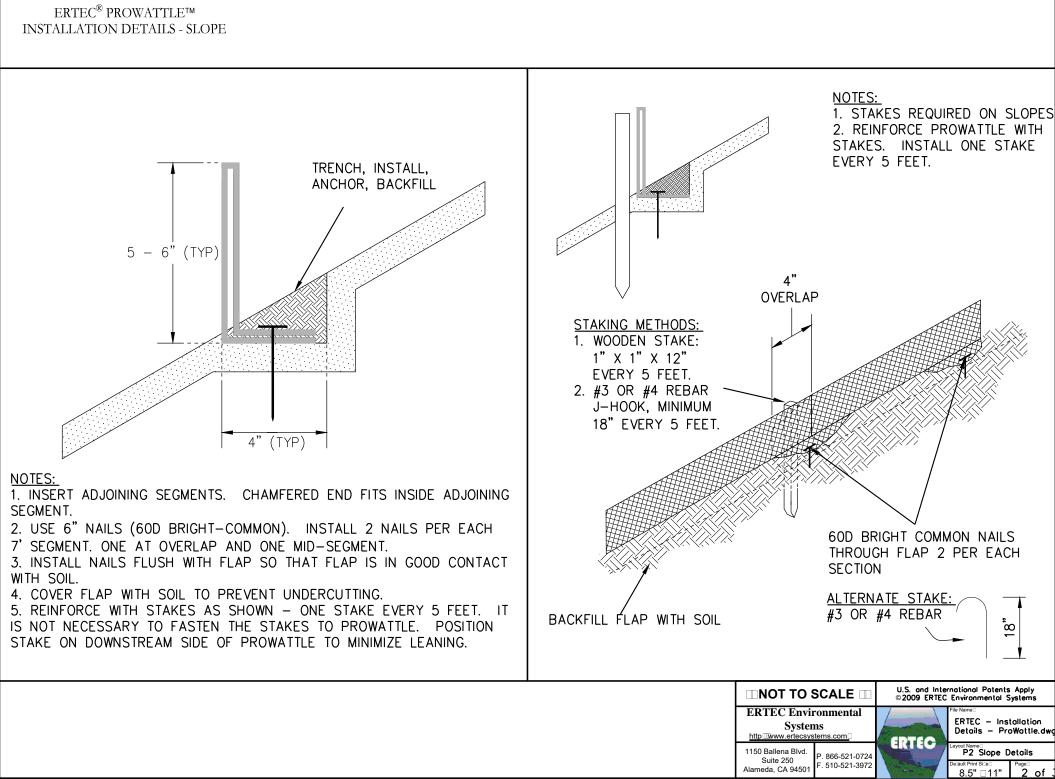

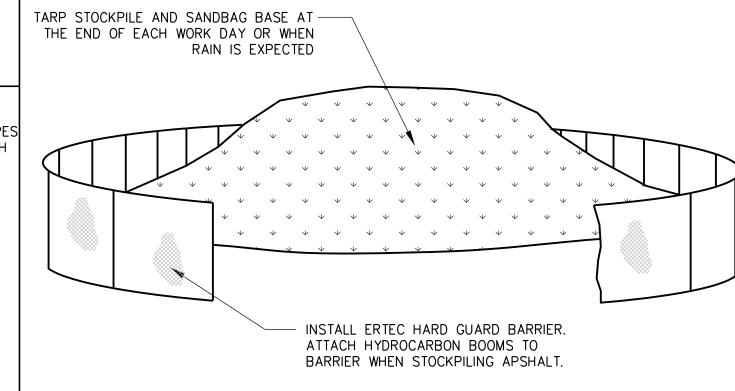


STOCKPILE

U.S. and International Patents Apply © 2009 ERTEC Environmental Systems ERTEC — Installation Details — ProWattle.dw P2 Slope Details

TWO-STACKED 2X12 -

STAKE, \neg

ROUGH WOOD FRAME

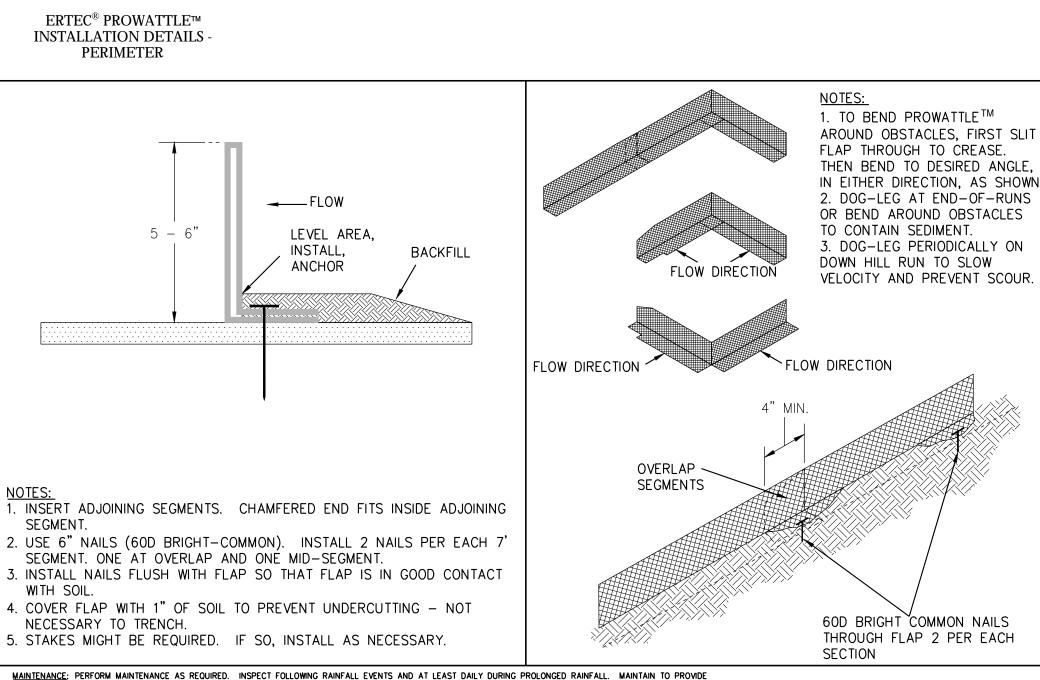

MAINTENANCE: PERFORM MAINTENANCE AS REQUIRED. INSPECT FOLLOWING RAINFALL EVENTS AND AT LEAST DAILY DURING PROLONGED RAINFALL. MAINTAIN TO PROVIDE AN ADEQUATE SEDIMENT HOLDING CAPACITY. DEBRIS SHALL BE REMOVED DAILY AND SEDIMENT SHALL BE REMOVED WHEN THE SEDIMENT ACCUMULATION REACHES 50% OF THE BARRIER HEIGHT. REMOVED SEDIMENT SHALL BE INCORPORATED IN THE PROJECT AT DESIGNATED LOCATIONS.

IMPORTANT: ALL INFORMATION, INCLUDING ILLUSTRATIONS, IS BELIEVED TO BE RELIABLE. USERS, HOWEVER, SHOULD INDEPENDENTLY EVALUATE THE SUITABILITY OF EACH PROJECT FOR THEIR APPLICATION. ERTEC ENVIRONMENTAL SYSTEMS MAKES NO WARRANTIES AS TO THE ACCURACY OF COMPLETENESS OF THE INFORMATION, AND DISCLAIMS ANY LIABILITY REGARDING IS USE. ERTEC ENVIRONMENTAL SYSTEM'S ONLY OBLIGATIONS ARE THOSE IN THE ERTEC ENVIRONMENTAL SYSTEMS STANDARD TERMS AND CONDITIONS OF SALE FOR THIS PRODUCT, AND IN NO CASE WILL ERTEC ENVIRONMENTAL SYSTEMS OR ITS DISTRIBUTORS BE LIABLE FOR ANY INCIDENTAL INDIRECT OR CONSEQUENTIAL DAMAGES ARISING FOR THE SALE, RESALE, USE OR MISUSE OF THE PRODUCT. SPECIFICATIONS ARE SUBJECT TO CHANGE WITHOUT NOTICE. IN ADDITION, ERTEC ENVIRONMENTAL SYSTEMS RESERVES THE RIGHT TO MAKE CHANGES, WITHOUT NOTIFICATION TO BUYER, TO PROCESSING OR MATERIALS THAT DO NOT AFFECT COMPLIANCE WITH ANY APPLICABLE SPECIFICATION COMPLIANCE WITH ANY APPLICABLE SPECIFICATION.

\ ERTEC PROWATTLE

U.S. and International Patents Apply © 2009 ERTEC Environmental Systems **■NOT TO SCALE** Systems P3 Perimeter

SCALE: NTS

8" MIN. GRAVEL EX. PAVEMENT PROFILE PROVIDE APPROPRIATE TRANSITION BETWEEN STABILIZED CONSTRUCTION ENTRANCE AND PUBLIC RIGHT OF WAY ENTIRE GROUND - RIGHT OF WAY

CONSTRUCTION SPECIFICATIONS

1. THE MATERIAL FOR CONSTRUCTION SHALL BE 2 TO 3 INCH ROCK

2. LENGTH - AS EFFECTIVE, BUT NOT LESS THAN 50 FEET

3. THICKNESS - NOT LESS THAN EIGHT (8) INCHES.

4. WIDTH - NOT LESS THAN FULL WIDTH OF ALL POINTS OF INGRESS OR EGRESS.

-10 MIL PLASTIC

TWO STAKES

- WOOD FRAME SECURELY FASTENED

SECTION A-A

AROUND ENTIRE PERIMETER WITH

5. WASHING — WHEN NECESSARY; WHEELS SHALL BE CLEANED TO REMOVE SEDIMENT PRIOR TO ENTRANCE ONTO PUBLIC RIGHT OF WAY. WASHING IS REQUIRED, IT SHALL BE DONE ON AN AREA WITH CRUSHED STONE WHICH DRAINS INTO AN APPROVED SEDIMENT TRAP OR SEDIMENT BASIN. ALL SEDIMENT SHALL BE PREVENTED FROM ENTERING ANY STORM DRAIN, DITCH, OR WATERCOURSE THROUGH USE OF SAND BAGS, GRAVEL BOARDS OR OTHER APPROVED METHODS.

NOTES:

ACTUAL LAYOUT DETERMINED IN FIELD

INSTALLED WITHIN 30FT OF THE

THE CONCRETE WASHOUT SIGN SHALL BE

TEMPORARY CONCRETE WASHOUT FACILITY

MAINTENANCE - THE ENTRANCE SHALL BE MAINTAINED IN A CONDITION WHICH WILL PREVENT TRACKING OR FLOWING OF SEDIMENT ONTO PUBLIC RIGHT OF WAY. THIS MAY REQUIRE PERIODIC TOP DRESSING WITH ADDITIONAL STONES AS CONDITIONS DEMAND AND REPAIR AND/OR CLEANOUT OF ANY MESURES USED TO TRAP SEDIMENT. ALL SEDIMENT SPILLED, DROPPED, WASHED OR TRACKED ONTO PUBLIC RIGHT OF WAY MYST BE REMOVED IMMEDIATELY.

225 Miller Avenue, Mill Valley, CA 94941 T 415 383 7900 F 415 383 1433 www.rhaa.com PROJECT/CLIENT NAME **Dunphy Park** 200 Napa Street Sausalito, CA 94965

SCALE: NTS

16042A

RHAA PROJECT NUMBER

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Sausalito, CA 94965

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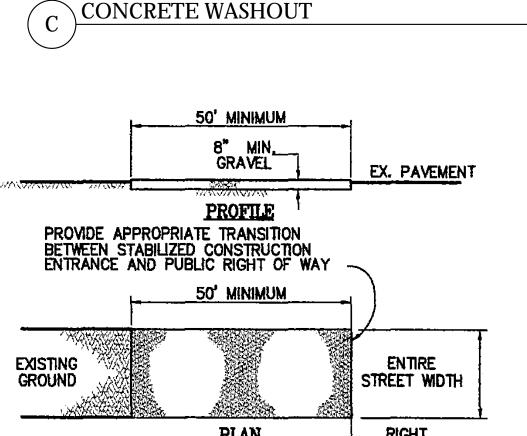
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SHEET TITLE **EROSION CONTROL DETAILS**

DRAWN BY: JG

CHECKED BY: MW



PLAN VIEW

CONSTRUCTION ENTRANCE

SCALE: N7



BioD-Rockbag™ Biodegradable coir rock bags

Completely Wildlife Safe!

Description

BioD-Rockbag, coir rock bags are made from BioD-Mat 90 woven coir mat which has a minimum weight of 980 g/ sq.m and 38% open area. These bags are strong, durable and completely wildlife safe. These coir rock bags filter sediment effectively and can stand heavy equipment better than synthetic rock bags. Each bags comes with coir twine string so that these bags can be joined together to perform as one unit. Coir rock bags are manufactured to conform to the following properties:

Specifications

Property	BioD-Rockbag TM					
Unit weight	29 oz/sy (980 g/m)					
Thickness	0.35 in (9 mm)					
Rock bag sizes	24 in x 10 in (60 cm x 25 cm) 24 in x 36 in (60 cm x 90 cm)					
Fabric	BioD-Mat 90 woven bristle coin blanket					
Strength of fabric Machine direction Cross direction	2024 lbs./ft. (29.6 kN/m) 1160 lbs/ft (17 kN/m)					



1 800 760 3215
Tel: 770 506 8211 Fax: 770 506 0391
E-mail: rolanka@rolanka.com
Web: www.rolanka.com

SBA's 8(a) & SDB and DOT DBE Certified

SCREW FILTER SCREEN TO

1"2"/WIN.) WOOD STAKES,
NUMBER & LENGTH OF
STAKES AS REQUIRED TO
FULLY STABILIZE SCREEN

FILTER HEICHT - 2"
UNDER-SEAL GASKET


NSTALL ½ FULL GRAVEL
BAGS (2) ONE ONE ON
EACH SIZE. ONE
ALTERNATIVELY CRIEC
GR-8 HOOKS # (2).

GRAVEL BAGS

SCALE: N

B DROP GUARD INSTALLATION

SCALE: NTS

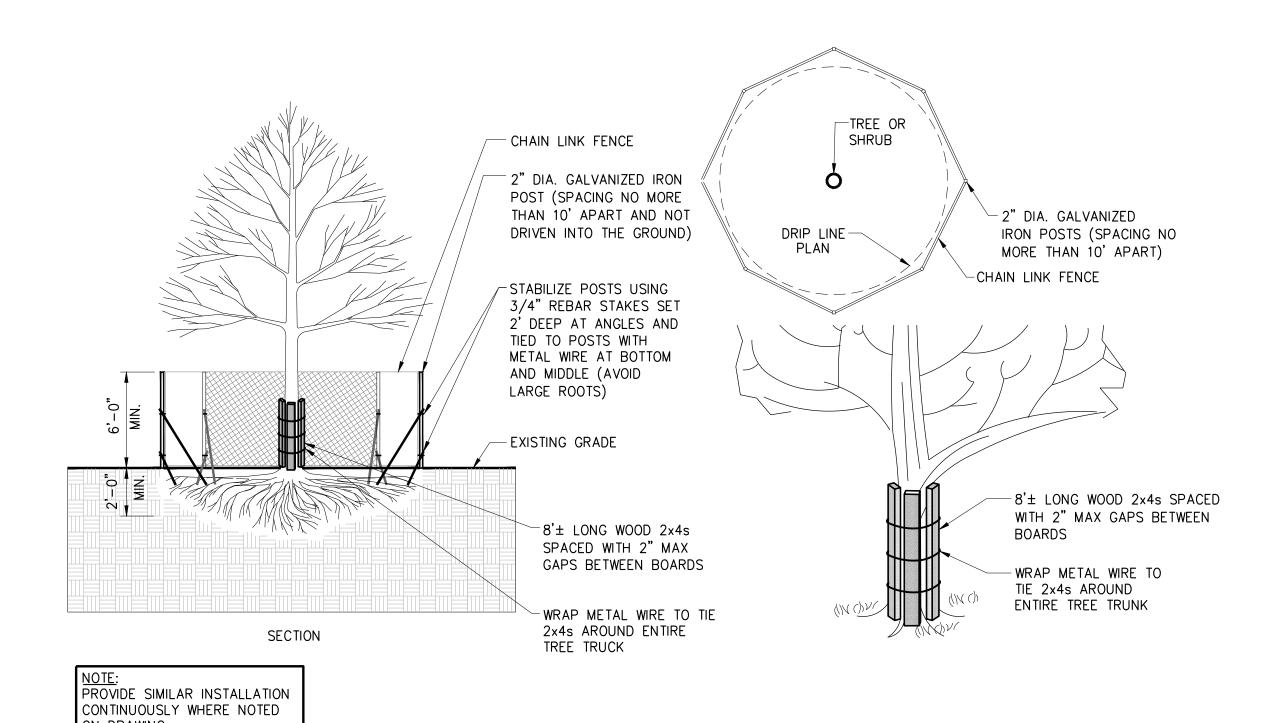

TREE PROTECTION FENCE

ON DRAWING

SCALE: NTS

LANDSCAPE ARCHITECTURE + PLANNING
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PROJECT/CLIENT NAME

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SHEET TITLE
EROSION CONTROL
DETAILS

DRAWN BY: JG

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C5.1



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engineering 350 Ilc

256 moulton street san francisco, ca 94123 T:415-328-1450 www.engineering350.com

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SCALE NONE


0 15' 3



SHEET TITLE
ELECTRICAL
LEGEND AND
NOTES

DRAWN BY: KZ

	DUNPHY PARK IMPROVEMENTS									
VOLTAGE DROP CALCULATION										
FEEDER	MAX. CURRENT (A)	SUPPLYING BREAKER RATING (A)	FEEDER SIZE (AWG/kCM)	LENGTH (FT) FROM MAIN SWITCHBOARD (approx)	IMPEDANCE (Z) (OHMS/KFT)	VOLTAGE DROP (V)	% VD (MAX. 3%)			
PNL. MAIN	52	100	# 1	10	0.1641	0.17	0.07			

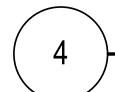

VOLTAGE DROP CALCULATION

SCALE: NONE

		LIGH	TING FIXTURE SCHEDUL	E							
TYPE	DESCRIPTION	MANUFACTUR ER	MODEL	LAMP(S)	DRIVER	DIMMING TYPE	VOLTS (V)	WATTS (W)	EFFICACY (LPW)	MOUNTING TYPE	LOCATION
F1	POLE LIGHTING, FLARED EDGE, BASE FIXTURE, FLAT GLASS LENS, 4500K, 6665 LUMENS, COORDINATE COLOR WITH ARCHITECT. SINGLE ARM MOUNTING CONFIGURATION. ELECTRONIC BUTTON PHOTOCONTROL	STERNBERG LIGHTING	1A-1970LED-F-BG-4ARC-45- T3R-MDL03-FG-PEC	LED	LED DRIVER	0-10	120	65 W each	102.6	POLE SINGLE ARM	TYPICAL
F2	POLE LIGHTING, FLARED EDGE, BASE FIXTURE, FLAT GLASS LENS, 4500K, 6665 LUMENS, COORDINATE COLOR WITH ARCHITECT. DOUBLE ARM MOUNTING CONFIGURATION. ELECTRONIC BUTTON PHOTOCONTROL	STERNBERG LIGHTING	2A-1970LED-F-BG-4ARC-45- T3R-MDL03-FG-PEC	LED	LED DRIVER	0-10	120	65 W each	102.6	POLE DOUBLE ARM	TYPICAL

LIGHTING GENERAL NOTES:

- 1. ALL LIGHTING FIXTURES SHALL BE SUPPLIED WITH THE MOUNTING ACCESSORIES, TRIMS AND/OR SHROUDS NECESSARY TO PROPERLY AND COMPLETELY INSTALL THE FIXTURES. CONTRACTOR SHALL VERIFY WITH ARCHITECT THE COLOR AND FINISH OF FIXTURES TO THE CLOSEST STANDARD COLOR AND FINISH BEFORE ORDERING.
- 2. COORDINATE LIGHTING CONTROLS AND PROVIDE AS REQUIRED BY MANUFACTURER TO ACHIEVE A COMPLETE WORKING SYSTEM.



LIGHTING FIXTURE SCHEDULE

SCALE: NONE

			WIRING SC	CHEDULE - (COPPER C	ONDUCTOR	RS (0-600V)			
CIRCUIT RATING			CON	DUIT SIZE ((INCHES)			CONDUC [*]	TOR SIZE	
	NONE	G	N	NG	NGI	NNG	NNGI	PHASE/ NEUTRAL	GND/* IG	
15	0.5	0.5	0.5	0.5	0.5	0.5	0.5	12	12]
20	0.5	0.5	0.5	0.5	0.5	0.5	0.5	12	12	
30	0.5	0.5	0.5	0.5	0.75	0.75	0.75	10	10] [
40	0.75	0.75	0.75	1	1	1	1	8	10	1 H
50	1	1	1	1.25	1.25	1.25	1.25	6	10	1
60	1	1.25	1.25	1.25	1.5	1.5	1.5	4	10	1
70	1	1.25	1.25	1.25	1.5	1.5	1.5	4	8]
80	1.25	1.25	1.25	1.5	2	2	2	2	8] [
90	1.25	1.25	1.25	1.5	2	2	2	2	8	
100	1.25	1.5	1.5	2	2	2	2.5	1	8] L
110	1.25	1.5	1.5	2	2	2	2.5	1	6	
125	1.25	1.5	1.5	2	2	2	2.5	1	6] [
150	1.5	2	2	2	2.5	2.5	2.5	1/0	6	1
175	1.5	2	2	2	2.5	2.5	2.5	2/0	6	1
200	2	2	2	2.5	2.5	2.5	3	3/0	6	1
225	2	2.5	2.5	2.5	3	3	3	4/0	4	
250	2.5	2.5	2.5	3	3	3	3.5	250	4	1
300	2.5	3	3	3.5	3.5	3.5	4	350	4	1
350	3	3.5	3.5	4	4	4	5	500	2	1 [
400	2@2	2@2	2@2	2@2.5	2@2.5	2@2.5	2@3	3/0	2]
450	2@2	2@2.5	2@2.5	2@2.5	2@3	2@3	2@3	4/0	2	1
500	2@2.5	2@2.5	2@2.5	2@3	2@3	2@3	2@3.5	250	1	1
600	2@2.5	2@3	2@3	2@3.5	2@3.5	2@3.5	2@4	350	1	1 [
700	2@3	2@3.5	2@3.5	2@4	2@4	2@4	2@5	500	1/0	1
800	3@2.5	3@3	3@3	3@3	3@3.5	3@3.5	3@3.5	300	1/0	1
1000	3@3	3@3	3@3	3@3.5	3@4	3@4	3@4	400	2/0	1
1200	4@2.5	4@3	4@3	4@3.5	4@3.5	4@3.5	4@4	350	3/0	
1600	5@3	5@3	5@3	5@3.5	5@4	5@4	5@4	400	4/0	1
2000	6@3.5	6@3.5	6@3.5	6@4	6@4	6@4	6@5	500	250	1
2500	7@3.5	7@3.5	7@3.5	7@4	7@4	7@4	7@4	500	350	
3000	8@3.5	8@3.5	8@3.5	8@4	8@4	8@4	8@4	500	400	1

	SUBSCRIPT KEY
SUBSCRIPT	CONDUCTORS PER CONDUIT
NONE	3 PHASE CONDUCTORS, CONDUIT GROUND
G	3 PHASE CONDUCTORS, 1 GROUNDING CONDUCTOR
N	3 PHASE CONDUCTORS, 1 NEUTRAL CONDUCTOR, CONDUIT GROUND
NG	3 PHASE CONDUCTORS, 1 NEUTRAL CONDUCTOR, 1 GROUNDING CONDUCTOR
NGI	3 PHASE CONDUCTORS, 1 NEUTRAL CONDUCTOR, 1 GROUNDING CONDUCTOR, 1 ISOLATED GROUNDING CONDUCTOR
NNG	3 PHASE CONDUCTORS, 2 NEUTRAL CONDUCTORS*, 1 GROUNDING CONDUCTOR
NNGI	3 PHASE CONDUCTORS, 2 NEUTRAL CONDUCTORS*, 1 GROUNDING CONDUCTOR, 1 ISOLATED GROUNDING CONDUCTOR

* SING	GLE NEUTRAL	CONDUCTOR	SIZES FOR CIF	RCUIT RATING	125 AND LESS	3
PARALLEL CONDUCTO ARE INDICATED, PRO FOLLOWING TABLE:						
CIRCUIT RATING	15	20	30	40	50	60
SINGLE NEUTRAL CONDUCTOR SIZE	10	8	4	2	1	1/0
CIRCUIT RATING	70	80	90	100	125	
SINGLE NEUTRAL CONDUCTOR SIZE	2/0	3/0	4/0	250	250	
		EΣ	KAMPLES			
SOURCE	225NG LOAI		CIRCUIT RAT		NG L SUB	SCRIPT
			NOTES			
OR EARTH,	AT AMBIENT	AIR TEMPERA	TURE OF 30°C	(86°F).	RACEWAY, CA	

AVAILABLE.

LIGI	HTING S	SEQUE	NCE OF	OPERA	NOITA			
ROOM TYPE / FUNCTION	OCCUPANCY SENSOR-AUTO ON	OCCUPANCY SENSOR-MANUAL OFF	OCCUPANCY SENSOR-AUTO OFF	OCCUPANCY SENSOR- PARTIAL ON/OFF	MANUAL ON/OFF SWITCH	DAYLIGHT SENSOR + AUTO DIMMING	MANUAL DIMMING	TIME CLOCK
RESTROOMS	•	•	•		•			
UTILITY ROOM					•			
EXTERIOR LIGHTING ATTACHED TO RESTROOM BUILDING					•	•		•
EXTERIOR LIGHTING - PARKING LOT LIGHTING FIXTURES						•		•
EXTERIOR LIGHTING - BOCCE COURT LIGHTING FIXTURES					•	•		•



LIGHTING SEQUENCE OF OPERATION

SCALE: NONE

NAN	ΛE:	R (ADD/ALT)*	VOLTAGE:	120/24	.0	BUS S	IZE:	50	0 A	MIN. AIC:		
MOU	NT:	SURFACE	PHASE/WIF	E: 1PH 3W		MAIN:		50A		SERVED FROM:	MA	IN
	BKR/ POLE	I DESCRIBITION	ФА	ΦВ	R	L/C	М	N	К	DESCRIPTION	BKR/ POLE	
1	20/1	RESTROOM LIGHTS	0 360		360					RESTROOM GFCI REC	20/1	2
3	20/1	RESTROOM EXT LIGHTS		0 360	360					RESTROOM GFCI REC	20/1	4
5	20/1	DOOR LOCK	0							RESTROOM EF	20/1	6
7	20/1	SPARE		0						RESTROOM EF	20/1	8
9	20/1	SPARE	0							SPARE	20/1	10
11		SPACE		0						SPACE		12
CON	NECTE	D LOAD SUBTOTALS	360	360	720	0	0	0	0		ļ	
CONN	NECTE	D LOAD (KVA)	0.	.7								
	CO	NNECTED LOAD (AMPS):	3.0	00						65% OF CONNECTED	0.0	KVA
		DEMAND LOAD (AMPS):	3.0	00						100% OF CONNECTED	0.0	KVA
									CON	NECTED + 25% LARGEST	0.0	KVA
		*= PROVIDED BY OTHERS	3							125% OF CONNECTED	0.0	KVA
									FIRST	10KVA + 50% REMAINDER	0.72	KVA
						Т	OTAL	CALCU	LATED	DEMAND LOAD PER NEC	0.7	KVA

NAN	ЛЕ:	MAIN	VOLTAGE:	120/2	40	BUS S	IZE:	10	0A	MIN. AIC:		
MOUI	NT:	EXTERIOR	PHASE/WIRI	E: 1PH 3W	ī	MAIN:		100A		SERVED FROM:	PG&	E TX
CKT NO.	BKR/ POLE	DESCRIPTION	ФА	ΦВ	R	L/C	М	N	к	DESCRIPTION	BKR/ POLE	
1	20/1	PARKING LIGHTS	650 4800		4800	650				047500 00050 000	50/0	2
3	20/1	BOCCE LIGHTS		520 4800	4800	520				- GAZEBO SPIDER BOX	50/2	4
5	20/1	IRRIGATION CTRL	0 180		180					GAZEBO REC	20/1	6
7	E0/0	PNL. R		360 180	720 180	0	0	0	0	GAZEBO REC	20/1	8
9	50/2	(RESTROOM ADD/ALT)	360 360		360					PICNIC REC	20/1	10
11	20/1	SPARE		0 180	180					BOCCE REC	20/1	12
13	20/1	SPARE	0							SPARE	20/1	14
15	20/1	SPARE	_	0						SPARE	20/1	16
17		SPACE	0							SPACE		18
19		SPACE	_	0						SPACE		20
CON	NECTE	D LOAD SUBTOTALS	6350	6040	11220	1170	0	0	0		•	
CON	NECTE	D LOAD (KVA)	12.	4								
	CO	NNECTED LOAD (AMPS):	51.6	33						65% OF CONNECTED	0.0	KVA
		DEMAND LOAD (AMPS):	50.3	30						100% OF CONNECTED	0.0	KVA
									CON	NECTED + 25% LARGES1	0.0	KVA
										125% OF CONNECTED	1.5	KVA
									FIRST	10KVA + 50% REMAINDER	R 10.61	KVA
						Т	OTAL	CALCU	LATE	DEMAND LOAD PER NEC	12.1	KVA

PANELBOARD SCHEDULES

SCALE: NONE

225 Miller Avenue, Mill Valley, CA 94941 T 415 383 7900 F 415 383 1433 www.rhaa.com

PROJECT/CLIENT NAME

Dunphy Park

200 Napa Street Sausalito, CA 94965

Owner: City of Sausalito 420 Litho St. Sausalito, CA 94965

RHAA PROJECT NUMBER

16042A

CONSULTANT

engineering 350 IIc 256 moulton street san francisco, ca 94123 T:415-328-1450

www.engineering350.com

SUBMITTAL

Permit Submittal

21 August 2017

REVISIONS

REGISTRATION AND SIGNATURE

SHEET TITLE **ELECTRICAL** SCHEDULES

DRAWN BY: KZ

Electrical Power Distribution	
CEC-NRCC-ELC-01-E (Revised 01/16)	CALIFORNIA ENERGY COMMISSION
CERTIFICATE OF COMPLIANCE	NRCC-ELC-01-
Electrical Power Distribution	(Page 1 of 6
Project Name: DUNPHY PARK IMPROVEMENTS	Date Prepared: 8/15/2017

General Information										
Project Address: 200 NAP	A STRE	ET. SAUSALITO, CA	Climate Zor	ie:	Conditioned Floor Area:					
		CZ3		Unconditioned Floor Area:						
Building Type:	Ø	Nonresidential		High-Rise Residential		Hotel/Motel				
		Schools		Relocatable Public School	5					
Phase of Construction:		New Construction		Addition	X	Alteration				

Document Number	Document Title / Descriptions (include description information for Table or Schedule if it contains compliance information)	Document Sheet # or Page #	Indicate which subsection of Section 130.5 is related to the document (e.g. 130.5(a) for service electrica metering)
ELECTRICAL DRAWINGS SET	ELECTRICAL CALCS & SCHEDULES	E0.2	130.5(c)
			÷

STATE OF CALIFORNIA

January 2016

Electrical Power Distribution	<u> Co</u>
CEC-NRCC-ELC-01-E (Revised 01/16)	CALIFORNIA ENERGY COMMISSION
CERTIFICATE OF COMPLIANCE	NRCC-ELC-01
Electrical Power Distribution	(Page 4 of
Project Name: DUNPHY PARK IMPROVEMENTS	Date Prepared: 8/15/2017

B. Separation of Electrical Circuits for Electrical Energy Monitoring
Check all boxes below if the electrical power distribution system is in compliance with Section

CA Building Energy Efficiency Standards - 2016 Nonresidential Compliance

on 130.5(b). The electrical power distribution system meets the separation of electrical circuits for electrical energy monitoring requirement of Section 130.5(b). The electrical power distribution systems is designed so that measurement devices can monitor the electrical energy usage of load Describe the electrical power distribution system installed and the compliance method chosen in meeting the requirement of Section

130.5(b). Use the space below to include the information. Examples of compliance methods are detailed in Nonresidential Compliance Manual Chapter 8.

Fill out Column 1 thru 3 with the compliance information.

General information	Electrical Power Distribution System information and Method of compliance	Electrical Service Rating	Enforcement Agency
01	02	03	04
Electrical Service Designation/Location/Descrip tion	Describe the electrical power distribution system installed and the compliance method used.	kVA	Check that the system complies
PNL. MAIN	PROPOSED DESIGN MEETS THE SEPARATION OF ELECTRICAL CIRCUIT REQUIREMENT OF SECTION 130.5(B). FOR SERVICES RATED 50 kVA OR LESS NO SEPARATION OF THE ELECTRICAL LOAD IS REQUIRED.	12.1 kVA	
Field Inspector Notes:		<u> </u>	

CA Building Energy Efficiency Standards - 2016 Nonresidential Compliance January 2016 STATE OF CALIFORNIA Electrical Power Distribution CALIFORNIA ENERGY COMMISSION CEC-NRCC-ELC-01-E (Revised 01/16) CERTIFICATE OF COMPLIANCE NRCC-ELC-01-E Electrical Power Distribution (Page 2 of 6) DUNPHY PARK IMPROVEMENTS 8/15/2017

Document Number	Document Title / Descriptions (include description information for Table or Schedule if it contains compliance information)	Document Sheet # or Page #	Applicable subsection of Section 130.5

STATE OF CALIFORNIA CALIFORNIA ENERGY COMMISSION Electrical Power Distribution CEC-NRCC-ELC-01-E (Revised 01/16)

CA Building Energy Efficiency Standards - 2016 Nonresidential Compliance

CA Building Energy Efficiency Standards - 2016 Nonresidential Compliance

CERTIFICATE OF COMPLIANCE

Electrical Power Distribution

DUNPHY PARK IMPROVEMENTS 8/15/2017 C. Voltage Drop **Enforcement Agency** Check all boxes below if the electrical power distribution system is in compliance with Section 130.5(c). Check that the system

complies 🛮 The electrical power distribution system meets the voltage drop requirement of Section 130.5(c). The maximum combined voltage drop on feeder conductors and branch circuit conductors to the farthest connected load or outlet, do not exceed 5%. 🛛 Voltage drop calculation documents showing compliance to Section 130.5(c) are submitted as part of the compliance document submittal.

D. Circuit Controls for 120-Volt Receptacles and Controlled Receptacles Check one or more boxes below for applicable requirements of Section 130.5(d) for the electrical power distribution system.	Field Inspector Cehck that the system complies
☐ The control is capable of automatically shutting OFF the controlled receptacles when the space is typically unoccupied, either at the receptacle or circuit level. For the automatic time switch control, it incorporates an override control that allows the controlled receptacle to remain ON for no more than 2 hours when an override is initiated and an automatic holiday "shut-OFF" feature that turns OFF all loads for at least 24 hours and then resumes the normally scheduled operation. Countdown timer switches are not be used to comply with the automatic time switch control requirements. The controls meet the requirement of Section 130.5(d)1.	
☐ There is at least one controlled receptacle within 6 ft from each uncontrolled receptacle. Where receptacles are installed in modular furniture in open office area, at least one controlled receptacle is installed at each workstation. The receptacles meet the requirement of Section 130.5(d)2.	
☐ There are installed split wired receptacles with at least one controlled and one uncontrolled receptacle. Where receptacles are installed in modular furniture in open office area, at least one controlled receptacle is installed at each workstation. The receptacles meet the requirement of Section 130.5(d)2.	п
☐ Permanent and durable marking for controlled receptacles or circuits to differentiate them from uncontrolled receptacles or circuits is provided. The markings meet the requirement of Section 130.5(d)3.	
☐ For hotel and motel guest rooms, there are controlled receptacles for at least one-half of the 120-volt receptacles in each guest room. Electric circuits serving controlled receptacles in guestrooms are installed to have captive key controls, occupancy sensing controls, or automatic controls so the power is switched off no longer than 30 minutes after the guest room has been vacated. The receptacles meet the requirement of Section 130.5(d)4.	п
□ Receptacles that are only for the following purposes are excepted from Section 130.5(d): -Receptacles specifically for refrigerators and water dispensers in kitchen areas. -Receptacles located a minimum of six ft above the floor that are specifically for clocks. -Receptacles for network copiers, fax machines, A/V and data equipment other than personal computers in copy rooms. -Receptacles on circuits rated more than 20 amperes. -Receptacles connected to an uninterruptible power supply (UPS) that are intended to be in continuous use, 24 hours per day/365 days per year, and are marked to differentiate them from other uncontrolled receptacles or circuits.	

STATE OF CALIFORNIA

Electrical Power Distribution	
CEC-NRCC-ELC-01-E (Revised 01/16)	CALIFORNIA ENERGY COMMISSION
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Electrical Power Distribution	(Page 3 of
Project Name: DUNPHY PARK IMPROVEMENTS	Date Prepared: 8/15/2017

A. Service Electrical Metering

Check one of the three boxes below if the electrical power distribution system is in compliance with Section 130.5(a).

☐ For newly installed electrical service in newly constructed buildings, Service Electrical Metering is required according to Section 130.5(a). Fill out ☐ For new or replacement electrical service equipment in existing buildings, Service Electrical Metering is required according to Section 141.0(b)2Pi.

Fill out Column 1 thru 6 of table below. 🛮 EXCEPTION to Electrical Service Metering: Service or feeder for which the utility company provides a metering system that indicates instantaneous kW demand and kWh for a utility-defined period. Fill out Column 1, 2 and 6 of table below with the compliance information.

Fill out a separate line for each electrical service that is connected to the building. If additional table space is needed for electrical service information, submit additional page with the information.

Electrical Service Schedule	Electrical Service Rating	rvice Metering Capabilities (check all that are present)			Exception to 130.5(a)	Field Inspector	
01	02	03	04	05	06	07	08
Electrical Service Designation/Location/Description	kVA	Instantaneous (at the time) kW	Historical peak (kW)	Tracking kWh for a user- definable period	kWh per rate period	Utility metering system	Check that the metering complies
PNL. MAIN / EXTERIOR	12.1 kVA	Ø		×		(23)	
		_					

CA Building Energy Efficiency Standards - 2016 Nonresidential Compliance

January 2016

NRCC-ELC-01-E

(Page 5 of 6)

January 2016

January 2016

January 2016

STATE OF CALIFORNIA **Electrical Power Distribution** CEC-NRCC-ELC-01-E (Revised 01/16) CERTIFICATE OF COMPLIANCE

NRCC-ELC-01-E (Page 6 of 6)

Electrical Power Distribution DUNPHY PARK IMPROVEMENTS 8/15/2017

DOCUMENTATION AUTHOR'S DECLARATION STATEMENT		
1. I certify that this Certificate of Compliance documentation	is accurate and complete.	_
Documentation Author Name: MARIA NAZAR NAIM	Documentation Author Signature:	
Company: ENGINEERING 350 LLC	Signature Date: 8/15/2017	
Address: 256 MOULTON STREET	CEA/ HERS Certification Identification (if applicable):	
City/State/Zip: SAN FRANCISCO, CA 94123	Phone: 415-354-0006	
RESPONSIBLE PERSON'S DECLARATION STATEMENT		

certify the following under penalty of perjury, under the laws of the State of California: The information provided on this Certificate of Compliance is true and correct. I am eligible under Division 3 of the Business and Professions Code to accept responsibility for the building design or system design identified on this Certificate of Compliance (responsible designer).

The energy features and performance specifications, materials, components, and manufactured devices for the building design or system design identified on this Certificate of Compliance conform to the requirements of Title 24, Part 1 and Part 6 of the California Code of

The building design features or system design features identified on this Certificate of Compliance are consistent with the information provided on other applicable compliance documents, worksheets, calculations, plans and specifications submitted to the enforcement agency for approval with this building permit application.

I will ensure that a completed signed copy of this Certificate of Compliance shall be made available with the building permit(s) issued for the building, and made available to the enforcement agency for all applicable inspections. I understand that a completed signed copy of this Certificate of Compliance is required to be included with the documentation the builder provides to the building owner at occupancy.

Responsible De	signer Name: DANIEL CASTRO	Responsible Designer Signature:
Company:	ENGINEERING 350 LLC	Date Signed: 8/15/2017
Address:	256 MOULTON STREET	License:
City/State/Zip:	SAN FRANCISCO, CA 94123	Phone: 415-354-0006

225 Miller Avenue, Mill Valley, CA 94941 T 415 383 7900 F 415 383 1433 www.rhaa.com

PROJECT/CLIENT NAME

200 Napa Street Sausalito, CA 94965

Dunphy Park

City of Sausalito 420 Litho St. Sausalito, CA 94965

RHAA PROJECT NUMBER

16042A

CONSULTANT

engineering 350 Ilc 256 moulton street san francisco, ca 94123 T:415-328-1450 www.engineering350.com

SUBMITTAL

Permit Submittal

21 August 2017

RE\	/ISI	ION

No.	Date	Description	

REGISTRATION AND SIGNATURE



SCA	LE	NONE	
^	15'		

SHEET TITLE TITLE 24 COMPLIANCE

DRAWN BY: KZ

CHECKED BY:

CA Building Energy Efficiency Standards - 2016 Nonresidential Compliance

C-NRCC-LTO-01-E (Revised 04/16) ERTIFICATE OF COMPLIANC	Y y ₁ ,		CAL	NRCC-LTO-
utdoor Lighting	· · ·			(Page 1
oject Name: DUNPHY PARK IMPRO	VEMENTS		Date Prepared	8/15/2017
. General Information				
roject Address: 200 NAPA ST	REET. SAUSALITO, CA 94965		M02509000	Illuminated Hardscape Area 2.5 sq.ft.
hase of Construction:	New Construction	Addition	Ø	Alteration
outdoor Lighting Zone (LZ)	■ LZ-1	LZ-2	☑ LZ-	3 L Z-4
have confirmed with the Al-	IJ which LZ applies to this site. For	default lighting zone d	esignations,	see Title 24 Part 6, §10-114
. Lighting Compliance Docu	ments (check box for each docum	ent included)		
	use of this and all Energy Efficiency Sta		ents. refer to	the Nonresidential Manual
ublished by the California Ener			,	
✓ NRCC-LTO-01-E	Certificate of Compliance			
NRCC-LTO-02-E	Outdoor Lighting Controls Ce	Micheller Methodologie and better the constitue		
NRCC-LTO-03-E	Outdoor Lighting Power Allo	service as the reconstitute of the service of the service of the	2004 B (2017)	
NRCC-LTO-04-E	Outdoor Lighting Existing Cor	nditions Certificate of Com	pliance	
Common of Allowed Code	da au Liebtica Dannas			Watte
. Sum Total ALL OV	VED Outdoor Lighting Wattage from	n NRCC-LTO-03-F nage	1	Watts
01 Alterations with	NO increase of connected lighting llowed wattage from NRCC-LTO-04	load may instead use th		3530.05
	Complies ONLY if Installe	Wild and the same that	ox 01)	
02 Sum Total INSTAL	LED Outdoor Lighting Wattage from			1170
Julii Total III Jira	LED Outdoor Lighting Wattage from	in whee the of t, page	3.	A414
). Declaration of Required I	nstallation Certificates			
	ion Certificates that will be submitted.	(Retain copies and verify	compliance d	ocuments are completed and
igned.)				·
NRCI-LTO-01-E - Must be sub	mitted for all buildings			Field Inspector
NRCI-LTO-02-E - Must be sub ystem (EMCS), to be recognize	mitted for a lighting control system, or d for compliance.	for an Energy Manageme	nt Control	Field Inspector
				- 14
. Declaration of Required C	하는 이 이 경기를 가장하는 것이 되었다. 그 가장 하는 것이 되었다면 하는 것이 없는 것이 없는 것이 없다.	94	own, a compa	C. 040 (200 (201))
	ertificates of Acceptance that will be s	ubmitted. (Retain copies a	nd verify com	pliance documents are complet
nd signed.) NRCA-LTO-02-A - Must be sub	omitted for outdoor lighting controls.			Field Inspector
. Schedule of Luminaires Ex	empt from the Outdoor Lighting I	Power Requirements in	§140.7	
01		. 02		
Name or Symbol	Description of ex	empt luminaire in accor	dance with	the exemptions
Building Energy Efficiency Star	ndards - 2016 Nonresidential Compliar	ICB		April
				- April

April 2016

EC-NRCC-LTO-01-E (Revised 04/16)		CALIFORNIA ENERGY COMMISS	
CERTIFICATE OF COMPLIANCE		NRCC	-LTO-01-E
Outdoor Lighting		(Pa	ge 2 of 4)
Project Name: DUNPHY PARK IMPROVEME	ENTS	Date Prepared: 8/15/2017	
G. Schedule of Luminaires Exemp	ot from the Cutoff Requirements in §	130.2(b)	7
01		02	
Name or Symbol	Description of exempt lu	minaire in accordance with the exemptions	
F1	OUTDOOR LUMINAIRE R	ATED FOR USE WITH LAMPS LESS THAN 150 W.	
F2	OUTDOOR LUMINAIRE R	ATED FOR USE WITH LAMPS LESS THAN 150 W.	
	at from the Outdoor Lighting Control	Requirements in §130.2(c)	
H. Schedule of Luminaires Exemp			
H. Schedule of Luminaires Exemp	or nom the outdoor righting control	02	
		02 minaire in accordance with the exemptions	
01		INT 925/V	
01		INT 925/V	

RTIFICATE OF	COMPLIANCE								NRC	C-LTO-		
tdoor Lightin	g								(F	age 3 c		
ct Name: DUNPH	Y PARK IMPROVEMENTS						Date Prepared: 8/15/2017					
I. Outdoor I	ighting Schedule and Field Inspection Energy (Checklist						1		.1:1		
	Luminaire Schedule		In	stalled Wa	tts		Location	Cutoff	100 AND	eld ector		
01	02	03	0		05	06	07	08	4———	9		
		6	How wat	tage was		40						
			deterr	nined		area	Primary Function area in					
Name or	Complete Luminaire Description	- a	#	to t	e of	Total Installed Watts in this area (03 x 05)	which these luminaires are	BUG Rating	Pass	Faii		
Item Tag		Watts per Luminaire	CEC Default from NA8	rding .0(c)	Number of Luminaires	l Insi ts in c 05)	installed (Outdoor Lighting Zone)		Δ.			
		Watts per Luminaire	CEC Defaul from NA8	According to §130.0(c)	Num	Total Inst: Watts in t (03 x 05)	(Odtaoor Eighting Zone)					
F1	POLE LIGHTING, FLARED EDGE, BASE FIXTURE,						SITE LIGHTING	UH:				
	FLAT GLASS LENS, 4500K, 6665 LUMENS. SINGLE						SITE EIGHTING	UL: FVH: BVH:	S. S. S. Maria			
	ARM MOUNTING CONFIGURATION.									0		
		65			6	390						
								FH:				
								BH:				
F2	POLE LIGHTING, FLARED EDGE, BASE FIXTURE,						SITE LIGHTING	UH:				
	FLAT GLASS LENS, 4500K, 6665 LUMENS. DOUBLE ARM MOUNTING CONFIGURATION.							UL: FVH:	-			
		130			6	780		BVH:	0	0		
								FH:	1			
								BH:	1			
								UH:				
								UL:				
						0		FVH:	0	0		
				0.401 6		, ,		BVH:	~			
								FH:				
	v		÷				Fataram tatal fall and fe	BH:				
		INICT	TALLED WA	TTC DAG	E TOTAL:	1170	Enter sum total of all pages (Su INSTALLED Outdoor lighting w		4.0	170		
		IIVS	ALLED WA	HISPAG	L TOTAL.	11/0	NRCC-LTO-01-E; Page 1	accage) ITILO	1.	1/0		

CA Building Energy Efficiency Standards - 2016 Nonresidential Compliance

STATE OF CALIFORNIA.
OUTDOOR LIGHTING CONTROLS

CA Building Energy Efficiency Standards - 2016 Nonresidential Compliance

CERTIFICATE OF COMPLIANCE

Outdoor Lighting Controls

NRCC-LTO-02-E

(Page 1 of 3)

Date Prepared: 8/15/2017

-NRCC-LTO-01-E (Revised 04/16)	CALIFORNIA ENERGY COMMISSION
RTIFICATE OF COMPLIANCE	NRCC-LTO-03
tdoor Lighting	(Page 4 of
ct Name DUNPHY PARK IMPROVEMENTS	Date Prepared: 8/15/2017
DOCUMENTATION AUTHORIS DESI ADATION STATEMENT	
DOCUMENTATION AUTHOR'S DECLARATION STATEMENT 1. I certify that this Certificate of Compliance documentation is	accurate and complete
Documentation Author Name: MARIA NAZAR NAIM	Documentation Author Signature:
Company: ENGINEERING 350 LLC	Signature Date: 8/15/2017
Address: 256 MOULTON ST	CEA Certification Identification (if applicable):
City/State/Zip: SAN FRANCISCO, CA 94123	Phone: 415-354-0006
RESPONSIBLE PERSON'S DECLARATION STATEMENT	
 (responsible designer). The energy features and performance specifications, material Compliance conform to the requirements of Title 24, Part 1 and 4. The building design features or system design features ident documents, worksheets, calculations, plans and specifications. I will ensure that a completed signed copy of this Certificate enforcement agency for all applicable inspections. I understable builder provides to the building owner at occupancy. 	s Code to accept responsibility for the building design or system design identified on this Certificate of Compliance als, components, and manufactured devices for the building design or system design identified on this Certificate of and Part 6 of the California Code of Regulations. tified on this Certificate of Compliance are consistent with the information provided on other applicable compliance as submitted to the enforcement agency for approval with this building permit application. of Compliance shall be made available with the building permit(s) issued for the building, and made available to the and that a completed signed copy of this Certificate of Compliance is required to be included with the documentation the
Responsible Designer Name: DANIEL CASTRO	Responsible Designer Signature:
Company ENGINEERING 350 LLC	Date Signed: 8/15/2017
Address: 256 MOULTON ST	License: E21019
City/State/Zip: SAN FRANCISCO, CA 94123	Phone: 415-354-0006

Che	eck all that apply:
1	Lighting shall be controlled by self-contained lighting control devices which are certified to the Energy Commission according to the Title 20 Appliance Efficiency Regulations in accordance with §110.9(a).
V	Lighting shall be controlled by a lighting control system or energy management control system in accordance with §110.9. An Installation Certificate shall be submitted in accordance with §130.4(b).
V	All lighting controls and equipment shall comply with the applicable requirements in §110.9 and shall be installed in accordance with the manufacturer's instructions in accordance with §130.0(d).
	Part-Night Outdoor Lighting Controls, as defined in Section 100.1(b), shall meet the requirements in Section 110.9(b)5.
髓	All outdoor incandescent luminaires rated over 100 watts, determined in accordance with Section 130.0(c), shall be controlled by a motion sensor.
	All outdoor luminaires rated for use with lamps greater than 150 lamp watts, determined in accordance with Section 130.0(c), shall comply with Uplight and Glare requirements in accordance with Section 130.2(b)
V	All installed outdoor lighting shall be controlled by a photocontrol or outdoor astronomical time-switch control, or other control capable of automatically switching OFF in accordance with Section 130.2(c)1.
V	All installed outdoor lighting shall be circuited and independently controlled from other electrical loads by an automatic scheduling control in accordance with Section 130.2(c)2.
V	All installed outdoor lighting, where the bottom of the luminaire is mounted 24 feet or less above the ground, shall be controlled with automatic lighting controls in accordance with Section 130.2(c)3.
	For Outdoor Sales Frontage, an automatic lighting control shall be installed in accordance with Section 130.2(c)4.
	For Building Facade, Ornamental Hardscape and Outdoor Dining lighting, an automatic lighting control shall be installed in accordance with Section 130.2(c)5
V	Before an occupancy permit is granted for the newly constructed building or for the addition, or for any altered outdoor lighting controls,

shall be certified as meeting the Acceptance Requirements for Code Compliance in accordance with §130.4.(a). Outdoor lighting controls shall comply with the

CA Building Energy Efficiency Standards - 2016 Nonresidential Compliance

CERTIFICATE OF COMPLIANCE

roject Name: DUNPHY PARK IMPROVEMENTS

A. Mandatory Outdoor Lighting Control Declaration Statements

applicable requirements of Section 130.2(c) and Reference Nonresidential Appendix NA7.8.

Outdoor Lighting Controls

B. Mandatory Outdoor Ligh	nting Control Schedule and Field Inspection	on Check	list								
Outd	Outdoor Lighting Control Schedule					omplying /, or leave mpted)			✓ if Acceptance Test Required		Field Inspector
01	02	03	04	05	06	07	08	09	10	3	11
Location and Application of Luminaires Being Controlled	Type/ Description of Lighting Control (i.e. outdoor motion sensor, outdoor photocontrol, outdoor astronomical timeswitch control, automatic scheduling control, part-night outdoor lighting control)	# of Units	§130.2(a)	§130.2(c)1	§130.2(c)2	§130.2(c)3	§130.2(c)4	§130.2(c)5		Pass	Fail
ITE LIGHTING	OUTDOOR PHOTOCONTROL, TIME CONTROL	1		•	•	•	I I	184		0	0
										0	0
										0	0
										0	0
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LANDSCAPE ARCHITECTURE + PLANNING
225 Miller Avenue, Mill Valley, CA 94941
T 415 383 7900 F 415 383 1433 www.rhaa.com

PROJECT/CLIENT NAME

Dunphy Park

200 Napa Street Sausalito, CA 94965

Owner:
City of Sausalito
420 Litho St.
Sausalito, CA 94965

RHAA PROJECT NUMBER

16042A

CONSULTANT

engineering 350 llc engineering 350 llc 256 moulton street san francisco, ca 94123 T:415-328-1450

www.engineering350.com

SUBMITTAL

Permit Submittal

DATE 21 August 2017

REVISIONS

110.	Date	Description	

REGISTRATION AND SIGNATURE

NRCC-LTO-02-E

(Page 2 of 3)

August 201



CALE	NONE		_
15	' 30'	60'	

SHEET TITLE
TITLE 24

DRAWN BY: KZ

COMPLIANCE

CHECKED BY:

CA Building Energy Efficiency Standards - 2016 Nonresidential Compliance

STATE OF CALIFORNIA
OUTDOOR LIGHTING

CA Building Energy Efficiency Standards - 2016 Nonresidential Compliance

August 2016

Certify the following u The information process.	Carlo Miles Carlo				nia:				
2. I am eligible under	Division 3 of the				sponsibility for the building desig	gn or system des	ign identified o	on this Certificate o	of Compliance
(responsible design 3. The energy feature		ce specifications.	materials, co	omnonents, ar	nd manufactured devices for the	huilding design	or system desi	n identified on th	is Certificate of
Compliance confo	rm to the requirer	ments of Title 24	Part 1 and P	art 6 of the Ca	lifornia Code of Regulations.	5. (29)	87		
					cate of Compliance are consisten enforcement agency for approv				ble compliance
5. I will ensure that a	completed signe	d copy of this Cer	rtificate of Co	mpliance shal	I be made available with the buil	ding permit(s) is	ssued for the b	uilding, and made	
huilder provides to	the building own			nat a complete	ed signed copy of this Certificate	of Compliance i	s required to b	e included with the	e documentation the
Responsible Designer Name:	DANIEL CASTRO	ier at occupancy	*	Responsible	Designer Signature:	wil Tark			
Company : ENGINEERING				Date Signed:	8/15/2017	Nuc C	6000		
Address: 256 MOULTON S	the and the first factors			License: E21	019				
City/State/Zip: SAN FRANC				Phone	-354-0006				
TATE OF CALIFORNIA DUTDOOR LIGH EC-NRCC-LTO-03-E (Revis	ed 01/16)	ER ALLOW	/ANCES					CALIFORNIA ENE	RGY COMMISSION
CERTIFICATE OF COM	SELECTED DATES OF SELECT								NRCC-LTO-03-E
Outdoor Lighting Pow Project Name: DUNIDHY BAR		100				Da	to Propagation to a to	086577.0	(Page 3 of 4)
DUNPHY PAR	K IMPROVEMENT	'S					te Prepared: 8/15/2	2017	
2 WATTAGE ALL	OWANCE DE	D SOLIARE E	OOT OF H	Λ DDSC Δ DI	AREA (Ornamental Ligh	sting) – Tahl	140 7-B		
					ing for this allowance shall be			as determined in	accordance with
				and sample and the	naires, or chandeliers.	rated for 100	water or ress	as acterminea in	decordance with
If more than one lur	minaire type is u	sed per locatio	n, use multi	ple rows for	that location				
01	02	03	04	05	06	07	08	09	10
	AL	LOTTED WATTS	Allessed	1	DESIG	N WATTS		Ť	
Name of area for which rnamental allowance is	Square Feet of	Wattage Allowance per	Allotted Watts	Luminaire Code or		Luminaire	Watts per	Design Watts	Allowed Watts
claimed	Hardscape	Square Foot	(02 x 03)	Symbol	Luminaire Description	Quantity	Luminaire	(07 x 08)	(smaller of 04 or 09)
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					Sum tot	at allowance for	ornamentaring	nting on the site	0
- Allowances for Bui	ilding Facades; (Outdoor Sales L	ots; Vehicle	Service Stati	AREA - Table 140.7-B on Hardscape; Vehicle Service				s Canopies; Tunnels;
Guard Stations; Stud - If more than one l					curity Lighting for Retail Parki or that location	ng and Pedesti	rian Hardscap	e.	

NRCC-LTO-02-E

Date Prepared: 8/15/2017

07 08 09

uminaire Watts per Design Watts

January 2016

(Page 3 of 3)

STATE OF CALIFORNIA
OUTDOOR LIGHTING CONTROLS

Project Name: DUNPHY PARK IMPROVEMENTS

DOCUMENTATION AUTHOR'S DECLARATION STATEMENT

I certify that this Certificate of Compliance documentation is accurate and complete.

 Documentation Author Signature:

| Documentation Author Signature: | Documentation Author Signature: | Documentati

Signature Date: 8/15/2017

one: 415-354-0006

A Certification Identification (if applicable):

CERTIFICATE OF COMPLIANCE

engineering 350 LLC

256 MOULTON ST

City/State/Zip: SAN FRANCISCO, CA 94123

RESPONSIBLE PERSON'S DECLARATION STATEMENT

Outdoor Lighting Controls

Outdoor Lighting Power Al	NCE							RGY COMMISSION NRCC-LTO-03
	lowances							(Page 1 of
roject Name: DUNPHY PARK IMP	ROVEMENTS					Date Prepared:	3/15/2017	
A. OUTDOOR LIGHTIN	IG POWER ALLO	WANCE SUM	IMARY					
. General Hardscape Lighting				()		77 × 00-	1.	3530.05
Additional Specific "use it of letermined in Section C-1 to			sted in each of these cells	shall be identical	to total allov	ved watts		
etermined in Section C-1 to	C-4 01 NRCC-L10-03-E	ia.						
PER APPLICATION	PER UN	NIT LENGTH	PER HARDS	APE AREA	PEF	R SPECIFIC AREA		
from Section C-1	(SALES	FRONTAGE)	(ORNAMENTA	L LIGHTING)	fro	om Section C-4.		
	WASTE AND	Section C-2	from Sec			-	10	
0 . Sum Total ALLOWED Outd	+ loor Lighting Wattage	0 (add rows 1 and 3	+ 0		+	0	= 2.	0 3530.05
. Sum Total ALLOWED Outo	oor Lighting Wattage	(add 10ws 1 and 2	-1				٠,٠	5330.03
GENERAL HARDSCA	PE LIGHTING PO	WER ALLOW	ANCE FROM TABL	E 140.7-A				
			111021110111111111			es arthuryev	Initial Wattage	Total General Hardso
Are	ea Wattage Allowance	(AWA)	. 10	Linear Watta	age Allowanc	e (LWA)	Allowance (IWA)	Lighting Allowance
01	02	03	04	05	06	07	08	09
The state of the s	Illuminated	AWA Per	Perin	neter Length of	LPA per	LWA	IWA	2004 - 2007 - 2007
Name of Area	Hardscape Area	Square Foot	AWA (802 x 803)	[경기 및 10년 12년 12년 1일 전 12년 1일 - 12년 1일 - 12년 1월 1일 -	Linear Foot	(B05 x B06)	(Watts)	B04 + B07 + B08
SITE LIGHTING	61522.5	0.040	2460.9	1569	0.35	549.15	520	3530.05
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Building Energy Efficiency S	tandards - 2016 Nonre	esidential Complia	ance					January
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UTDOOR LIGHTIN C-NRCC-LTO-03-E (Revised 01/ ERTIFICATE OF COMPLIAI Jutdoor Lighting Power Al	16) NCE Ilowances	LOWANCE	s			Date Prepared:		NRCC-LTO-0
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UTDOOR LIGHTIN C-NRCC-LTO-03-E (Revised 01/ ERTIFICATE OF COMPLIAL Dutdoor Lighting Power Al Project Name: DUNPHY PARK I DOCUMENTATION AUTHOR 1. I certify that this Certifi Documentation Author Name: MAI Company: ENGINEERING 350 L Address: 256 MOULTON ST	NCE Illowances MPROVEMENTS R'S DECLARATION STA icate of Compliance do RIA NAZAR NAIM	NTEMENT		Signature Date:	8/15/2017 in Identification (e: Nug	8/15/2017	NRCC-LTO-0
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CERTIFICATE OF COM	MPLIANCE								NRCC-LTO-03
Outdoor Lighting Po	wer Allowances								(Page 2 of
Project Name: DUNPHY PAR	RK IMPROVEMENT	'S				Date Prepar	ed: 8/15/2017		
•						11.12	11 17		
C. ADDITIONAL "U	JSE IT OR LOS	E IT" OUTDO	OR LIGHTI	NG POWER	ALLOWANCES FOR SPECIF	IC APPLICAT	TIONS		
☐ The additional spe	cific outdoor ligh	iting power allow	vance shall b	e the smaller o	of the allowed lighting power or	the actual ligh	ting power us	ed.	
☐ Use Outdoor Lighti	ing Zone (OLZ) tl	nat is document	ed on page 1	of NRCC-LTO-	01-E to calculate the specific wa	ttage allowand	ces.		
•	,				•	•			
				7-2-2-2-2					
C-1. WATTAGE AL	LOWANCE PE	R APPLICATION	DN – Table	140.7-B					
□ Available only for	qualifying locati	ons, which inclu	de Building E	ntrances or Ex	its; Primary Entrances to Senior	Care Facilities	, Police Station	ns, Hospitals, Fire	Stations, and
Emergency Vehicle	e Facilities; Drive	Up Windows; V	ehicle Servic	e Station Unco	vered Fuel Dispenser, ATM Mad	hine Lighting			
☐ If more than one I	uminaire type is	used per location	n, use multi	ple rows for th	at location				
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Name of Location	Number of	Allowance per	Allotted	Luminaire					Allowed Wa
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is Claimed	Locations	Location	(02 x 03)	Symbol	Luminaire Description	Quantity	Luminaire	(07 × 08)	09)
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								,	
C-2 WATTAGE AL	I OWANCE DE	R LINIT LENG	zalc2) HT	Frontage) fr	om Table 140.7-B				
☐ If more than one I	uminaire type is	used per locatio	n, use muiti	pie rows for th	at location		9:	·	,
01	02	03	04	05	06	07	08	09	10
	3	ALLOTTED WATTS			DESIGN	WATTS	0.4	#/	
Name of Location		Wattage	Allotted	Luminaire					Allowed Wat
for Which Allowance	Linear Feet of	Allowance per	Watts	Code or		Luminaire	Watts per	Design Watts	(smaller of 04
is Claimed	Sales Frontage	Linear Foot	(02 x 03)	Symbol	Luminaire Description	Quantity	Luminaire	(07 x 08)	09)
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						um total allowa	nce for cales fro	ntage on the site:.	0

CA Building Energy Efficiency Standards - 2016 Nonresidential Compliance

225 Miller Avenue, Mill Valley, CA 94941 T 415 383 7900 F 415 383 1433 www.rhaa.com

PROJECT/CLIENT NAME

Dunphy Park

200 Napa Street Sausalito, CA 94965

Owner: City of Sausalito 420 Litho St. Sausalito, CA 94965

RHAA PROJECT NUMBER

16042A

CONSULTANT

engineering 350 Ilc 256 moulton street san francisco, ca 94123 T:415-328-1450

www.engineering350.com

SUBMITTAL

Permit Submittal

DATE 21 August 2017

REVISIONS

January 2016

No.	Date	Description	

REGISTRATION AND SIGNATURE



CALE	NONE	
	F	

SHEET TITLE TITLE 24

DRAWN BY: KZ

COMPLIANCE

CHECKED BY:

CA Building Energy Efficiency Standards - 2016 Nonresidential Compliance January 2016

ENGINEERING 350 LLC

^{/Zip:} SAN FRANCISCO, CA 94123

256 MOULTON ST

Date Signed: 8/15/2017


415-354-0006

E21019

for Which Allowance

of Application Square Foot (02 x 03) Symbol

CA Building Energy Efficiency Standards - 2016 Nonresidential Compliance

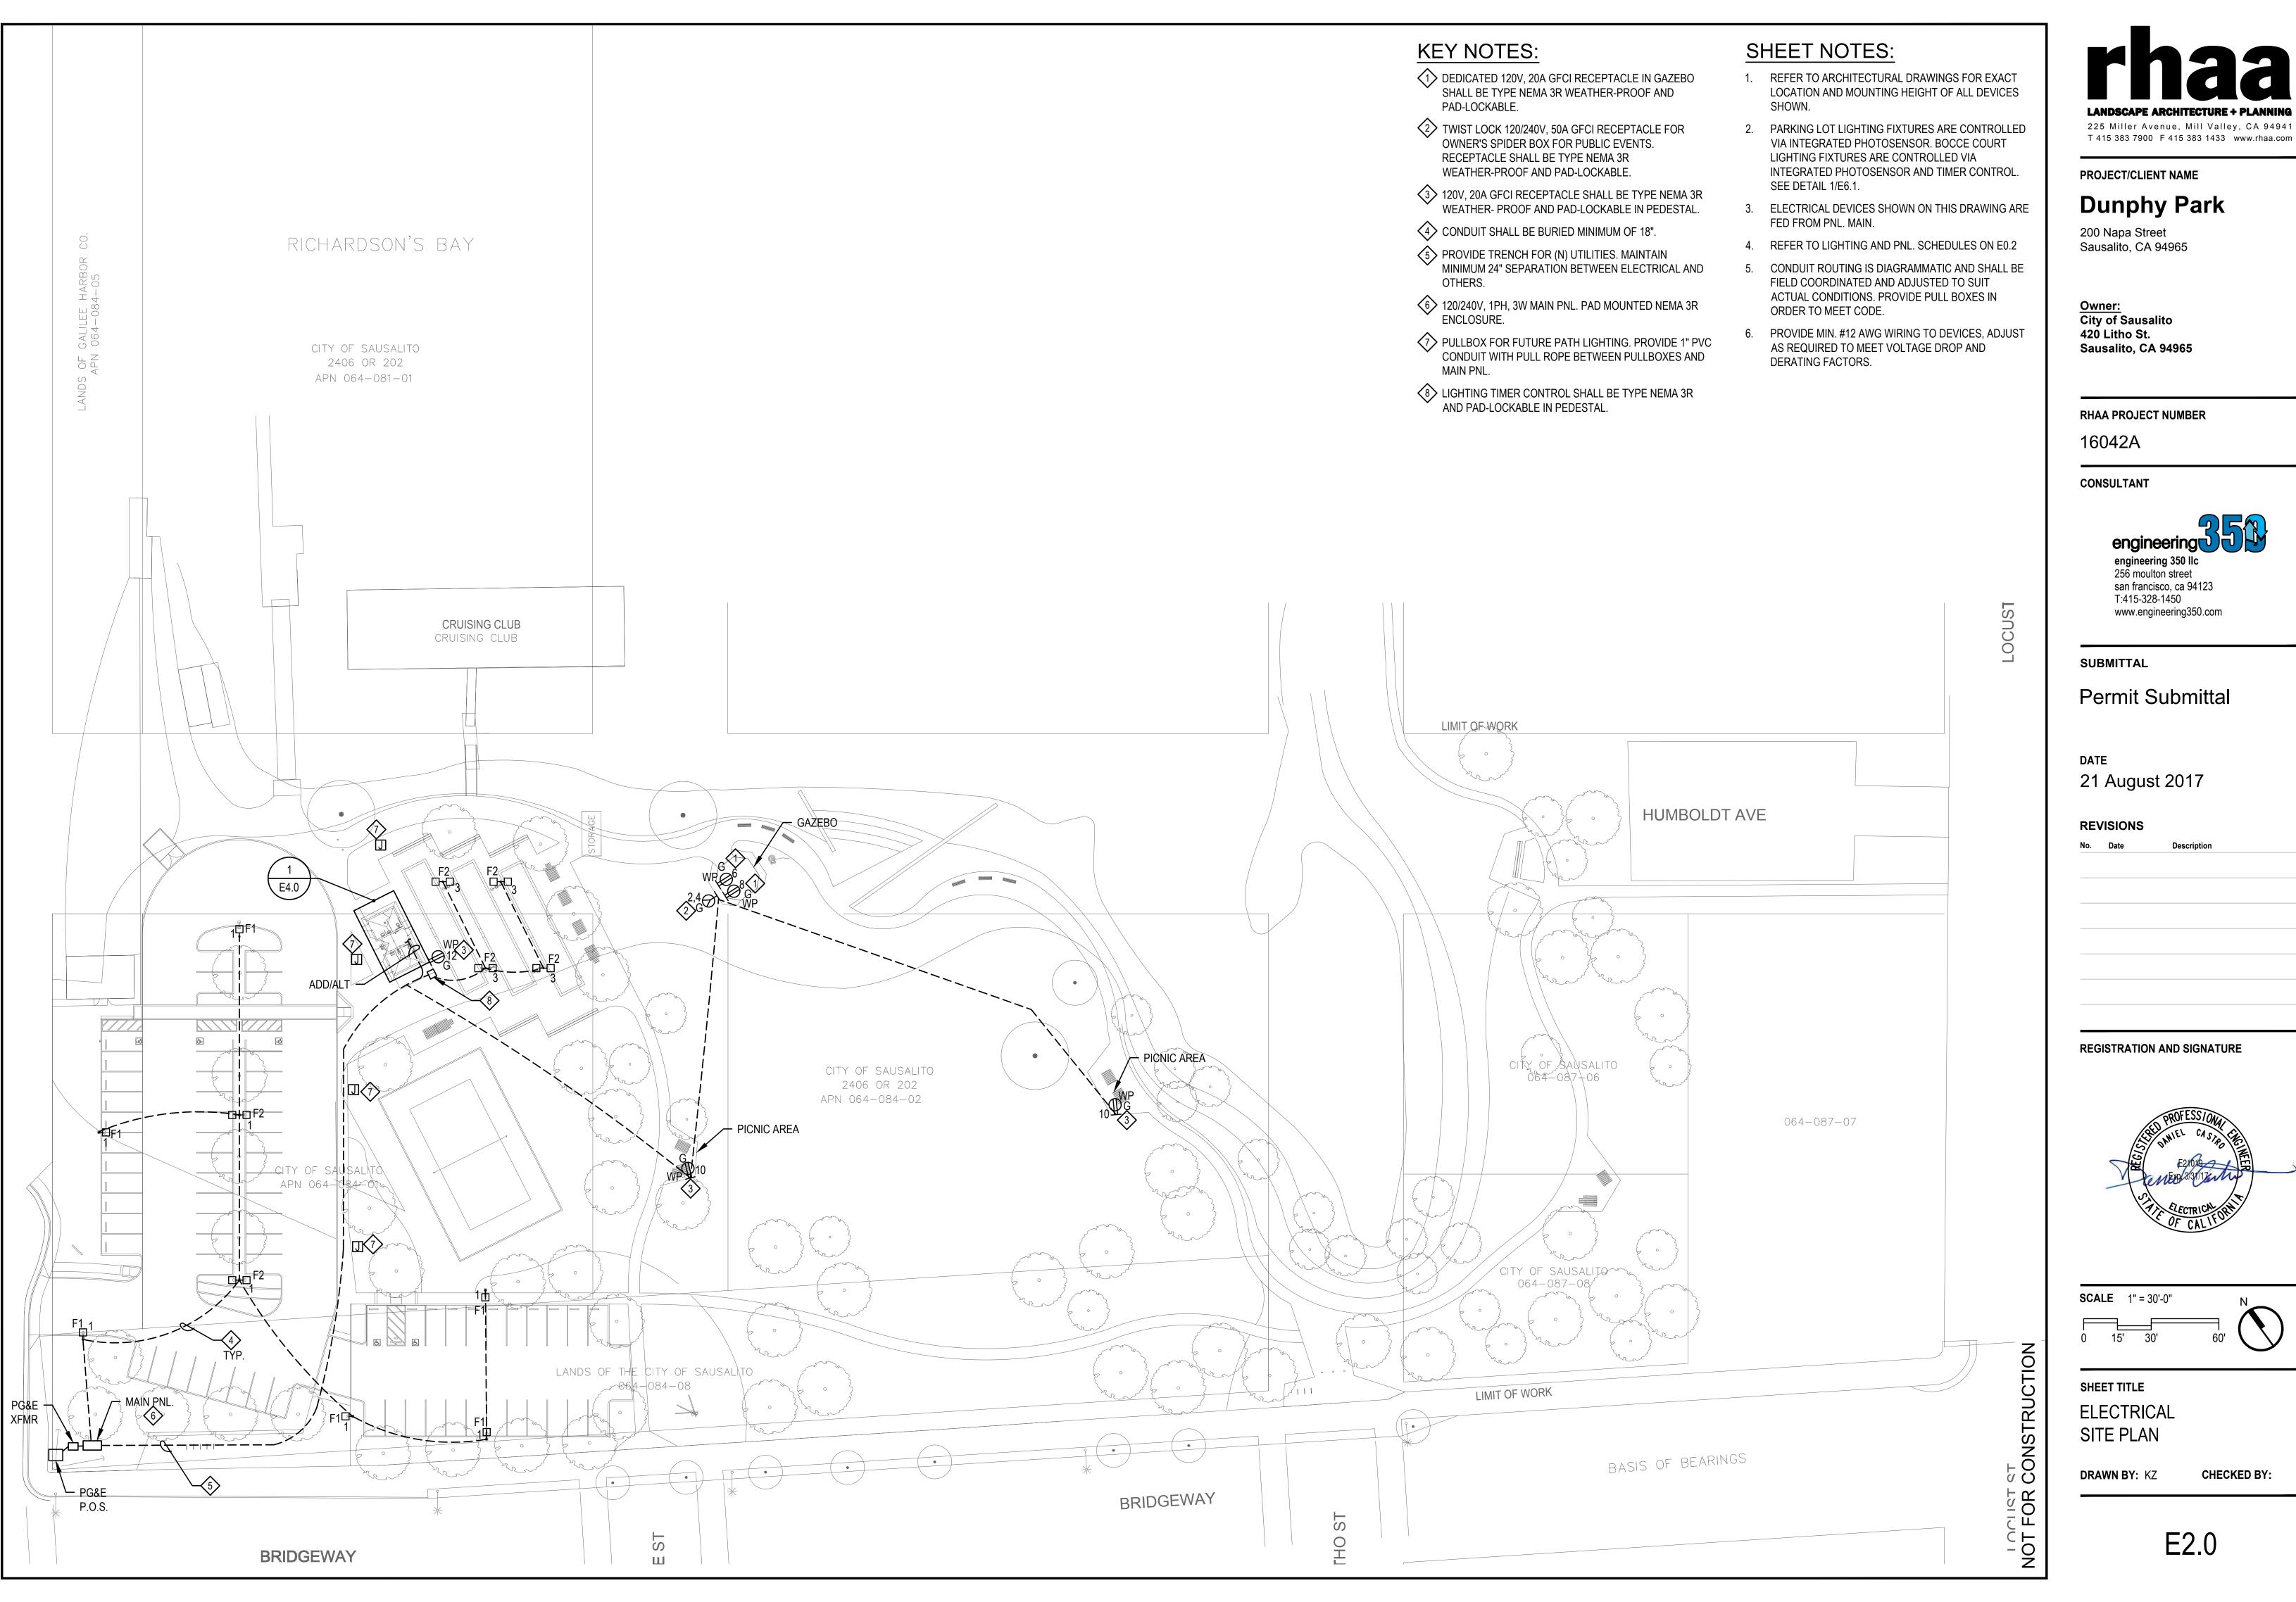



225 Miller Avenue, Mill Valley, CA 94941

PROJECT/CLIENT NAME

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200 Napa Street Sausalito, CA 94965

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SUBMITTAL

Permit Submittal


DATE


REVISIONS

REGISTRATION AND SIGNATURE



SCALE 1" = 30'-0"

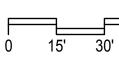

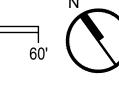

SHEET TITLE **ELECTRICAL** SITE PLAN


DRAWN BY: KZ

CHECKED BY:

E2.0

SHEET NOTES:

- 1. REFER TO RESTROOM MANUFACTURER DRAWINGS FOR TYPE, EXACT LOCATION AND MOUNTING HEIGHT OF DEVICES SHOWN.
- PROVIDED BY RESTROOM MANUFACTURER. CONTRACTOR SHALL PROVIDE WIRING AND CONDUIT FROM PNL. TO DEVICES.
- 3. ELECTRICAL DEVICES SHOWN ON THIS DRAWING ARE FED FROM PNL. R LOCATED IN RESTROOM UTILITY ROOM.
- 4. REFER TO E0.2 FOR PNL. SCHEDULE.
- 5. EXTENSION OF CIRCUIT FROM PNL. MAIN TO PNL. R FOR RESTROOM BUILDING SHALL BE PROVIDED BY CONTRACTOR. COORDINATE LOCATION OF LOADS WITH RESTROOM MANUFACTURER.

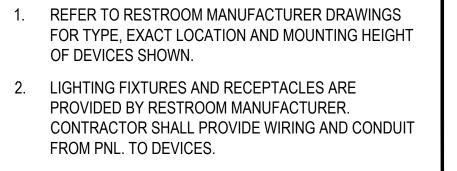



Dunphy Park

200 Napa Street

Sausalito, CA 94965

Owner: City of Sausalito 420 Litho St. Sausalito, CA 94965

RHAA PROJECT NUMBER

16042A

CONSULTANT

engineering 350 IIc 256 moulton street san francisco, ca 94123 T:415-328-1450 www.engineering350.com


SUBMITTAL

Permit Submittal

DATE 21 August 2017


REVISIONS

REGISTRATION AND SIGNATURE

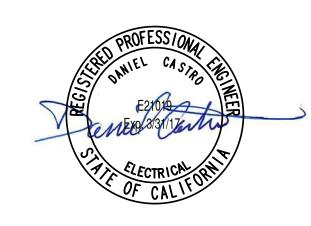

SCALE 1/4" = 1'-0"


DRAWN BY: KZ

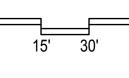

SHEET TITLE ELECTRICAL RESTROOM PLAN (ADD/ALT)

CHECKED BY:

E4.0

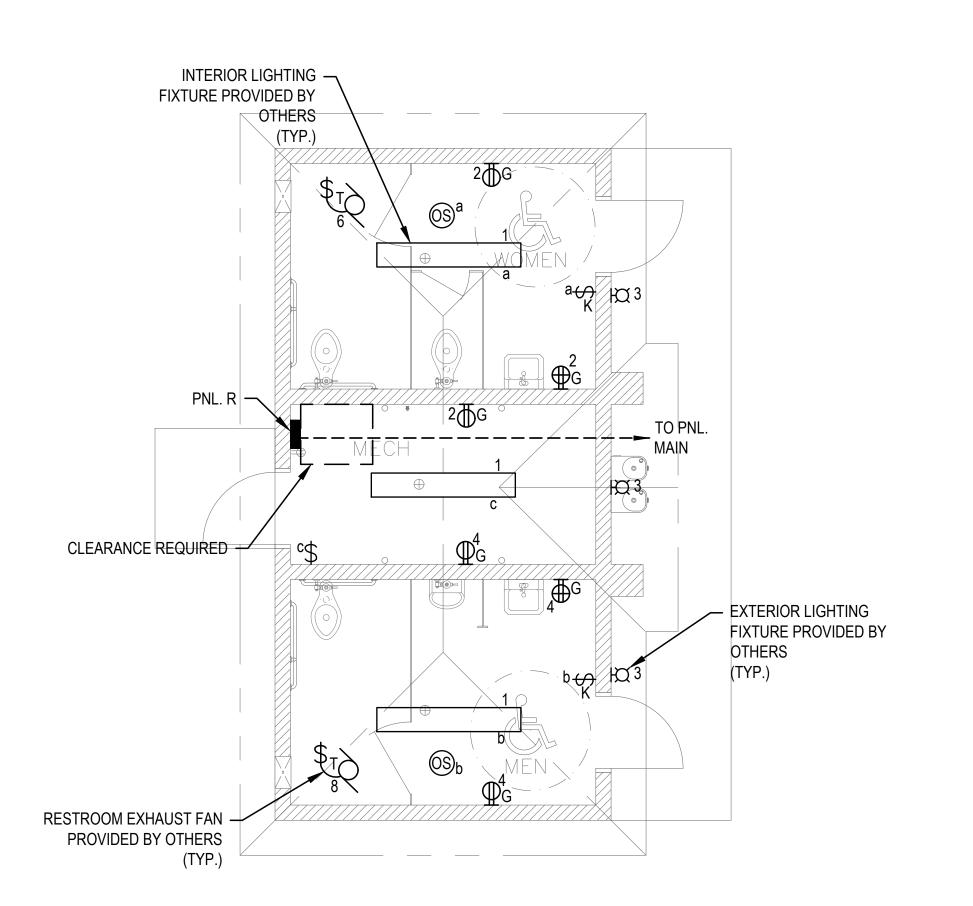

SHEET NOTES:

- REFER TO SHEET E0.2 EQUIPMENT CONNECTION SCHEDULE FOR WIRING SCHEDULE.
- 2. PROVIDE CONCRETE ENCASED GROUNDING ELECTRODE CONDUCTOR IN ACCORDANCE WITH CEC TABLE 250.66. PROVIDE 1/0 KCMIL COPPER ELECTRODE CONDUCTOR. PROVIDE A SEPARATELY DERIVED BONDING JUMPER FROM BUILDING STEEL AND UNDERGROUND WATER PIPES.



PROJECT/CLIENT NAME

Dunphy Park

200 Napa Street Sausalito, CA 94965

Owner:
City of Sausalito
420 Litho St.
Sausalito, CA 94965

RHAA PROJECT NUMBER

16042A

CONSULTANT

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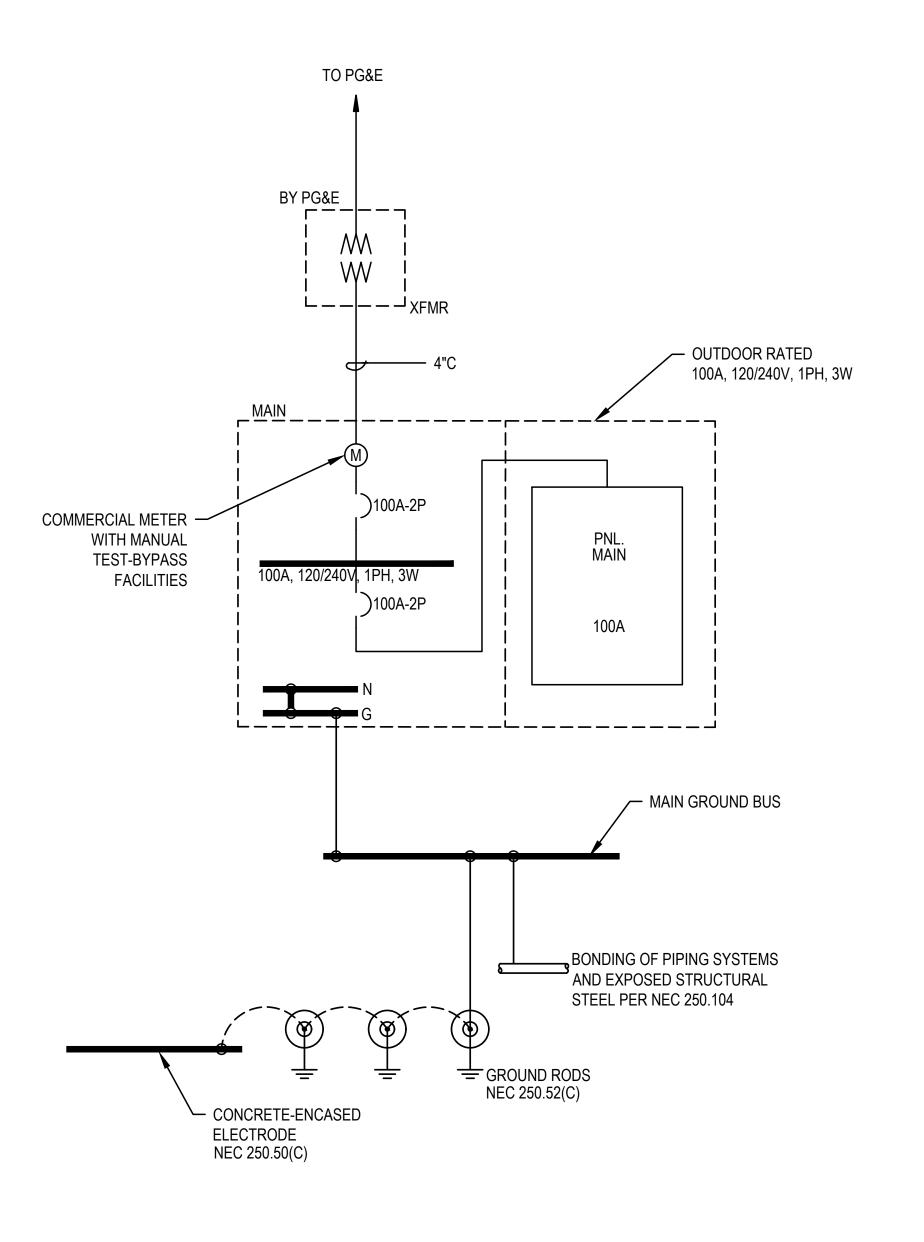
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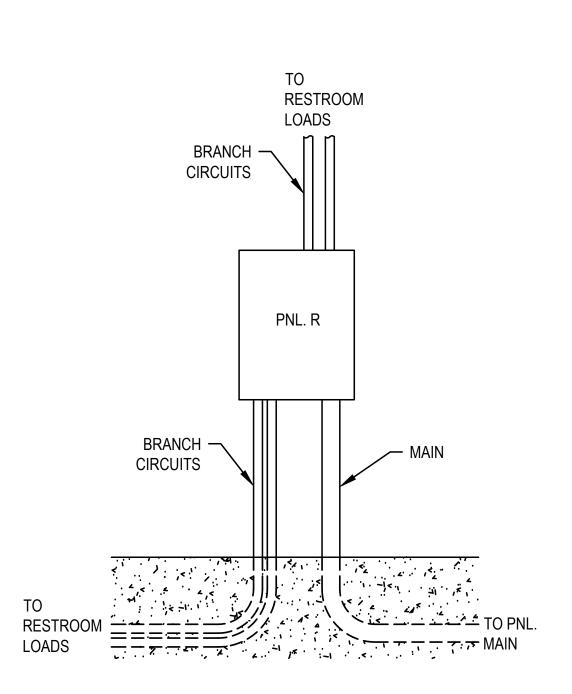
0 15' 30

0' 60'

SHEET TITLE
ELECTRICAL
DIAGRAMS

DRAWN BY: KZ





SCALE: NONE

RESTROOM PANELBOARD DETAIL (ADD/ALT)

225 Miller Avenue, Mill Valley, CA 94941 T 415 383 7900 F 415 383 1433 www.rhaa.com

PROJECT/CLIENT NAME

Dunphy Park

200 Napa Street Sausalito, CA 94965

Owner: City of Sausalito 420 Litho St. Sausalito, CA 94965

RHAA PROJECT NUMBER

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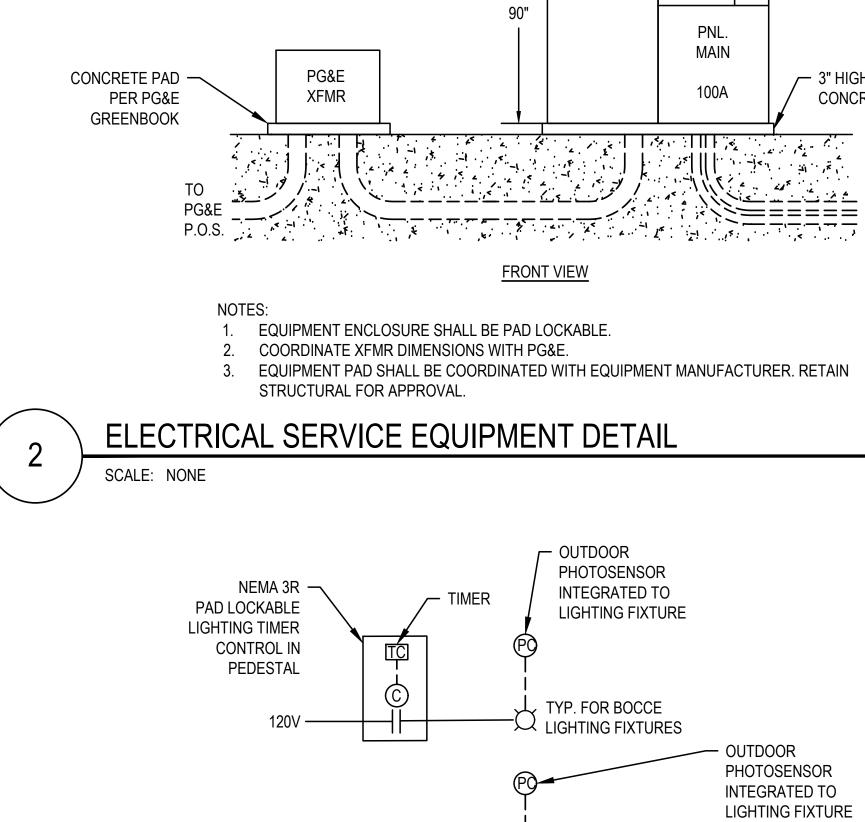
SCALE NONE

SHEET TITLE **ELECTRICAL DETAILS**

DRAWN BY: KZ

CONSTRUCTION

CHECKED BY:



NOTES:

SCALE: NONE

DAYLIGHT IS AVAILABLE.

EXTERIOR LIGHTING CONTROL DIAGRAM

EQUIPMENT PAD —

PLAN VIEW

INCOMING SECTION

TYP. FOR PARKING

LOT LIGHTING

FIXTURES

1. PARKING LOT LIGHTING FIXTURES: LIGHTS SHALL TURN ON AT DUSK AND TURN OFF WHEN

2. BOCCE COURT LIGHTING FIXTURES: LIGHTS SHALL TURN ON AT DUSK AND TURN OFF AT A

PRE-PROGRAMMED TIME. COORDINATE WITH OWNER FOR TIME SCHEDULING

PNL.

100A

- OUTDOOR

PHOTOSENSOR INTEGRATED TO LIGHTING FIXTURE

ELECTRICAL METER

∕— 3" HIGH

CONCRETE PAD

PG&E XFMR

