

225 Miller Avenue, Mill Valley, CA 94941 T 415 383 7900 F 415 383 1433 www.rhaa.com

PROJECT/CLIENT NAME

Dunphy Park Improvement Project

200 Napa Street Sausalito, CA 94965

City of Sausalito 420 Litho St. Sausalito, CA 94965

RHAA PROJECT NUMBER

16042A

CONSULTANT

SUBMITTAL

Permit Submittal

21 August 2017

REVISIONS

9-18-2017 Permit Plan Check Response

REGISTRATION AND SIGNATURE




SCALE

SHEET TITLE

GRADING PLAN

DRAWN BY:

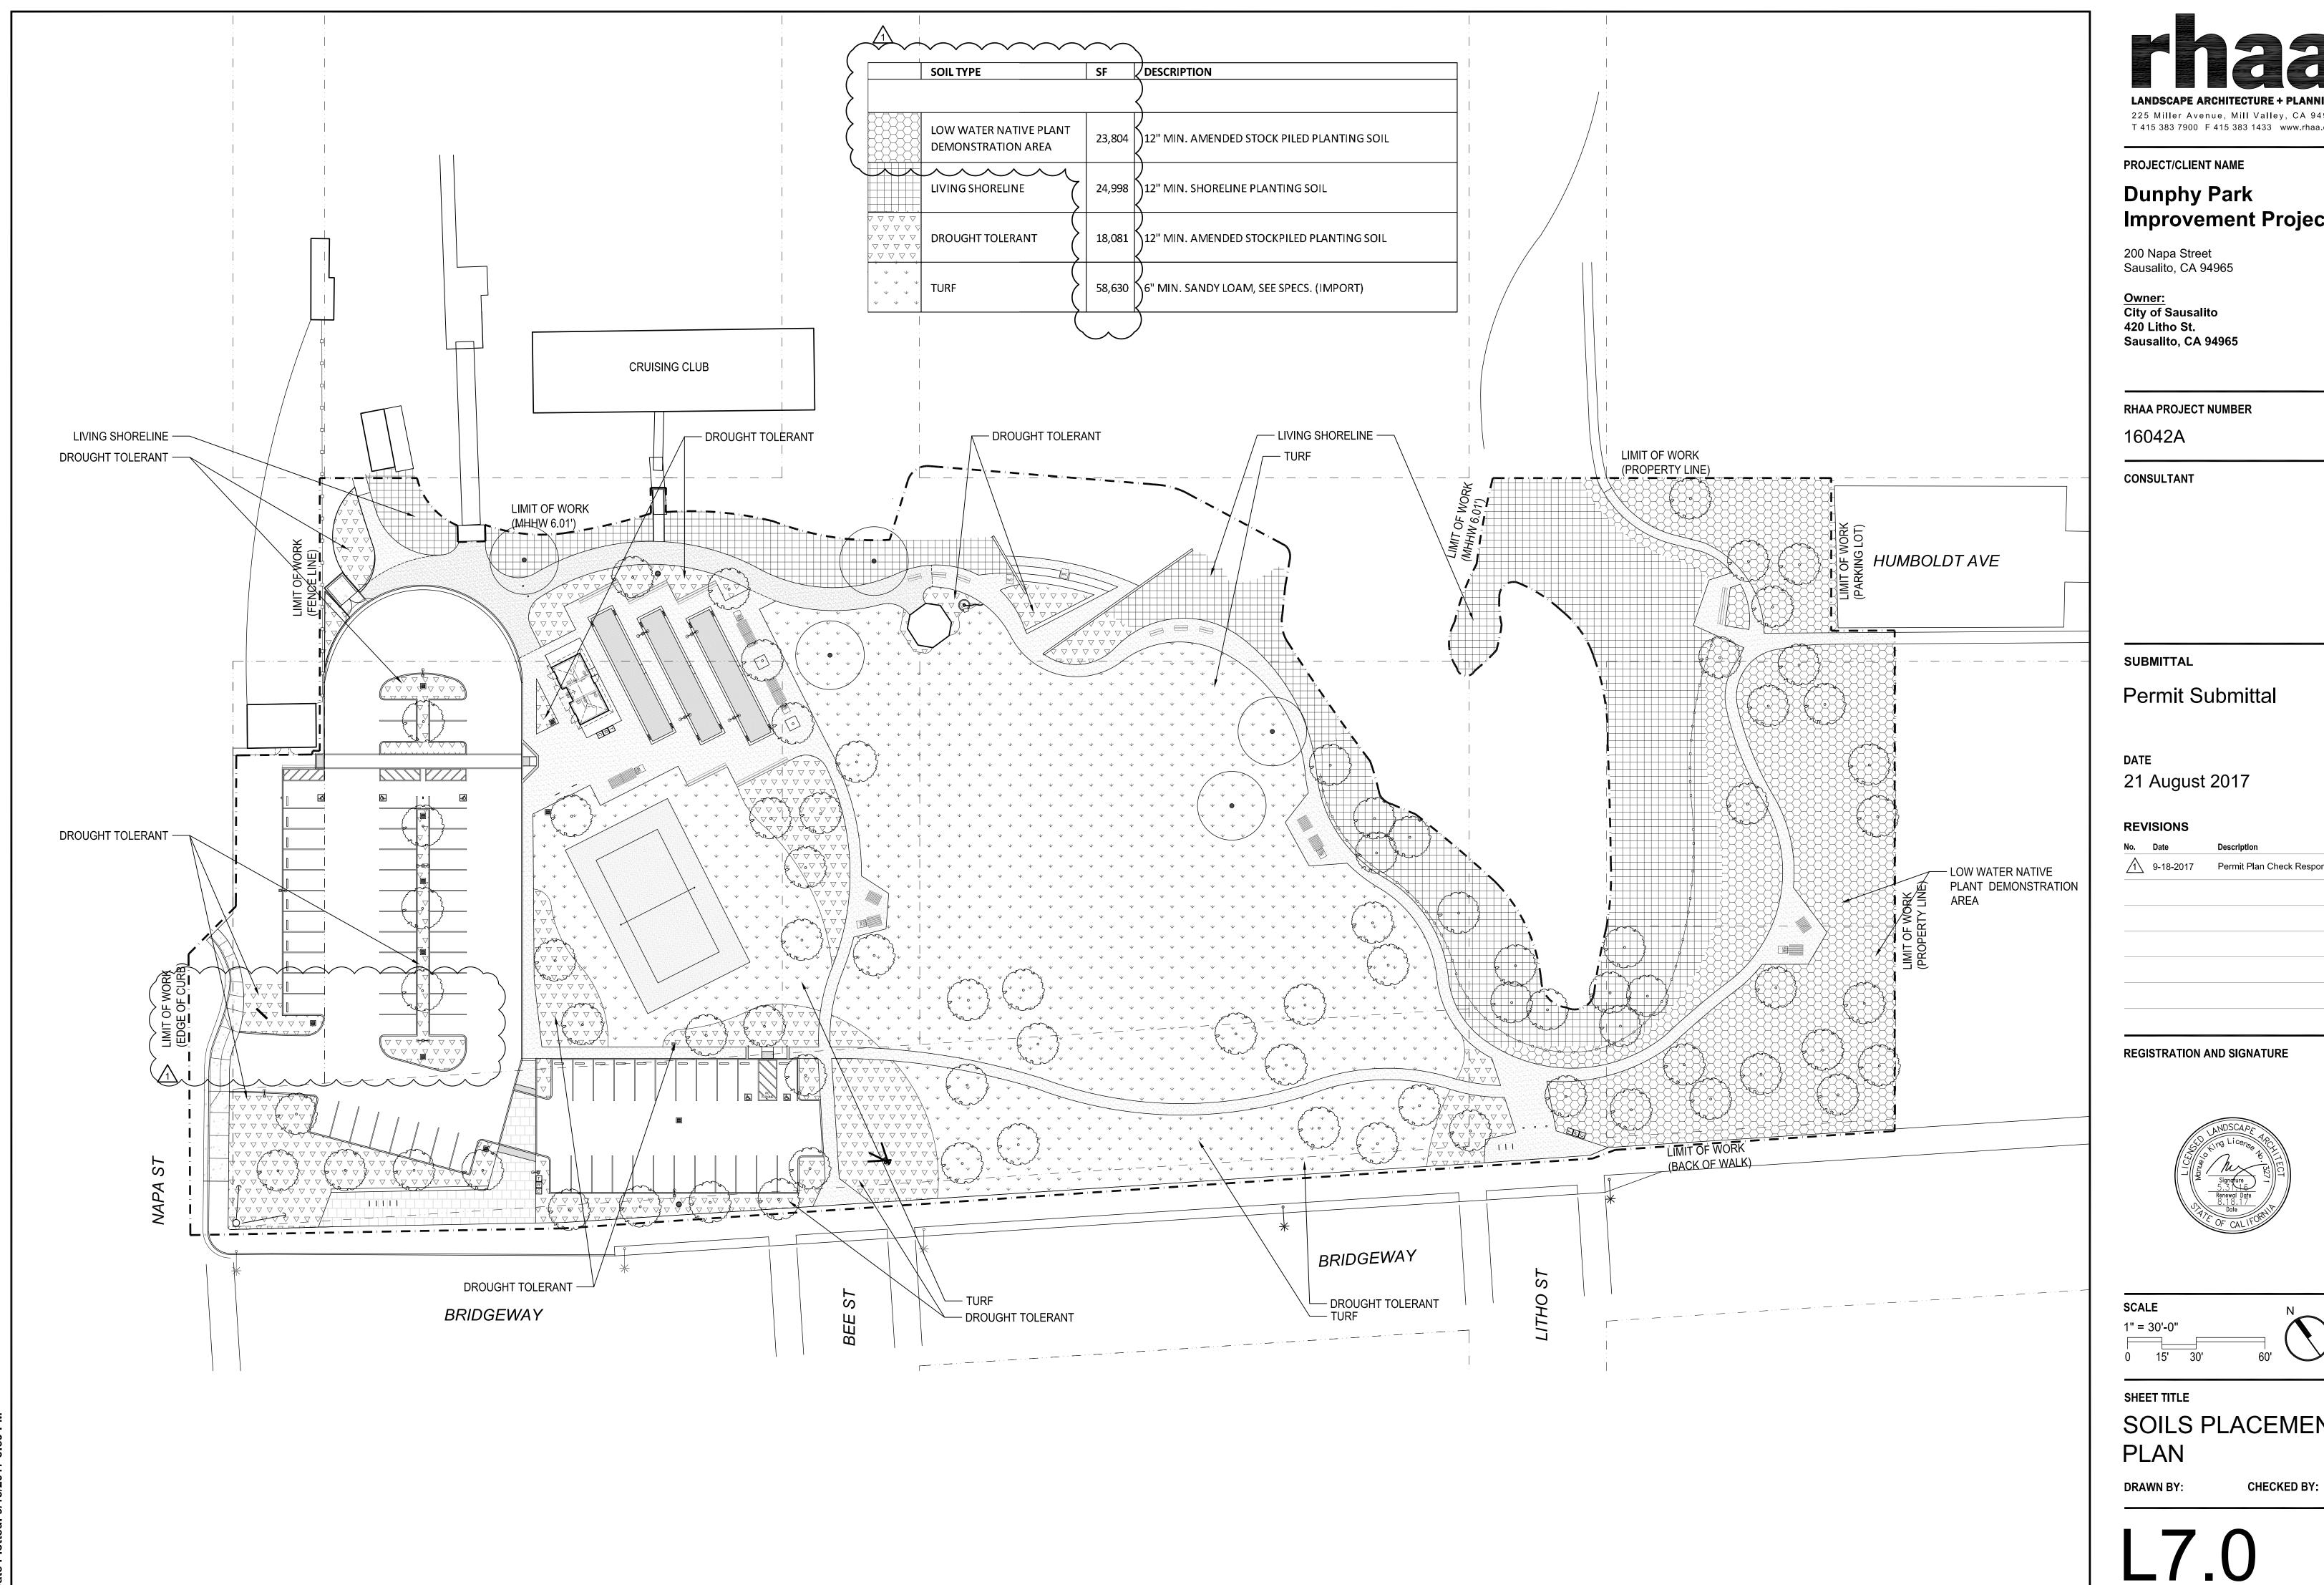

225 Miller Avenue, Mill Valley, CA 94941 T 415 383 7900 F 415 383 1433 www.rhaa.com


Improvement Project

9-18-2017 Permit Plan Check Response



SCA	LE			Ν_
1" =	30'-0"			
0	15'	30'	60'	

SOILS PLACEMENT

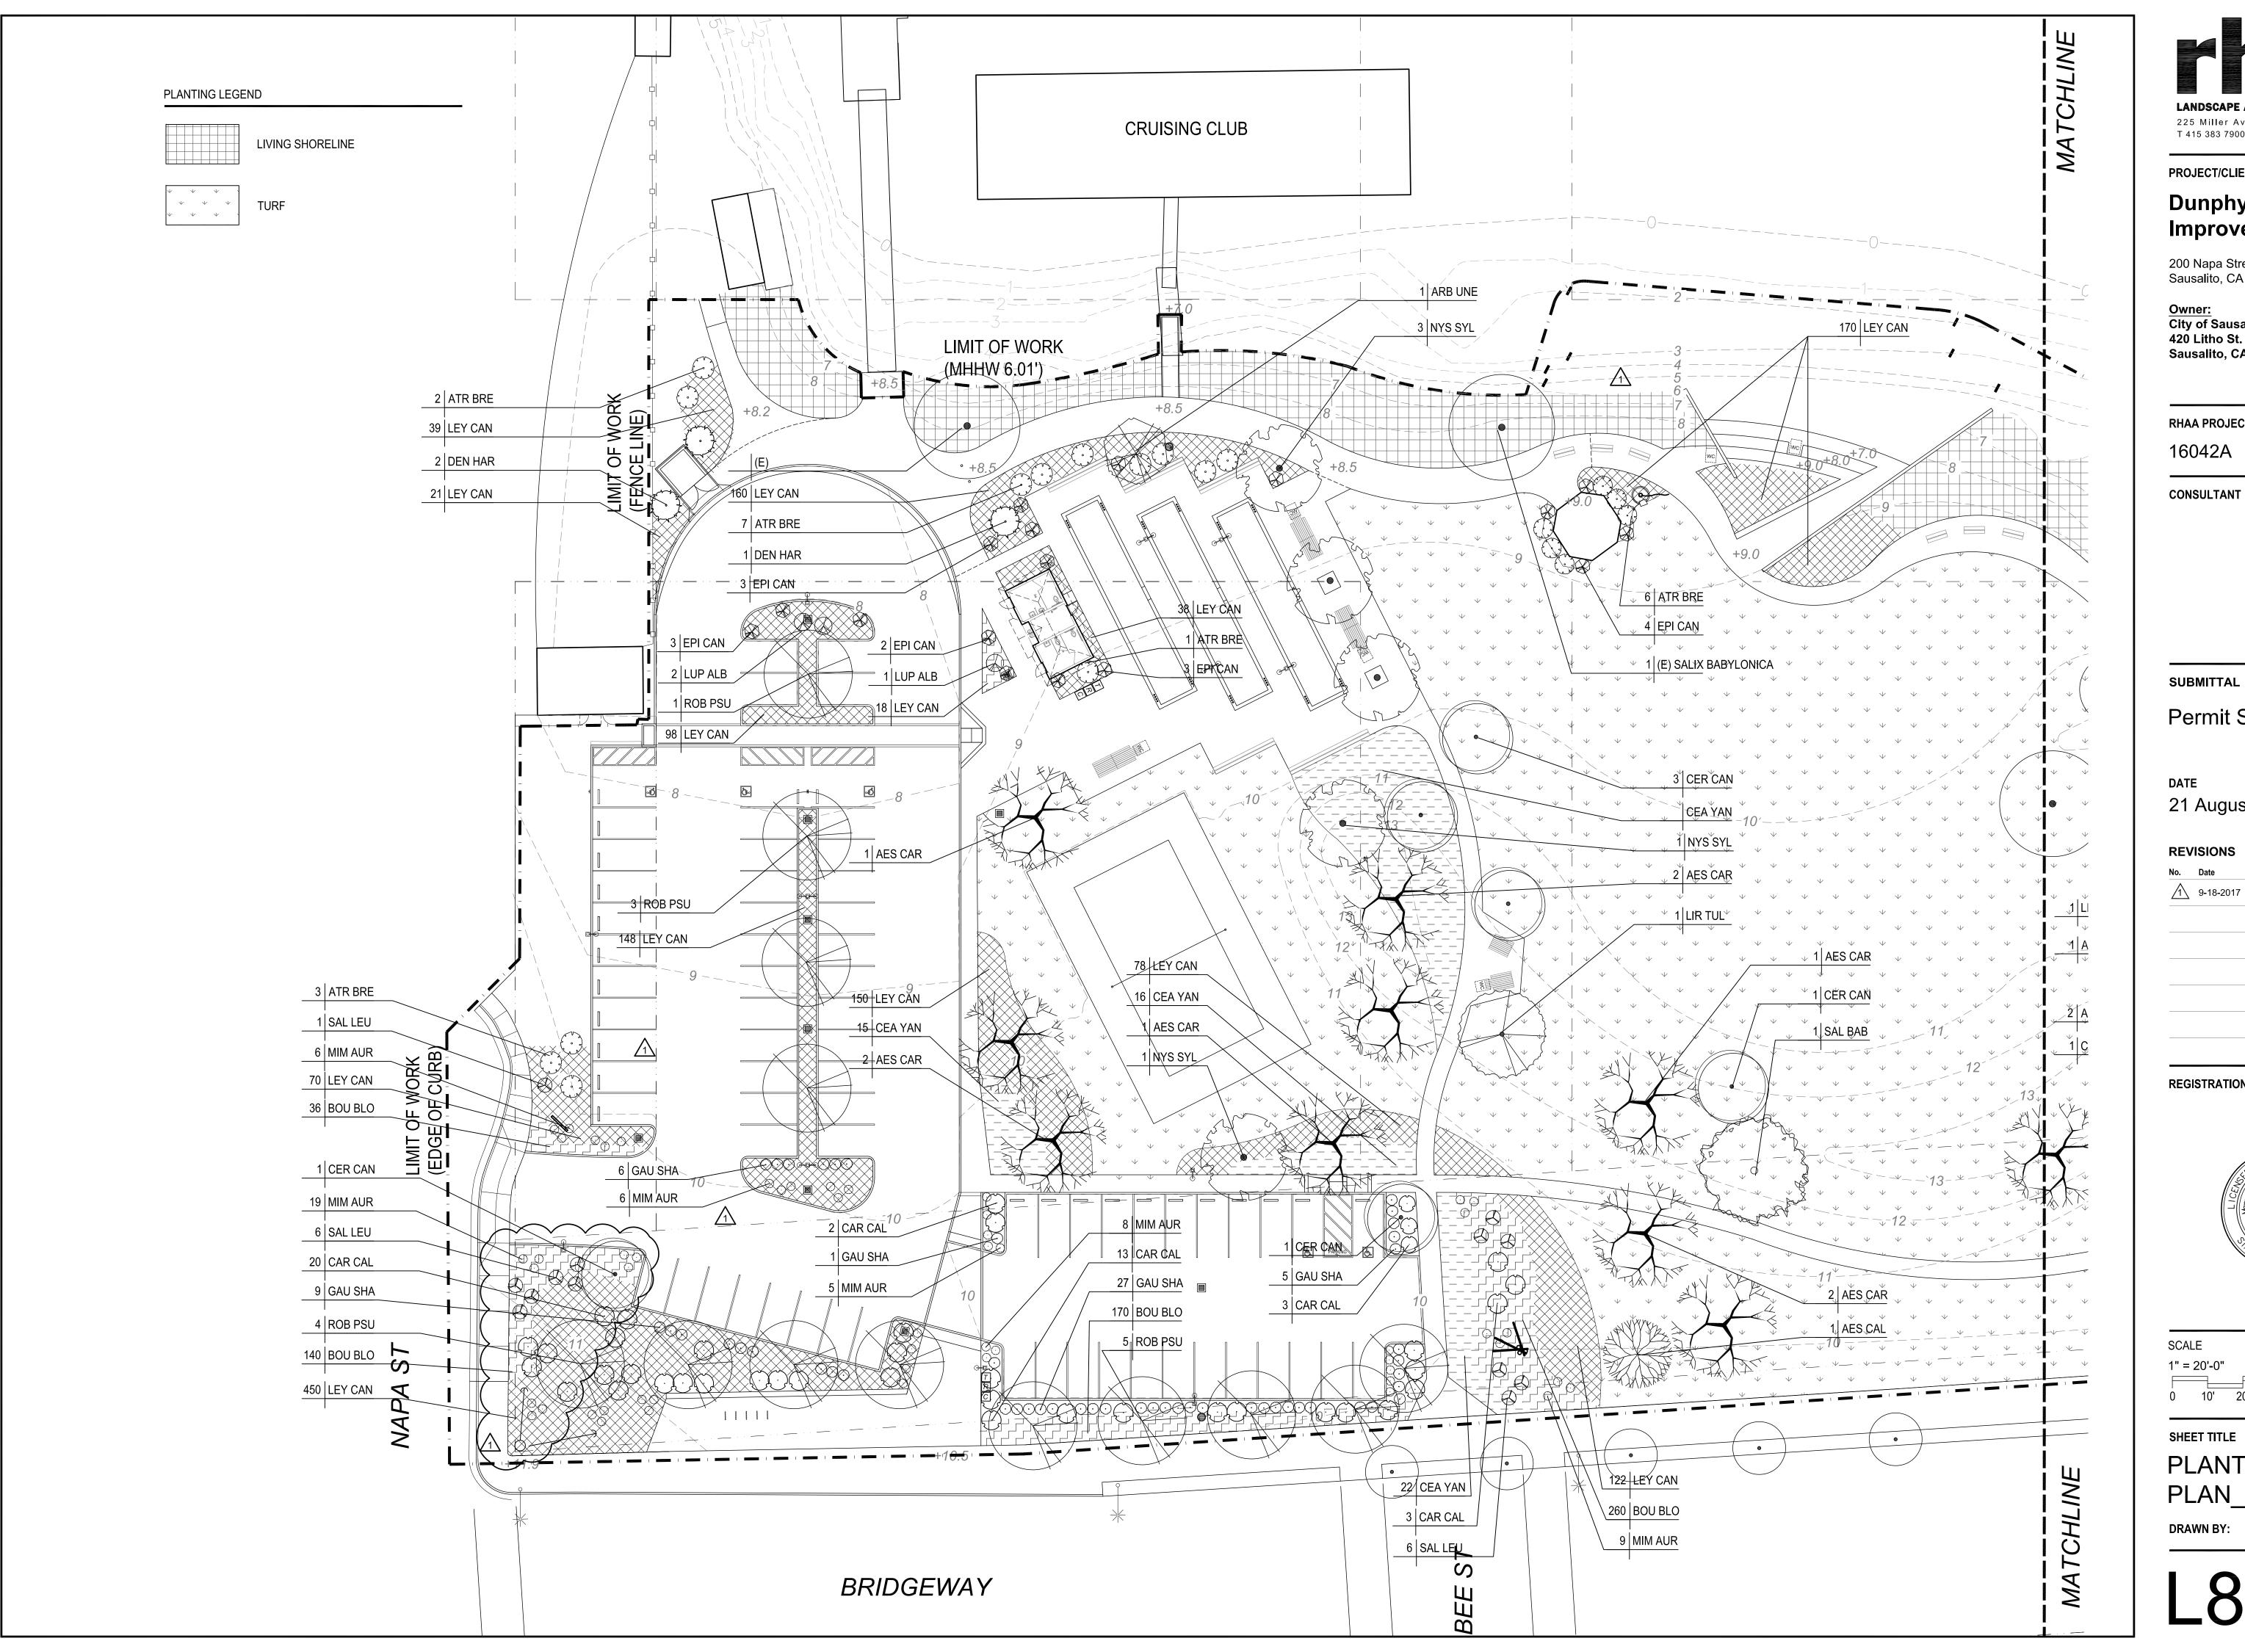



PROJECT/CLIENT NAME

Dunphy Park Improvement Project

200 Napa Street Sausalito, CA 94965

Owner: City of Sausalito 420 Litho St. Sausalito, CA 94965

RHAA PROJECT NUMBER

16042A

CONSULTANT


Permit Submittal

21 August 2017

9-18-2017 Permit Plan Check Response


REGISTRATION AND SIGNATURE



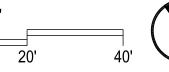

SHEET TITLE

PLANTING PLAN_Park East

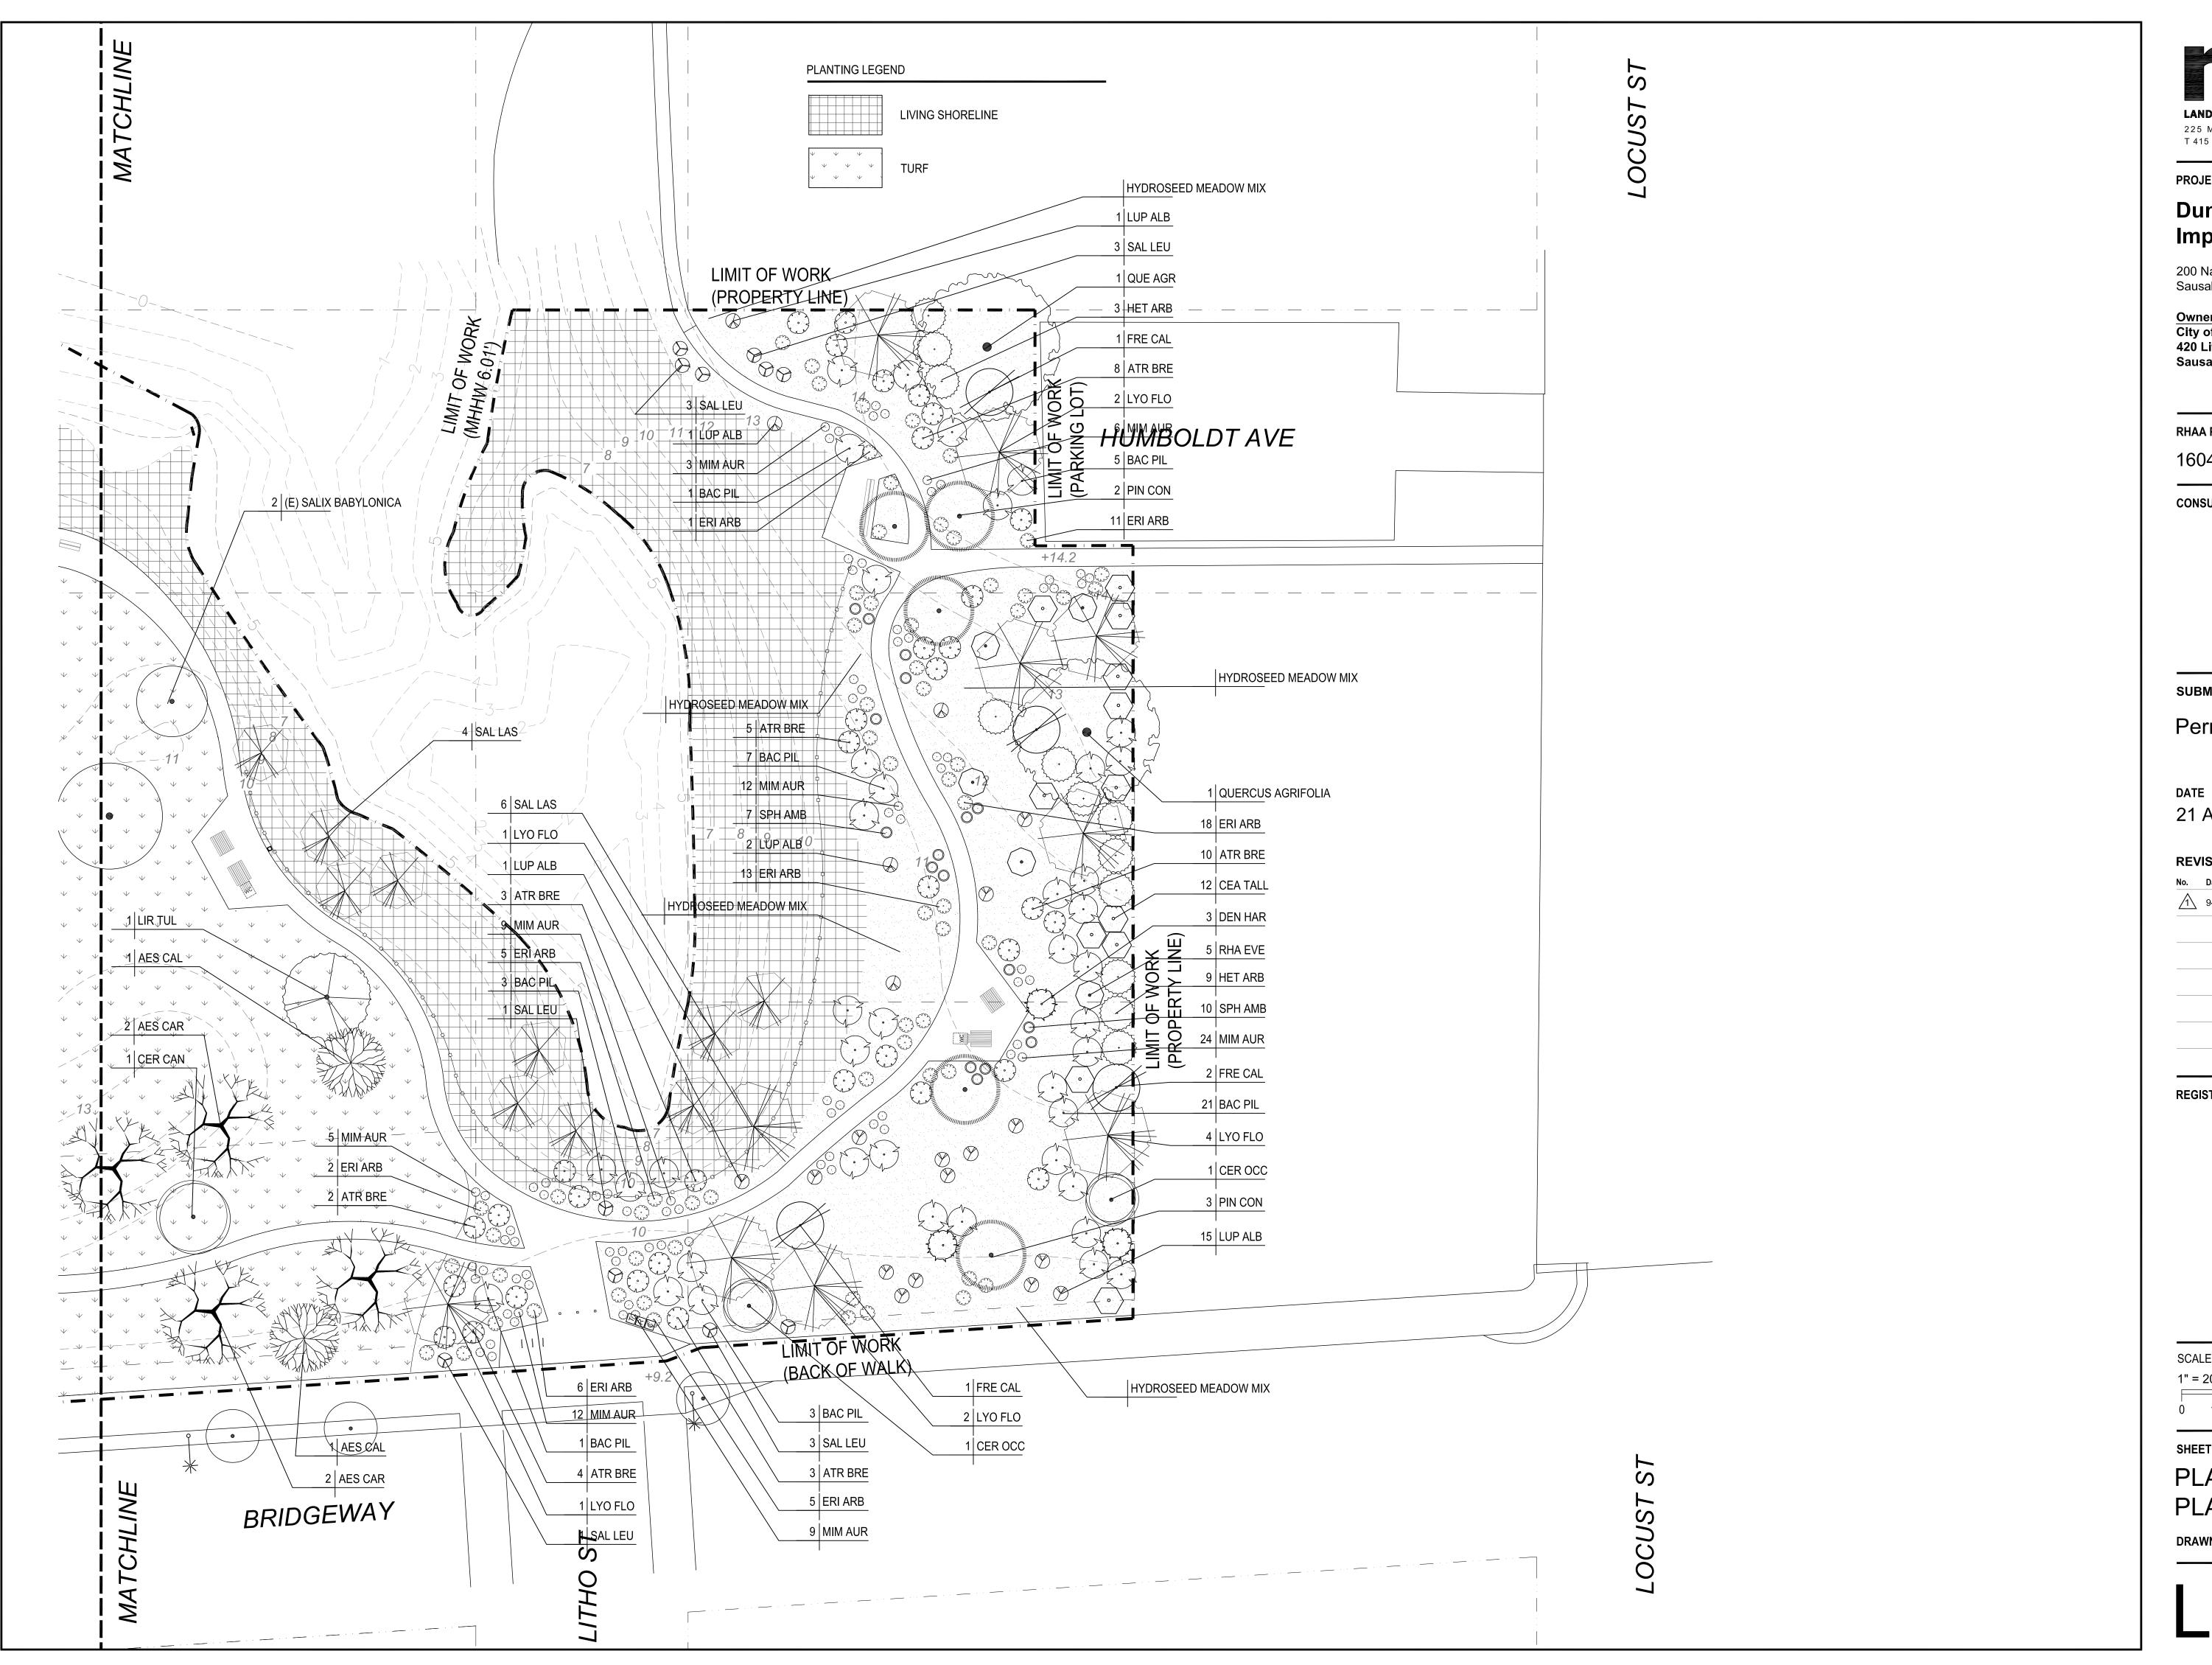



PROJECT/CLIENT NAME

Dunphy Park Improvement Project

200 Napa Street Sausalito, CA 94965

Owner: City of Sausalito 420 Litho St. Sausalito, CA 94965

RHAA PROJECT NUMBER

16042A

CONSULTANT

SUBMITTAL

Permit Submittal

21 August 2017

REVISIONS

9-18-2017 Permit Plan Check Response

REGISTRATION AND SIGNATURE



SCAL	_E			N
1" =	20'-0"			
0	10'	20'	40'	

SHEET TITLE

PLANTING PLAN_Park West

 Atrip Arct Bacc Carp Cear Den Epilo 	ctostaphylos densiflora 'Howard McMinn'	Brewer Saltbush								
- Arct Bacc Carp Cear Den Epilo	ctostaphylos densiflora 'Howard McMinn'	Brewer Salthush								
Bacc Carp Cear Den Epilo	· ·		5'-7'	6'-8'	Тү	Low	BCDC	15G	SEE PLAN	54
○ Carp○ Cear○ Den⊗ Epilo	ccharis pilularis	Howard McMinn Manzanita	6-10'	6-12'	Υ	Low	FODP	15G	SEE PLAN	_
○ Cear○ Den⊗ Epilo	curaris pirararis	Coyote Brush	3'-9'	3'-12'	Υ	Low	FODP	5G	SEE PLAN	41
DenEpilo	rpenteria californica	Bush Anemone	4'-6'	4'-6'	Υ	Low	FODP	15G	SEE PLAN	41
	anothus 'Cynthia Postan'	Cynthia Postan Wild Lilac	6'-8'	6'-8'	Υ	Low	FODP	15G	SEE PLAN	12
Срп	endronmecon harfordii	Island Bush Poppy	8-12'	8-12'	Υ	Low		15G	SEE PLAN	6
© Erio	ilobium canum 'Catalina'	California fuchsia	3'-4'	4'-5'	Υ	Very Low	BCDC	5G	SEE PLAN	17
	ogonum arborescens	Santa Cruz Island Buckwheat	2'-6'	3'-5'	Υ	Low	BCDC	5G	SEE PLAN	64
- Erio	iogonum latifolium	Coast Buckwheat	1'	3'	Υ	Low	BCDC	5G	SEE PLAN	-
- Erio	iogonum umbellatum	Sulphur Buckwheat	1'	3'	Υ	Low		5G	SEE PLAN	
Fren	emontodendron californicum	Flannel Bush	15'-20'	10-15'	Υ	Low	BCDC	24" Box	SEE PLAN	4
	ultheria shallon	Salal	4'-10'	6'-12'	Υ	Moderate	BCDC	15G	SEE PLAN	> 49
• Hete	eteromeles arbutifolia	Toyon	6'-10'	6'-10'	Υ	Low	FODP	15G	SEE PLAN	11
& Lupi	pinus albifrons	Silver Bush Lupine	5'	5'	Υ	Low	BCDC	5G	SEE PLAN	23
o Mim	•	Sticky Monkey Flower	2'	2'-3'	Υ	Low	BCDC	5G	SEE PLAN	133
① Rhar		Coffee Berry	4'-8'	4'-8'	Y	Low	BCDC	15G	SEE PLAN	5
		Purple Sage	2'-3'	3'-4'	Y	Low	BCDC	5G	SEE PLAN	24
+		Apricot Mallow	3'-4'	2'-3'	Y	Very Low		5G	SEE PLAN	7 17
~~~	RASS									
<del>*************************************</del>	<u> </u>	Blonde Ambition Gramma	2'	2'	<u> Y</u>	Low	<u> </u>	1G	24" OC	624
Leyr	ymus condensatus 'Canyon Prince'	Canyon Prince Wild Rye	4'	3'	Y	Low	BCDC	1G	30" OC	1607
GRO	ROUNDCOVER									
Cear	anothus 'Yankee Point'	Yankee Point Wild Lilac	2'-3'	8'-10'	Υ	Low	FODP	5G	6' OC	<b>12</b> 5
TUR	IRF									
Salt-	lt-tolerant Sod	Seashore Paspalum (alt = Red	l Molate Fo	escue)					<u> </u>	62834 sc
LIVII	/ING SHORELINE									
Salin	lix lasiolepis	Arroyo willow	less 30'	Less 30'	Y	Low	BCDC	24" Box	SEE PLAN	10
Bacc	ccharis douglasii (glutinosa)	Marsh Baccharis	3'	3'	Y	Low	BCDC	15G	36" OC	313
		Sea Lavender	1'-2'	2'	Ty	Low	BCDC	5G	24" OC	313
<del></del>		salt grass	1'		Ty	Low	BCDC	Flats	24" OC	4063
	-	Bluff Lettuce	6"	1'	TY	Low	BCDC	1G	24" OC	313
	-	pickleweed	1'-2'		Ty	Low	BCDC	Flats	24" OC	625
<del>                                      </del>		cordgrass	1'-4'		Ty	Low	BCDC	Flats	24" OC	625

QUANTITY

23,804 SQ. FT.

**COMMON NAME** 

RED RIBBONS

GOLDFIELDS

CALIFORNIA BARLEY

CALIFORNIA ONIONGRASS

NODDING NEEDLEGRASS

PURPLE NEEDLEGRASS

NATIVE PINE BLUEGRASS

BLUE-THIMBLE FLOWER

CALIFORNIA POPPY

MINATURE LUPINE

COMMON MADIA

BABY BLUE EYES

CALIFORNIA DESERT BLUEBELLS

		T	I	T	T	1	I	I	I-: 1	
	TYPE	SCIENTIFIC	COMMON	HEIGHT	SPREAD	NATIVE (y/n)	WA FER USE	SOURCE	SIZE	QTY
	TREES									
		Aesculus californica	California Buckeye	15'-30'	15'-30'	Υ	Low	BCDC	36" Box	3
		Aesculus x carnea	Red Horse Chestnut	to 30'	to 20'	N	Moderate		36" Box	13
		Arbutus unedo	Strawberry Tree	15'-30'	15'-30'	N	Low	FODP	24" Box	1
	·	Cercis canadensis	Eastern Redbud	20'-30'	20'-30'	N	Moderate		24" Box	7
		Cercis occidentalis	Western Redbud	10'-15'	10'-15'	Υ	Low	BCDC	24" Box	2
$\langle \rangle$		Liriodendron tulipifera	Tulip Tree	to 60'	to 30'	N	Moderate		36" Box	2
J		Lyonothamnus floribundus 'aspenifolius'	Catalina Is. Ironwood	25'-35'	15'	Υ	Low	FODP	24" Box	10
	Con	Nyssa Sylvatica	Sour Gum, Tupelo	25'-35'	20'-30'	N	Moderate		36" Box	5
		Pinus contorta var. 'contorta'	Shore Pine	20'-30'	20'-30'	Υ	Low	BCDC	24" Box	5
		Robinia psuedoacacia	BlackLocust	40'-50'	30'-40'	N	Moderate		24" Box	13
	E	Salix babylonica	Weeping Willow	30'-45'	30'-45'	N	Moderate	FODP	36" Box	1
)		Salix lasiolepis	Arroyo willow	less 30'	Less 30'	Υ	Low	BCDC	24" Box	10
	& · · · · ·	Quercus agrifolia	Coast Live Oak	30'-45'	30'-45'	Υ	Low	FODP	36" Box	2

# Planting Notes

- Trees and plants have been selected for the local conditions and are drought tolerant.

  Tolerant.
- All soil and subsoil to be tested by an approved accredited soil testing laboratory.
- Landscape architect to inspect planting layout prior to installation. Contractor to provide 10'x10' mockup of all plant mixes for approval by landscape architect.
- 4. All planting areas, planters, and pots to receive 3" of organic mulch.



T 415 383 7900 F 415 383 1433 www.rhaa.com

PROJECT/CLIENT NAME

# Dunphy Park Improvement Project

200 Napa Street Sausalito, CA 94965

Owner:
City of Sausalito
420 Litho St.
Sausalito, CA 94965

RHAA PROJECT NUMBER

16042A

CONSULTANT

SUBMITTAL

Permit Submittal

DATE

21 August 2017

**REVISIONS** 

te Descrip

9-18-2017 Permit Plan Check Response

REGISTRATION AND SIGNATURE



SHEET TITLE
PLANTING
SCHEDULE

DRAWN BY:

**CHECKED BY:** 

SYMBOL SCIENTIFIC NAME

HORDEUM CALIFORNICUM

MELICA CALIFORNICA

NASSELLA CERNUA

NASSELLA PULCHRA

CLARKIA CONCINNA

GILIA CAPITATA

LUPINE BICOLOR

MADIA ELEGANS

NOTES:
1. APPLY MEADOW GRASSES HYDROSEED MIX AT 40 LBS/ACRE

NEMOPHILA

PHACELIA


ESCHOLZIA

LASTHENIA

POA SECUNDA

_8.2

# **TREES**

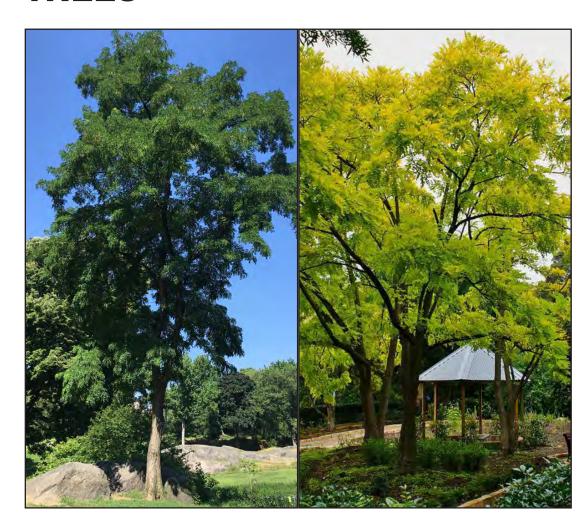


ROBINIA PSUEDOACACIA BLACK LOCUST 40'H x 30'W



LIRIODENDRON TULIPIFERA
TULIP TREE
50'H x 25'W



ARBUTUS UNEDO STRAWBERRY TREE 20'H x 15'W

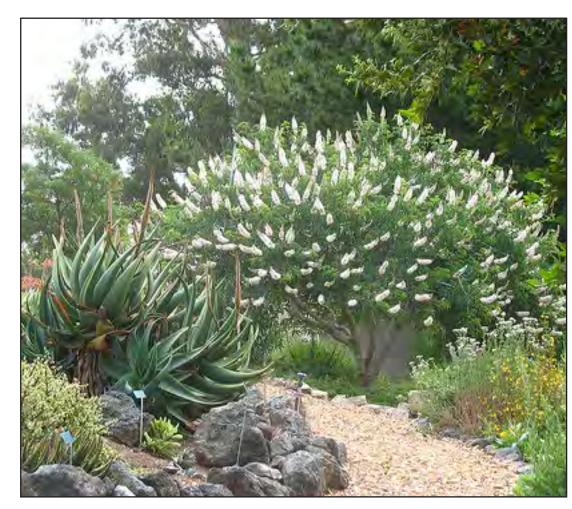

AESCULUS CALIFORNICA
CALIFORNIA BUCKEYE
20'H x 20'W



SALIX BABYLONICA
WEEPING WILLOW
30'H x 30'W



SALIX LASIOLEPIS ARROYO WILLOW 30'H x 30'W



LYONOTHAMNUS FLORIBUNDUS ASPLENIFOLIUS CATALINA ISLAND IRONWOOD 30'H x 15'W



CERCIS CANADENSIS
EASTERN REDBUD
25'H x 25'W



AESCULUS X CARNEA
HORSE-CHESTNUT
30'H x 20'W



QUERCUS AGRIFOLIA COAST LIVE OAK 40'H x 40'W



PINUS CONTORTA VAR. CONTORTA SHORE PINE 25'H x 20'W



CERCIS OCCIDENTALIS
WESTERN REDBUD
15'H x 15'W



ALNUS RUBRA RED ALDER 40'H X 25'W

# LANDSCAPE ARCHITECTURE + PLANNING 225 Miller Avenue, Mill Valley, CA 94941

T 415 383 7900 F 415 383 1433 www.rhaa.com

PROJECT/CLIENT NAME

# Dunphy Park Improvement Project

200 Napa Street Sausalito, CA 94965

Owner: City of Sausalito 420 Litho St. Sausalito, CA 94965

RHAA PROJECT NUMBER

16042A

CONSULTANT

SUBMITTAL

Permit Submittal

DATE
21 August 2017

**REVISIONS** 

No. Date Description

9-18-2017 Permit Plan Check Response

REGISTRATION AND SIGNATURE



PLANTING PALETTE

RAWN BY:

# LARGE SHRUBS



**LUPINUS ALBIFRONS** SILVER BUSH LUPINE 5'H x 5'W



**GAUTHERIA SHALLON** SALAL 7'H x 9'Wt



**CEANOTHUS 'CYNTHIA POSTAN'** CYNTHIA POSTAN WILD LILAC 7'H x 7'W



**BACCHARIS PILULARIS COYOTE BRUSH** 6'H x 8'W



**ATRIPLEX LENTIFORMIS 'BREWERII' BREWER SALTBUSH** 6'H x 8'W



**HOWARD MCMINN MANZANITA** 8'H x 10'W



**RHAMNUS CALIFORNICA 'EVE CASE' EVE CASE COFFEE BERRY** 6'H x 6'Wt'



**HETEROMELES ARBUTIFOLIA TOYON** 8'H x 8'W



**DENDRONMECON HARFORDII ISLAND BUSH POPPY** 10'H x 10'W



**CARPENTERIA CALIFORNICA BUSH ANEMONE** 6'H x 5'W



**ARCTOSTAPHYLOS DENSIFLORA 'HOWARD MCMINN'** 

# NATIVE HABITAT RESTORATION AREA



MEDIUM & SMALL SHRUBS **ERIOGONUM ARBORESCENS**, SANTA CRUZ ISLAND BUCKWHEAT **ERIOGONUM LATIFOLIUM**, COAST BUCKWHEAT **ERIOGONUM UMBELLATUM**, SULPHUR BUCKWHEAT **MIMULUS AURANTICUS**, STICKY MONKEY FLOWER **SALVIA LEUCOPHYLLA**, PURPLE SAGE **SPHAERALCEA AMBIGUA**, APRICOT MALLOW

HERBACEOUS PERENNIALS


**ACHILLEA MILLEFOLIUM**, YARROW **DICHELOSTEMMA IDA-MAIA**, FIRECRACKER FLOWER **ESCHSCHOLZIA CALIFORNICA**, CALIFORNIA POPPY **IRIS DOUGLAS IRIS** SOLIDAGO CALIFORNICA, CALIFORNIA GOLDENROD **VERBENA GOODINGII**, PINK VERBENA


**GRASSES** 

**BOUTELOUA GRACILIS**, BLONDE AMBITION GRAMMA GRASS **CAREX PANSA**, DUNE SEDGE **CAREX DIVULSA**, BERKELEY SEDGE **DESCHAMPSIA CESPITOSA VAR HOLCIFORMIS** FESTUCA RUBRA, CREEPING RED FESCUE **LEYMUS CONDENSATUS 'CANYON PRINCE'**, CANYON PRINCE RYE

*ALSO SEE LARGE SHRUBS ABOVE.

# LIVING SHORELINE

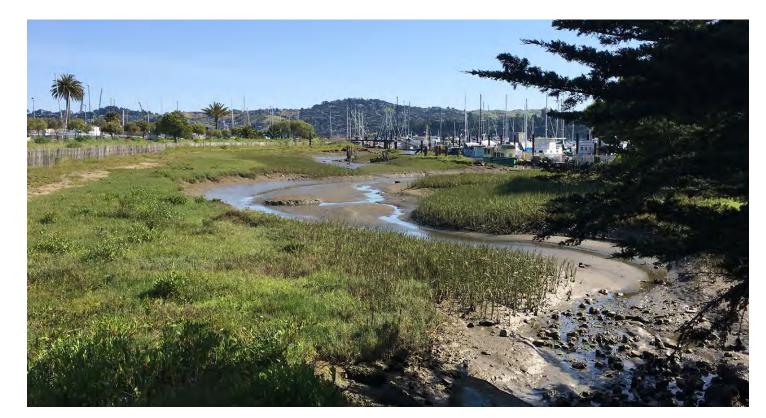

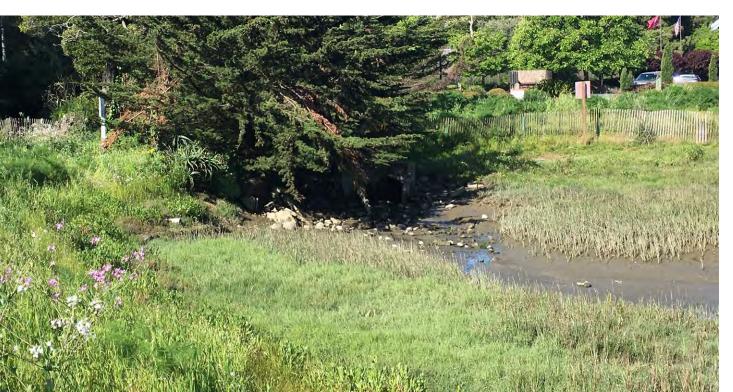

**SHRUBS** ATRIPLEX LENTIFORMIS 'BREWERII', BREWER SALTBUSH **BACHARIS DOUGLASII, MARSH BACCHARIS BACCHARIS PILULARIS, COYOTE BRUSH LIMONIUM CALIFORNICUM**, SEA LAVENDER

**GRASSES DISTICHLIS SPICATA**, SALT GRASS **SPARTINA FOLIOSA**, CORDGRASS

SUCCULENTS **DUDLEYA FARINOSA**, BLUFF LETTUCE **SARCOCORNIA PACIFICA**, PICKLEWEED 225 Miller Avenue, Mill Valley, CA 94941 T 415 383 7900 F 415 383 1433 www.rhaa.com

PROJECT/CLIENT NAME

# **Dunphy Park Improvement Project**

200 Napa Street Sausalito, CA 94965

City of Sausalito 420 Litho St. Sausalito, CA 94965

**RHAA PROJECT NUMBER** 

16042A

CONSULTANT

**SUBMITTAL** 

Permit Submittal

DATE 21 August 2017


REVISIONS


**REGISTRATION AND SIGNATURE** 



SHEET TITLE PLANTING PALETTE




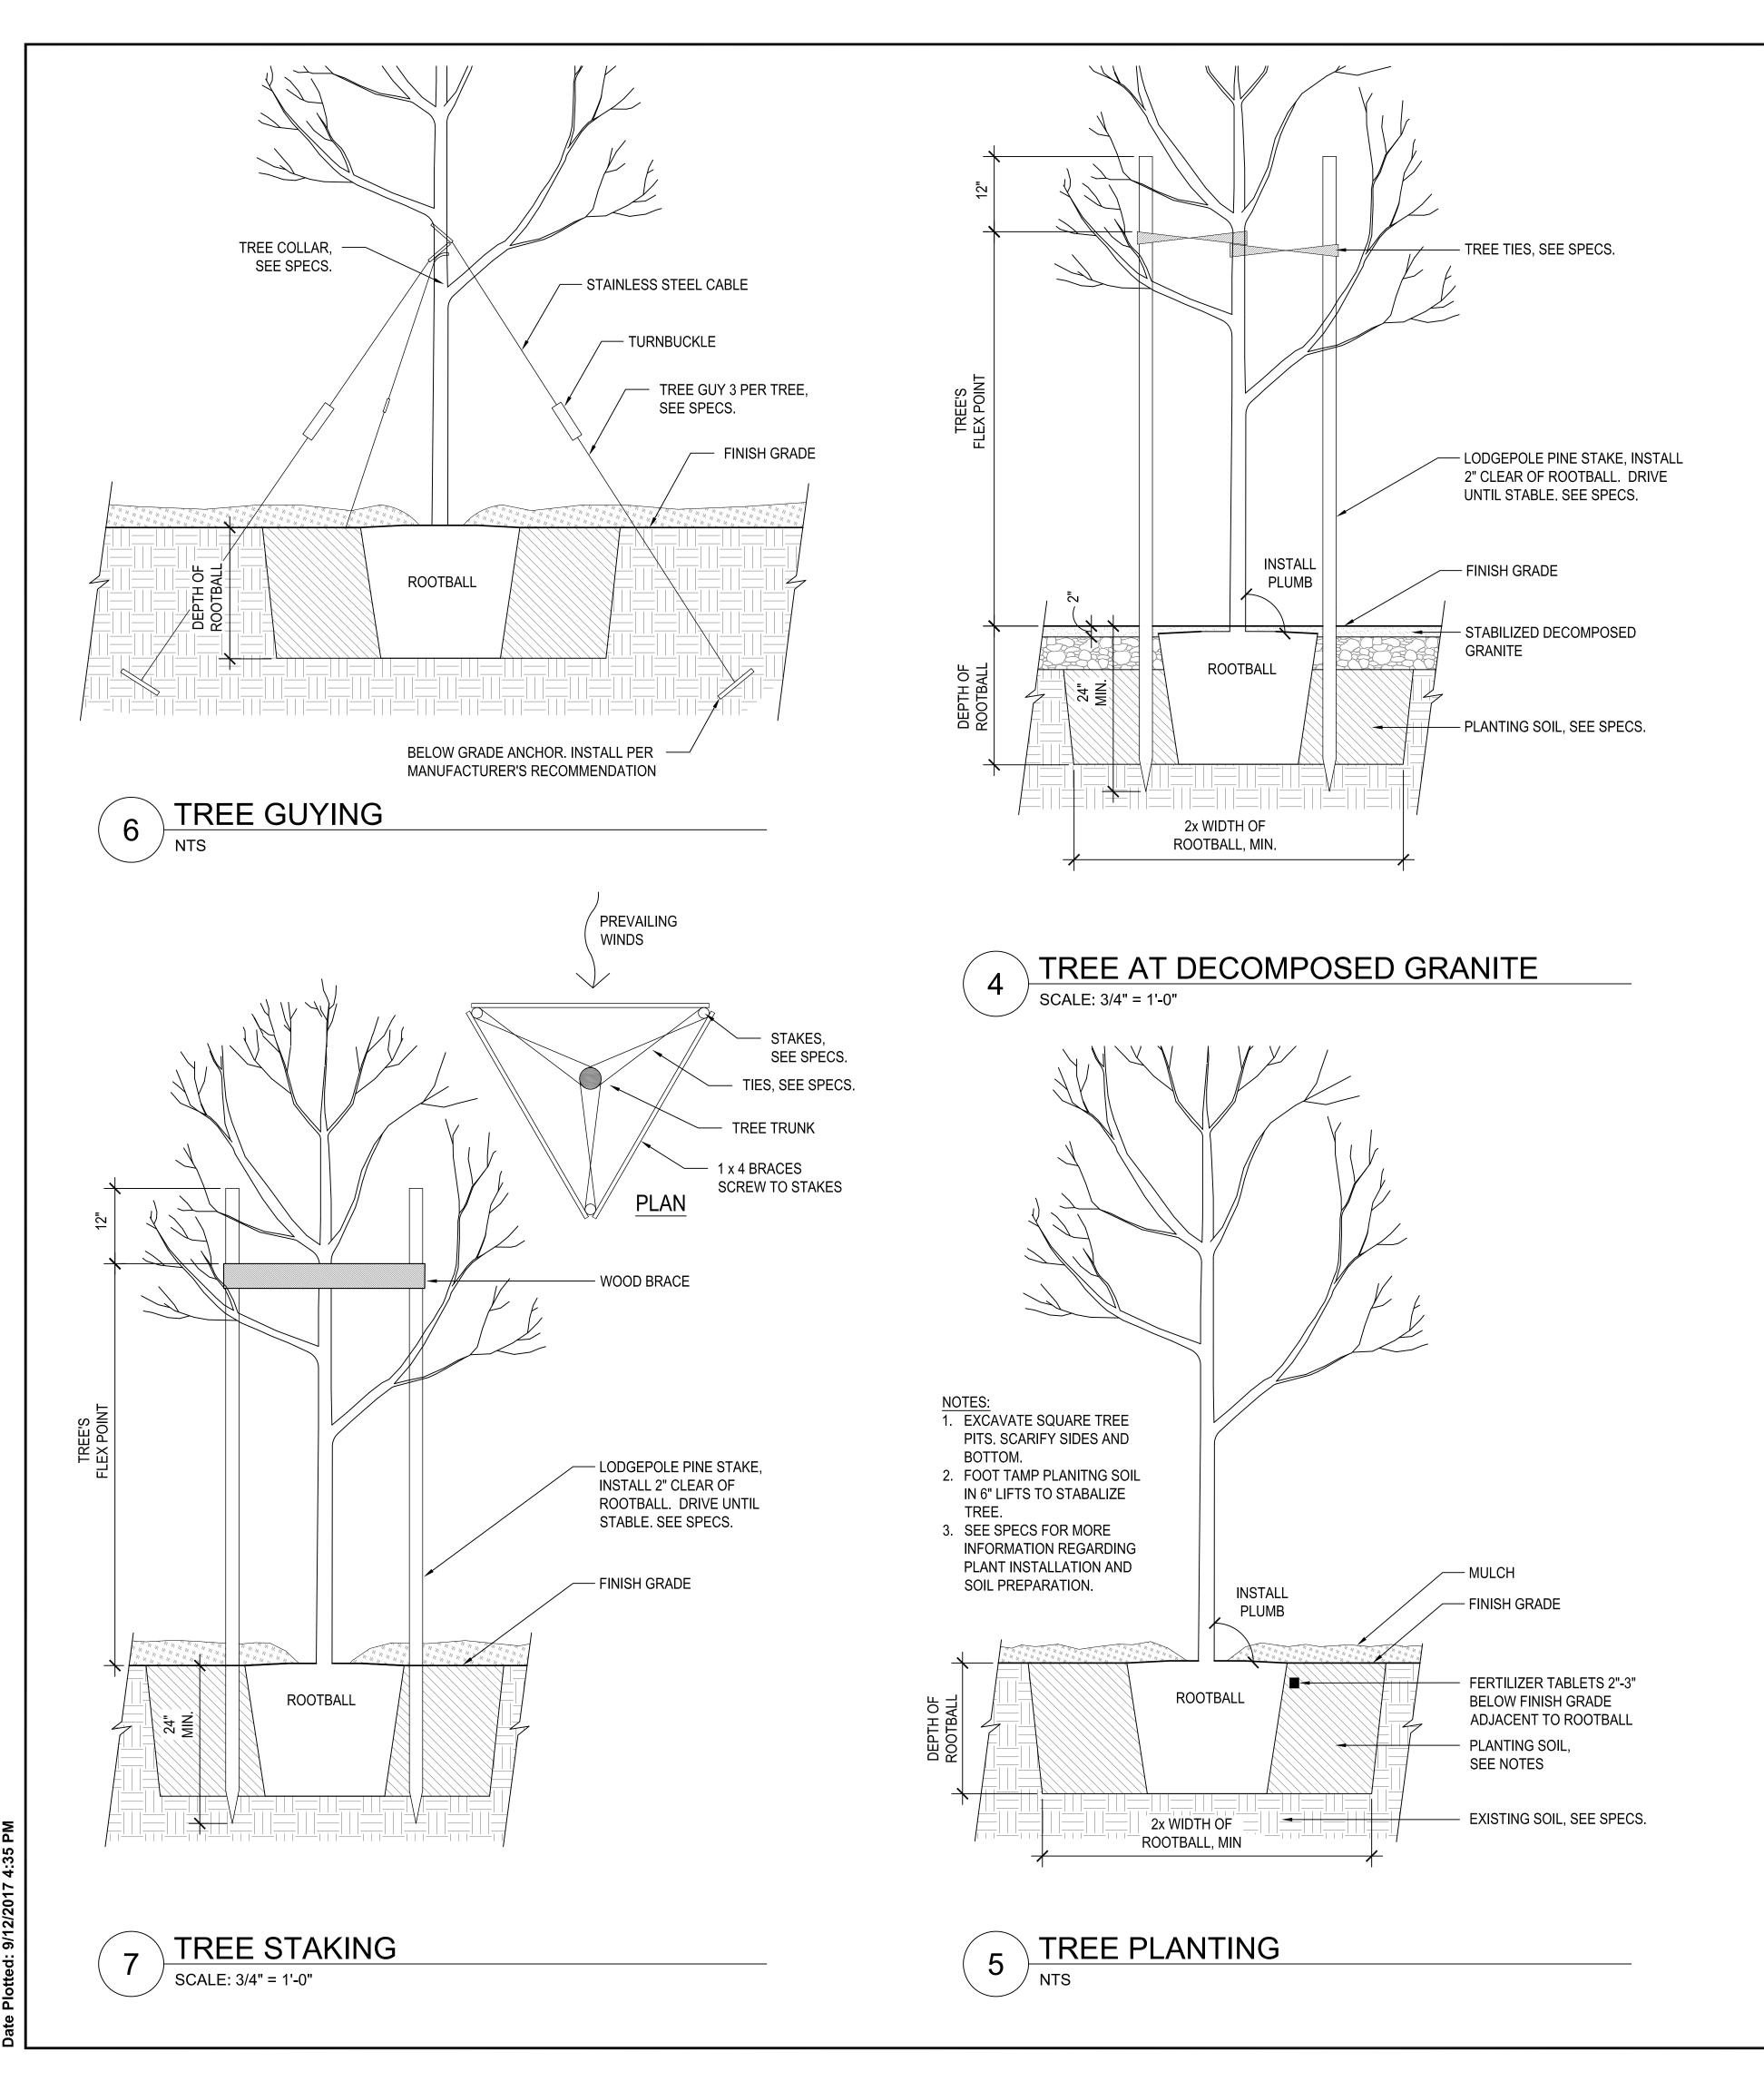

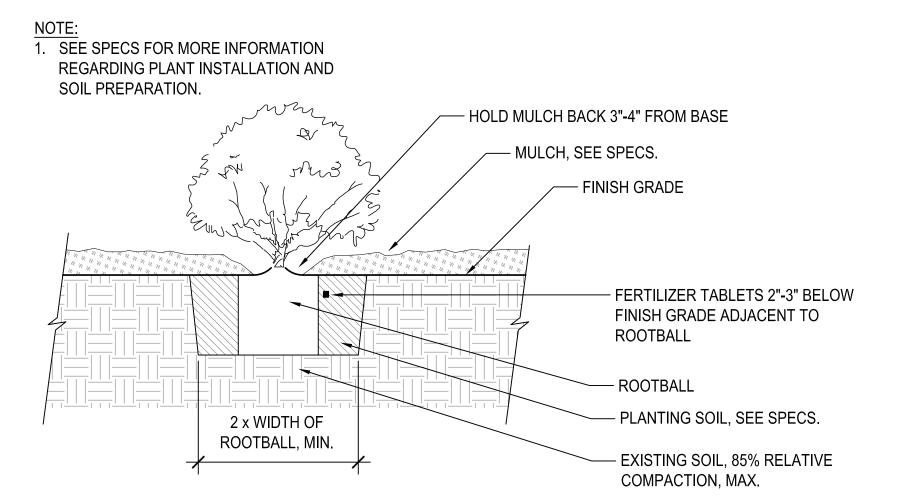

SHRUB PLANTING

SCALE: 1" = 1'-0"

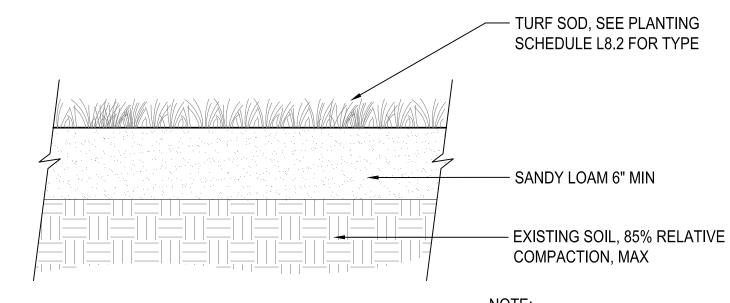


NOTE:

1. SEE SPECS FOR MORE
INFORMATION REGARDING
PLANT INSTALLATION AND
SOIL PREPARATION.

2 TURF

SCALE: 1-1/2" = 1'-0'

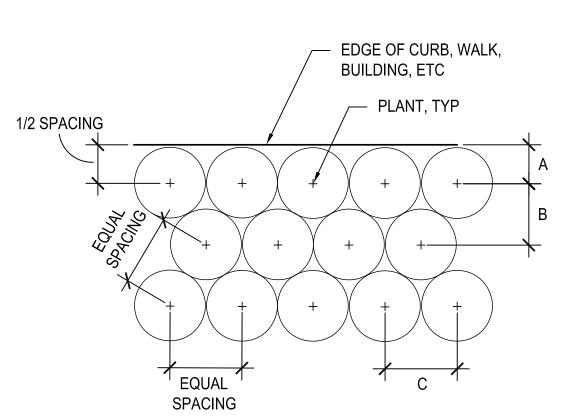

LAYOUT, U SHOWN OI			RWISE
PLANT SPACING	А	В	С
12"	6"	10"	12"
1'-6"	9"	1'-4"	1'-6"
2'-0"	12"	1'-9"	2'-0"
2'-6"	1'-3"	2'-2"	2'-6"
3'-0"	1'-6"	2'-7"	3'-0"
3'-6"	1'-9"	3'-0"	3'-6"
4'-0"	2'-0"	3'-6"	4'-0"
4'-6"	2'-3"	3'-11"	4'-6"

5'-0" 2'-6" 4'-4" 5'-0"

NOTES: 1. SEE PLANTING PLAN FOR

SPACING BY PLANT SPECIES.

2. INSTALL TRIANGULATED PLANT

3 PLANTING LAYOUT NTS



PROJECT/CLIENT NAME

# Dunphy Park Improvement Project

200 Napa Street Sausalito, CA 94965

Owner:
City of Sausalito
420 Litho St.
Sausalito, CA 94965

**RHAA PROJECT NUMBER** 

16042A

CONSULTANT

SUBMITTAL

# Permit Submittal

DATE

21 August 2017

REVISIONS

9-18-2017 Permit Plan Check Response

REGISTRATION AND SIGNATURE



PLANTING DETAILS

DRAWN BY:

**CHECKED BY:** 

L8.5

# **Irrigation Notes:**

- 1. The irrigation system to be controlled by a centrally located weather-based irrigation controller with a rain shutoff sensor.
- 2. The intent of this irrigation system is to provide the minimum amount of water required to sustain good plant health. The irrigation controller is to be programmed for seasonal weather changes, plant material water requirements, mounds and slopes, sun, shade and wind exposure.
- Turf areas to be irrigated by pop-up spray heads and rotors. New trees to be irrigated with in-line drip irrigation (drip rings). All other planting area to be installed with in-line drip irrigation.
- 4. Shoreline planting to be temporarily irrigated during plant establishment period only. Temporary irrigation to be removed after plants are established.
- 5. Refer to plans, details and specifications for irrigation system components, installation, maintenance, scheduling, and reporting requirements.
- 6. The contractor shall comply with local water district procedures & requirements, all city of requirements, and the state water efficient landscape ordinance. ordinance criteria has been applied accordingly for the efficient use of water in the irrigation design plan.
- These irrigation drawings are diagrammatic and indicative of the work to be installed. all piping, valves, and other irrigation components are to be installed within planting areas to the greatest extent possible. Due to the scale of the drawings, it is not possible to indicate all offsets, fittings, sleeves, conduit, and other items which may be required.
- 8. The contractor is to investigate the existing and proposed finished condition of the work. The contractor shall immediate notify the owner's representative of any conflicts and/or discrepancies between existing and proposed conditions which will affect the work, before proceeding with the work. in the event these notifications are not performed, the contractor assumes full responsibility for required revisions.
- 9. The contractor shall coordinate all work with other trades, including the installation of all pipe, conduit and sleeves through or under walls, roadways, paving and structures.
- 10. Prior to trenching and digging, contact usa (800-227-2600) to locate all underground utilities. the contractor shall be responsible for minor changes in the irrigation layout due to obstructions not shown on the irrigation drawings such as underground utilities, vaults, etc. The contractor shall avoid conflicts with underground utilities, new planting, site or architectural elements, and existing trees; any damage to these caused by the installation of the irrigation system shall be repaired and/or replaced at no expense to the owner.
- 11. Do not trench or install irrigation piping or equipment in lime-treated soil.
- 12. The irrigation system is designed to operate at 100 gpm, and 120 p.s.i. at the point of connection. The contractor shall verify flow rate and pressure at the point of connection prior to the installation of the irrigation system and notify the owner's representative of test results before construction begins. Notify landscape architect if pressure is greater or less than the static pressure stated on the plans to determine if pressure regulation or a booster pump is required.
- 13. The contractor shall obtain as-built irrigation drawings of all existing irrigation system(s) from the owner's representative for reference during new and retrofit
- 14. Contractor to field verify condition of all existing irrigation equipment impacted by new construction and repair and replace as necessary.
- 15. Install all irrigation equipment per manufacturer's recommendations.
- 16. Install one spare common and control wire from each controller in a continuous loop through each valve box for future use.
- 17. Where pipe sizes have been omitted or there is a conflict, refer to the lateral pipe sizing chart for sizes. As changes in layout occur during staking and construction, pipe sizes may need to be adjusted accordingly. all lateral end runs shall be 1" size unless otherwise noted.
- 18. The remote control valves specified on the drawings are pressure reducing types. set the discharge pressure as recommended by manufacturer.
- 19. Contractor to assume (4) additional control valves to be installed as needed.
- 20. Large areas of ornamental grasses are to be irrigated by a dedicated control
- 21. All irrigation boxes and lids to be black.
- **22. Non-potable irrigation note:** This system is being installed for non-potable water use. all pipe, equipment, heads, and fittings shall be color-coded and labeled for non-potable use per all applicable state and local codes.
- 23. Locate bubblers and emitters on uphill side of plant or tree.

- 24. Contractor to maintain existing planted areas throughout construction and coordinate operations to keep existing planting areas alive and healthy. Existing and new irrigation systems shall be installed, adjusted and maintained to provide 100% coverage of planting areas and to prevent misting, overspray and runoff onto buildings, walls windows, paved areas, etc.
- 25. Flush and adjust irrigation emitters, nozzles and outlets for optimum performance and to prevent over spray onto walks, roadways, and/or buildings. Select the best degree of arc and radius to fit the existing site conditions and throttle the flow control at each valve to obtain the optimum operating pressure for each control zone.
- 26. Contractor shall make final connection between electrical supply and the controller, and between the main line and water source at the point of connection(s).
- 27. The intent of this irrigation system is to provide the minimum amount of water required to sustain good plant health. It is the responsibility of the landscape maintenance contractor to program the irrigation controller(s) to provide the minimum amount of water needed to sustain good plant health. This includes making adjustments to the program for seasonal weather changes, plant material, water requirements, mounds and slopes, sun, shade and wind exposure.
- 28. The contractor shall coordinate valve numbering, controller operations and programming with owner's representative.
- 29. Station operation times shall not deliver water exceed the soil infiltration rate(s) as determined by the soils report(s).
- 30. The contractor shall provide the owner's representative with clear as-built plans of the installed of irrigation system.

#### IRRIGATION LEGEND


- WEATERTRAK ET PRO 3 2-WIRE WEATHER-BASED IRRIGATION CONTROLLER MODEL: WTPRO3-C-2W48-SPH, OR EQUAL.
- (E) IRRIGATION WATER METER (VIF NUMBER & LOCATION)
- (N) 2" BACKFLOW PROVENTION DEVICE (BY FEBCO MODEL & SIZE TBD)

---- (N) MAINLINE, SCH 40 PVC, 3" AND SMALLER

- MVI MASTER VALVE. NORMALLY OPEN. LINE SIZE WEATHERTRAK FLOW 3, OR EQUAL.
- FS FLOW SENSOR
- NOTE FLOW 3 INCLUDES FLOW METER. SEE ABOVE FOR PRODUCT
- SLEEVE: CLASS 200 PVC, SIZE AS SHOWN

NIBCO T113-IRR (LINE SIZE), OR EQUAL.

- GATE VALVE, BRASS
- QUICK COUPLING VALVE LOCKING COVER, 1-PIECE BODY,
- RAINBIRD 5-LRC, BRASS, OR EQUAL.
- REMOTE CONTROL VALVE WITH PRESSURE REGULATING SPRAY ZONES: GRISWOLD DWS-PRV, HUNTER ICV AS ADJ, OR EQUAL DRIP ZONES: HUNDER ICZ WITH FILTER, OR EQUAL.

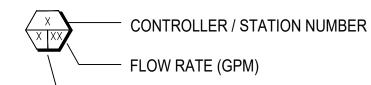

— VALVE SIZE (INCHES)

#### INLINE DRIP IRRIGATION

RAINBIRD XFS-09-12 SUB-SURFACE DRIP LINE (12" EMITTER SPACING) W/RB XFS DRIP SYSTEM OPERATION INDICATOR AT END OF EACH DRIP ZONE. LINE SPACING TO BE COORDINATED WITH PLANT SPACING (12", 18" & 24" O.C.) *INSTALL LOW FLOW BUBBLERS & IRRIGATION BERMS AT ROOTBALL OF SHRUBS SPACED GREATER THAN 24" O.C.

#### TREE WATERING SYSTEM DRIP RING AT ROOTBALL W/ 2 EMITTERS AT ROOT CROWN

POP-UP STAINLESS STEEL ROTOR W/ ADJUSTABLE ARC & CHECK VALVE MODEL I-25-04-SS BY HUNTER, OR EQUAL. SELECT NOZZLE FOR RADIUS SHOWN @ 50PSI

#### POP-UP SPRAY HEAD WITH ADJUSTABLE ARC, MATCHED PRECIPITATION RATE, CHECK VALVE & PRESSURE REGULATION. MODEL PROS-04-PRS40-CV-MP1000/2000/3000 BY HUNTER, OR EQUAL. SELECT NOZZLE FOR RADIUS SHOWN @40PSI.

TEMPORARY IRRIGATION FOR PLANT ESTABLISHMENT ONLY.

CLASS 200 PVC LATER	RAL LINE SI	ZING	TYPICAL VALVE SIZING
0 - 6 GPM: 0.75"	29 - 45	GPM: 2.0"	00 - 25 GPM: 1.0" VALVE
7 - 12 GPM: 1.0"	46 - 65	GPM: 2.5"	26 - 35 GPM: 1.25"
13 - 28 GPM: 1.5"	66 - 100	GPM: 3.0"	36 - 50 GPM: 1.5"
			51 - 100 GPM: 2"

## Maximum Applied Water Allowance Enter Zip Code 94965 26.33 Residential? No 200 Napa St, Sausalito, CA 94965 Location/Sheet No. Corner of Napa St & Bridgeway, L1.0 & L9.1 Maximum Applied Water Allowance (MAWA) 97,745 sqft Landscaped Area: Special Landscaped Area: 97,745 sqft 2,133 CCF Estimated Total Water Use (ETWU) 33,035 sqft Low water use plant 6,265 sqft Moderate water use plant **58,445** so High water use plant 0.75 Efficiency Factor % of Total Landscape Water Use Table ETWU Gallons: 1,569,304 CCF's: 2,098 AF: 4.82 Baseline Period Jan/Feb Mar/Apr May/Jun Jul/Aug Sep/Oct Nov/Dec Baseline CCF's 13 233 573 671 479 129 1 CCF = 748 Gallons; 1 AF = 435.6 CCF's For more information please contact 415-945-1497 or see our website at www.marinwater.org

#### Hydrozone Table

This worksheet is filled out by the project applicant and it is a required element of the Landscape Documentation Package. Please complete the hydrozone table(s) for each hydrozone. Use as many tables as necessary to provide the square footage of landscape area per hydrozone.

Zone or Valve	Hydrozone*	Irrigation Method**	Gallons Per Minute	Area (sq. ft.)
VALVE 1	MW	D	22.5	3250
VALVE 2	MW	В	5	50
VALVE 3	MW	D	9.9	1485
VALVE 4	MW	В	6	50
VALVE 5	MW	В	4	40
VALVE 6	MW	D	10.4	1320
VALVE 7	LW	D	15.1	2160
VALVE 8	LW	В	5	50
VALVE 9	HW	S	22.8	6950
VALVE 10	LW	D	2.5	315
VALVE 11	LW	D	6.7	930
VALVE 12	LW	В	4	40
VALVES	HW	S	150.9	43005
13-16, 20, 24				
VALVE 17	LW	D	6.9	950
VALVE 18	LW	D	13.4	2000
VALVE 19	MW	В	7	70
VALVE 21	LW	D	15.1	2250

			Total	97,745
VALVE 34	LW	В	10	100
VALVE 33	LW	D	27.7	3990
VALVE 32	LW	D	43	6450
VALVE 31	LW	D	28.1	4200
VALVE 30	LW	D	41	6200
VALVE 29	LW	В	7	70
VALVE 28	LW	D	21.2	3170
VALVE 26	LW	В	4	40
VALVE 25	LW	В	5	50
23, 27				
VALVES	HW	S	26	8500
VALVE 22	LW	В	6	60

Summary Hydrozone Table				
Hydrozone		Area (s	q. ft.)	
High Water Use		58,445		
Moderate Water Use		6,265		
Low Water Use		33,035		
Total		97,745		

^{*}HW=High Water Use Plants; MW=Moderate Water Use Plants; LW=Low Water Use Plants **MS=Micro-spray; S=Spray; R=Rotor; B=Bubbler; D=Drip; O=Other

225 Miller Avenue, Mill Valley, CA 94941

T 415 383 7900 F 415 383 1433 www.rhaa.com

**Improvement Project** 

PROJECT/CLIENT NAME

**Dunphy Park** 

200 Napa Street

City of Sausalito

Sausalito, CA 94965

RHAA PROJECT NUMBER

420 Litho St.

16042A

**CONSULTANT** 

**SUBMITTAL** 

**REVISIONS** 

Permit Submittal

21 August 2017

9-18-2017 Permit Plan Check Response


Owner:

Sausalito, CA 94965

SHEET TITLE **IRRIGATION** NOTES

**CHECKED BY:** 

**REGISTRATION AND SIGNATURE** 

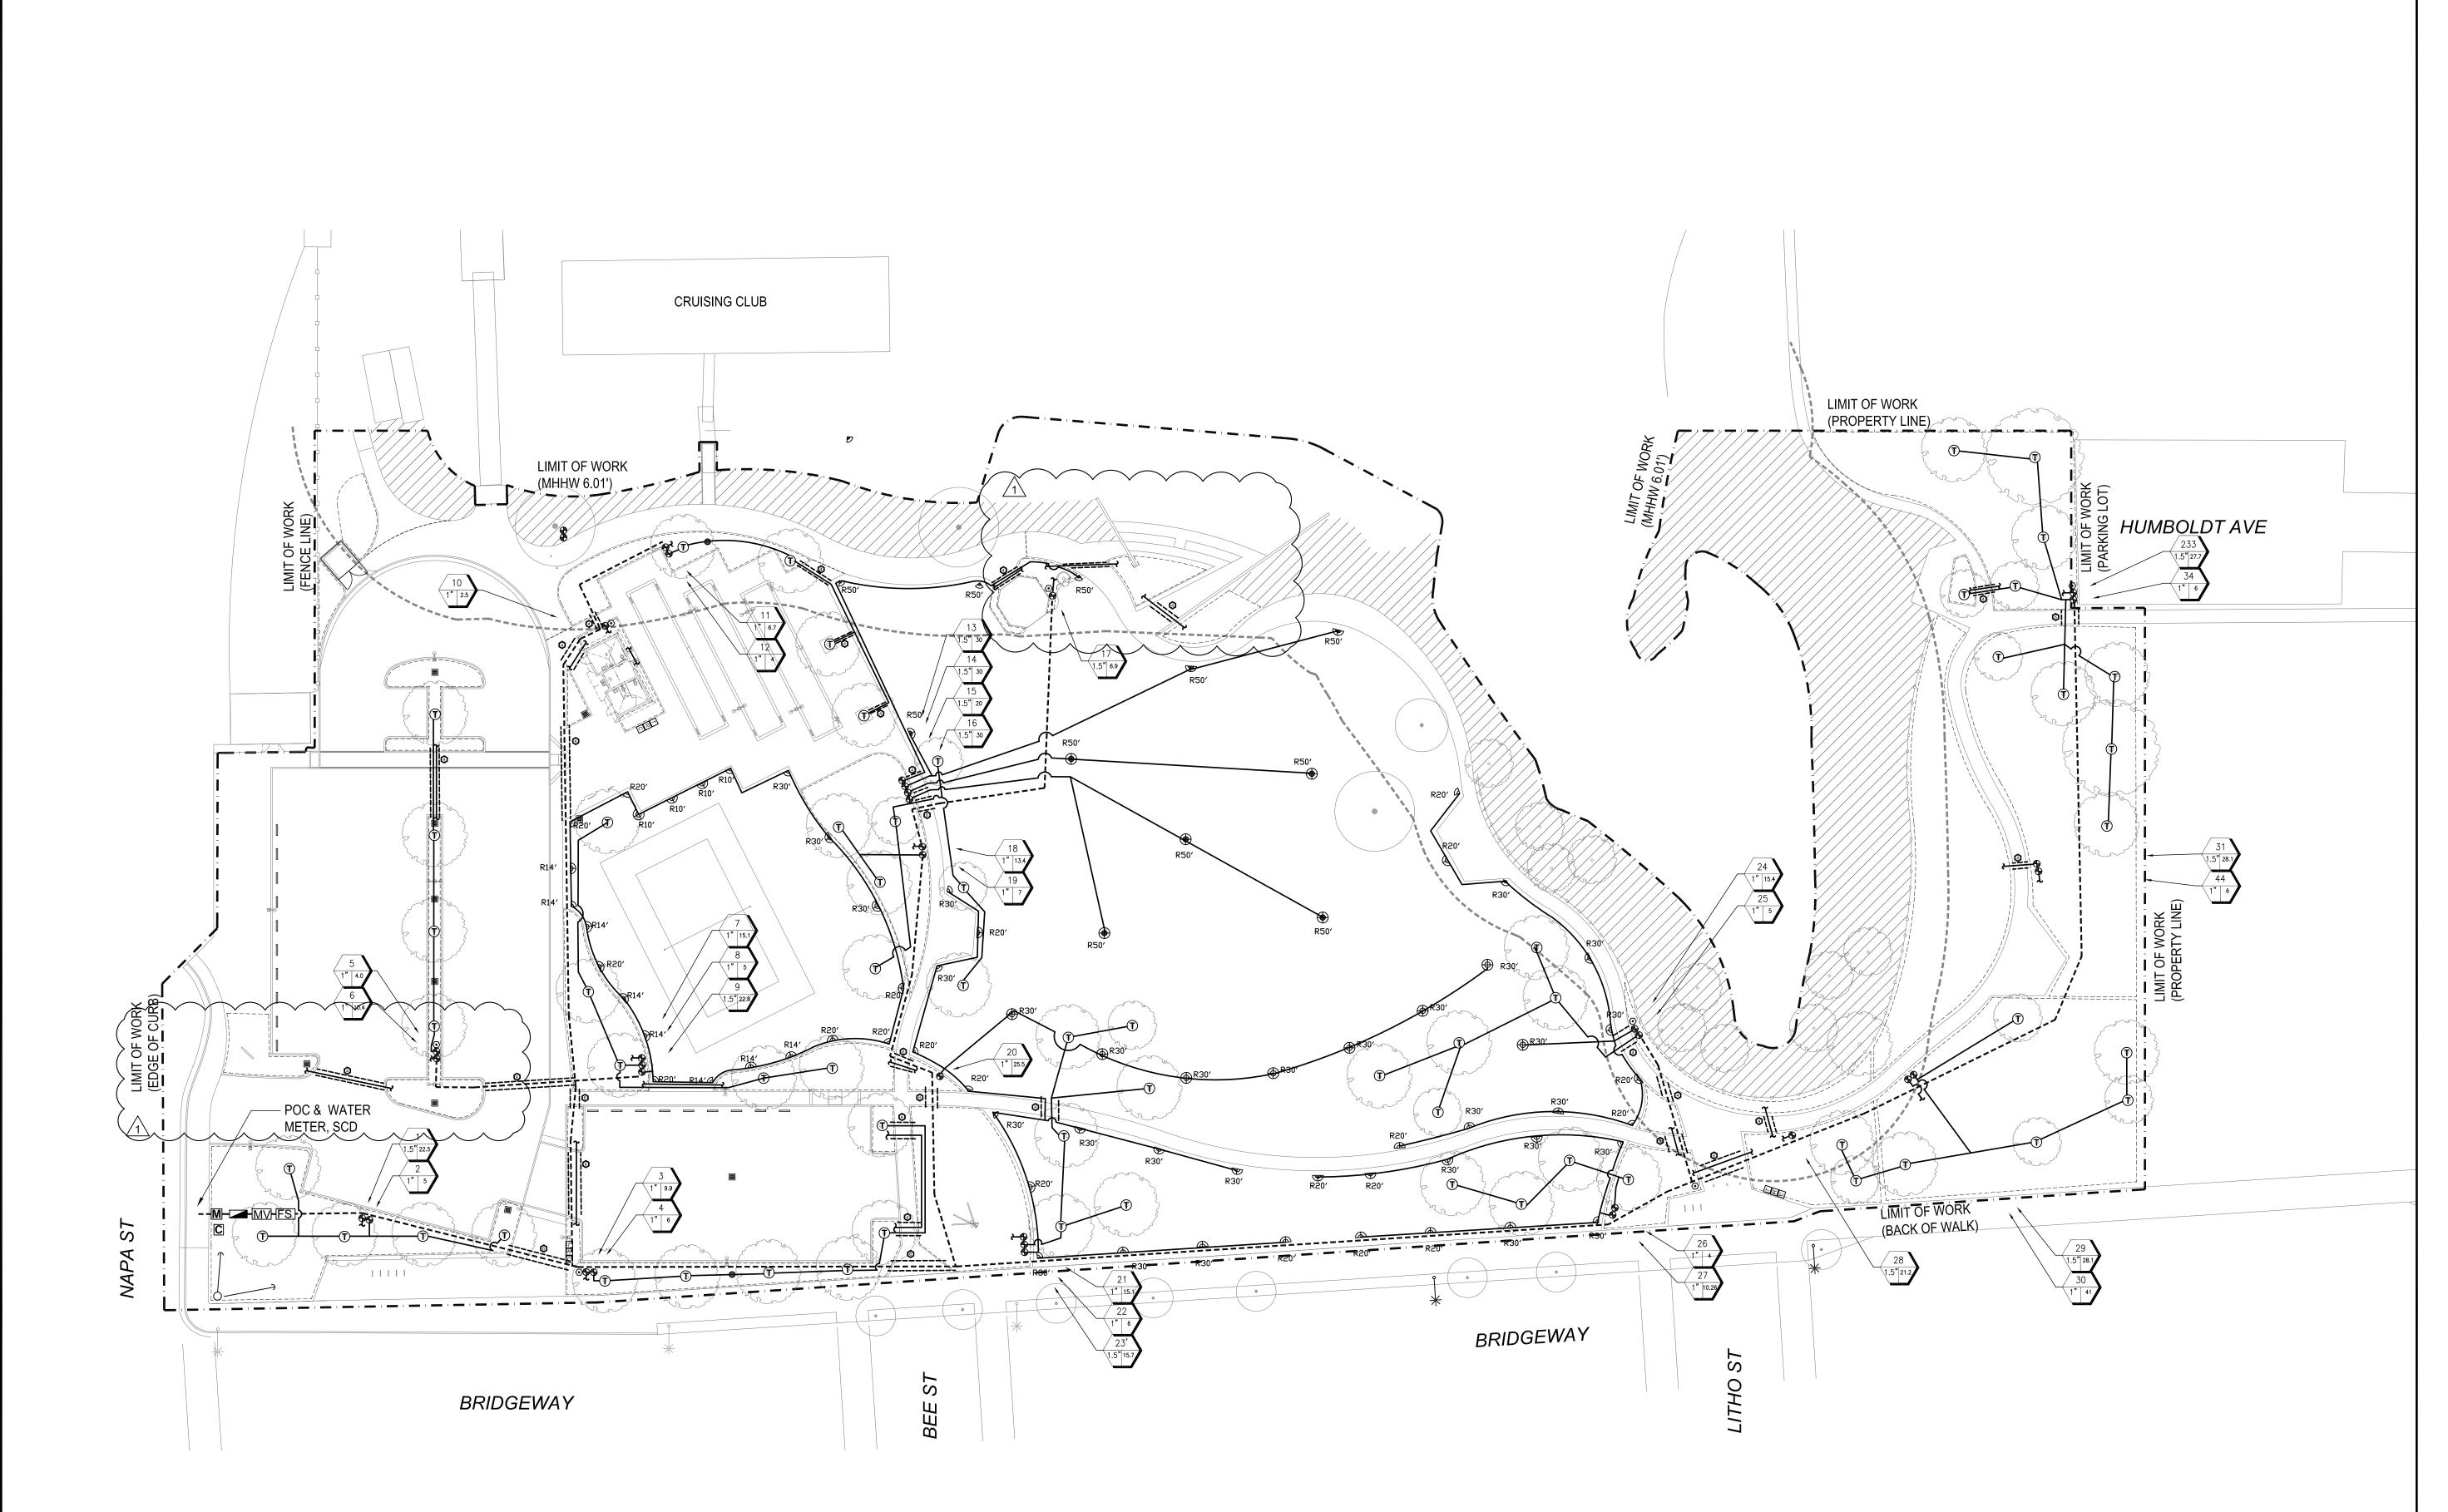



PROJECT/CLIENT NAME

# Dunphy Park Improvement Project

200 Napa Street Sausalito, CA 94965

Owner: City of Sausalito 420 Litho St. Sausalito, CA 94965

RHAA PROJECT NUMBER

16042A

CONSULTANT

SUBMITTAL

# Permit Submittal

DATE

21 August 2017

**REVISIONS** 


9-18-2017 Permit Plan Check Response

REGISTRATION AND SIGNATURE



**SCALE** 1" = 30'

E 0'-0" 15' 30' 6

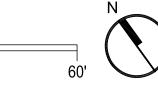


SHEET TITLE

IRRIGATION PLAN


DRAWN BY:

CHECKED BY:


£19.1

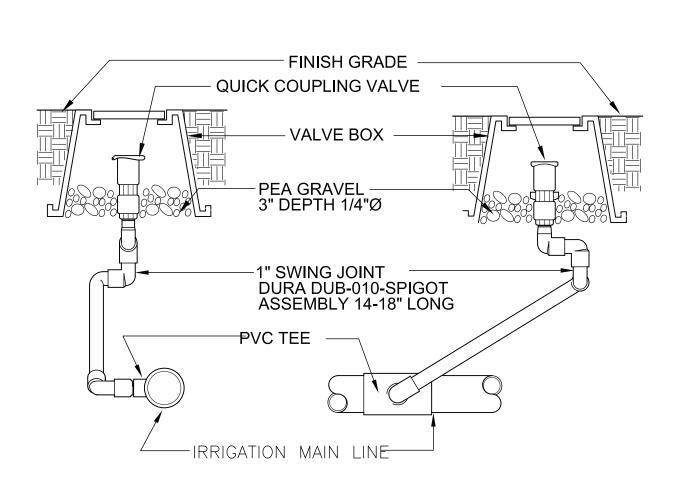




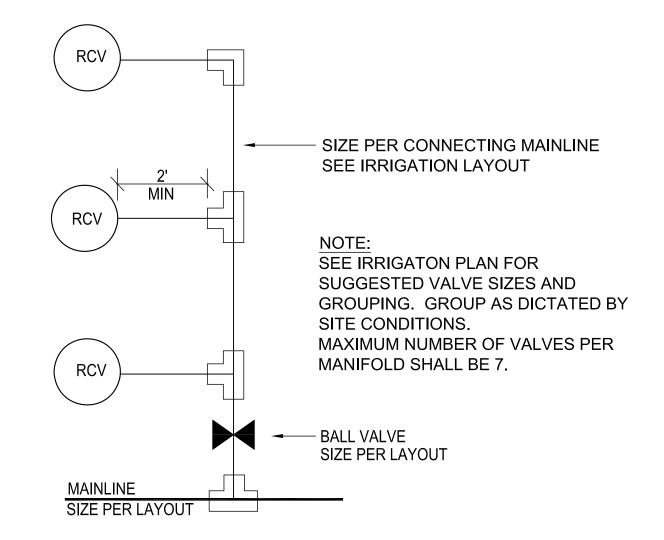


REMOTE CONTROL VALVES - CONNECTION

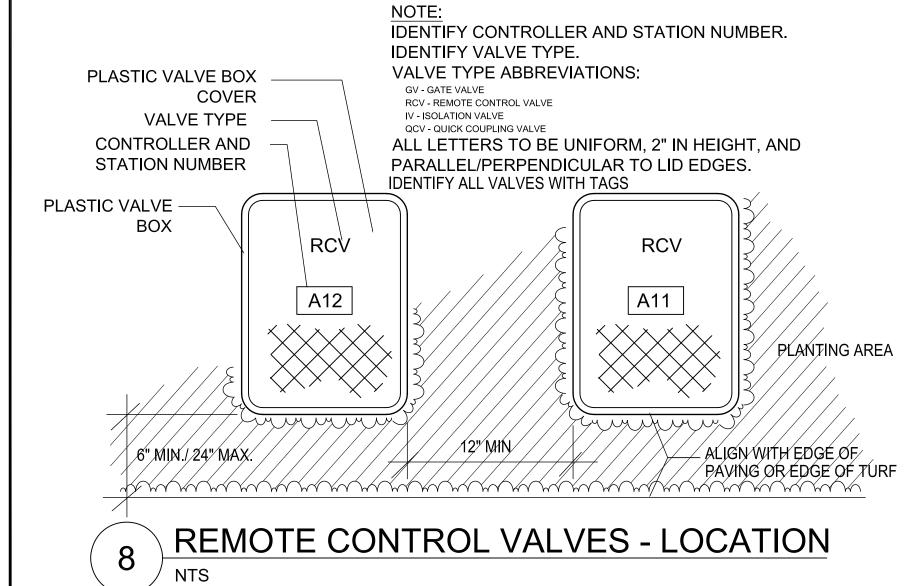


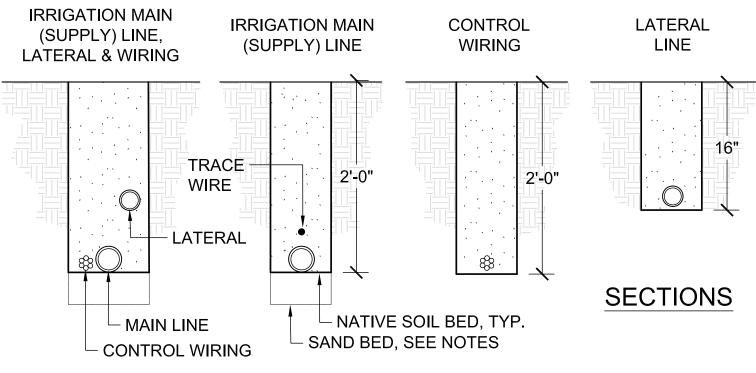


- 1. LAY IRRIGATION SUPPLY LINE ON NATIVE SOIL BED UNLESS SAND BED IS SPECIFIED

**IRRIGATION TRENCHING** 3 NTS

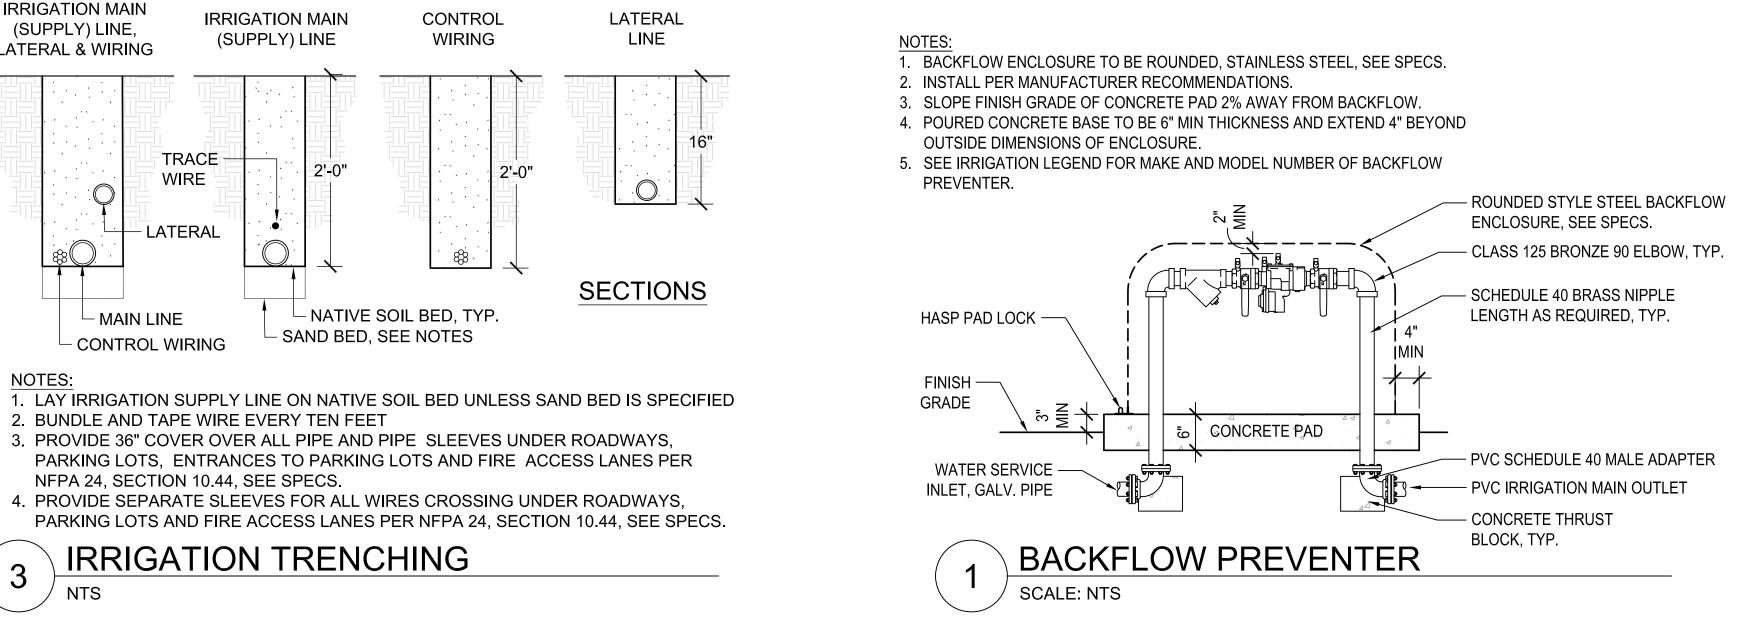


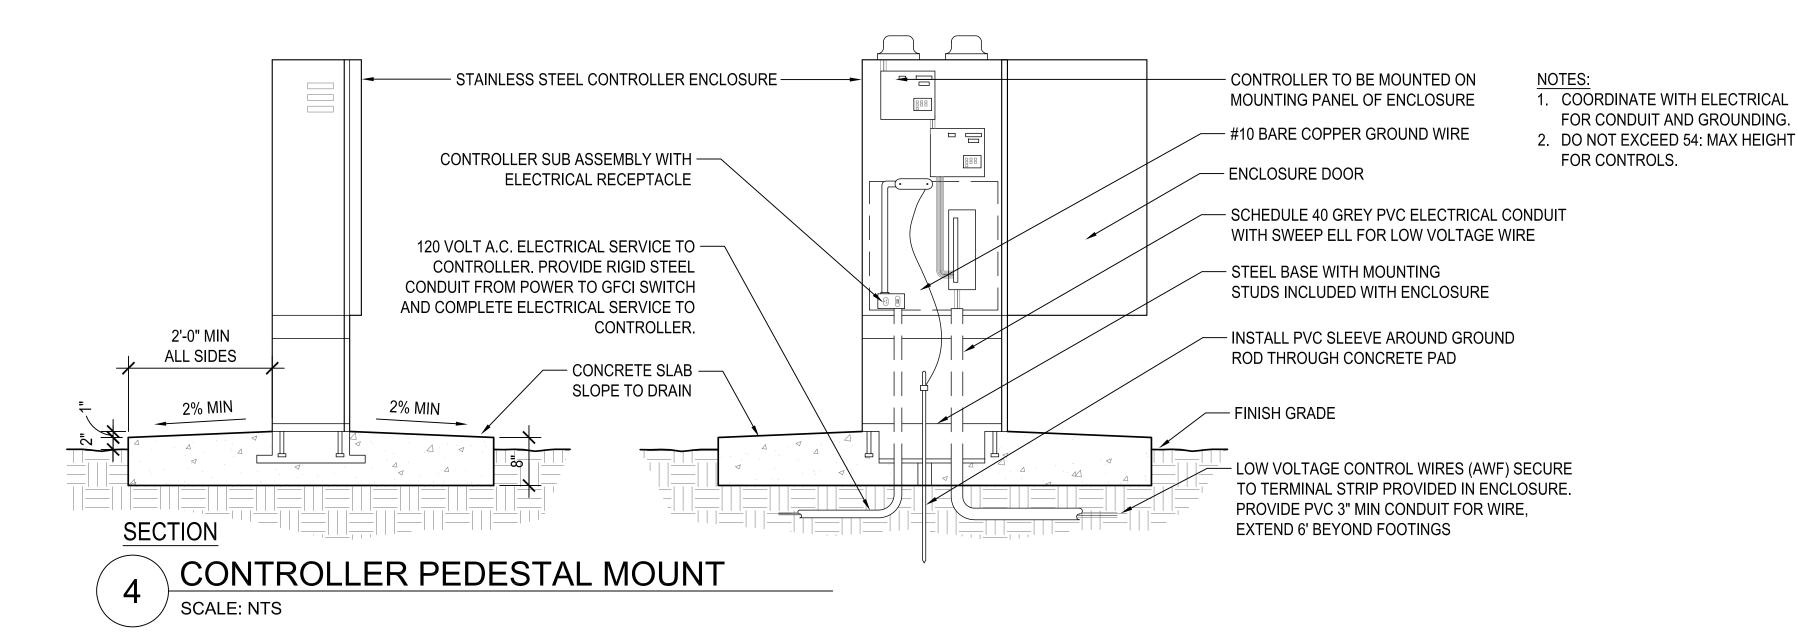

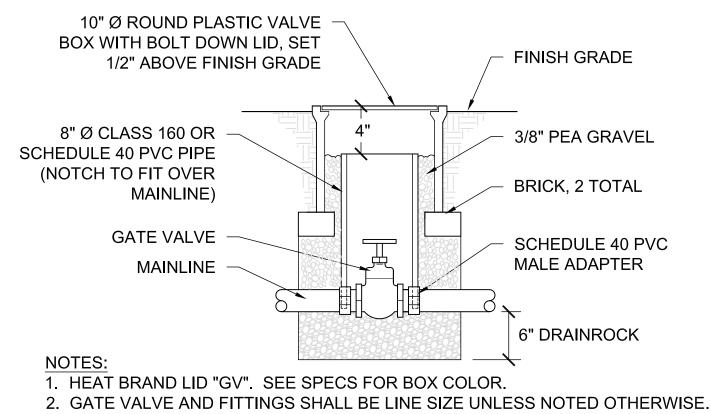

3. USE TEFLON TAPE ON ALL THREADED FITTINGS.

**GATE VALVE** 

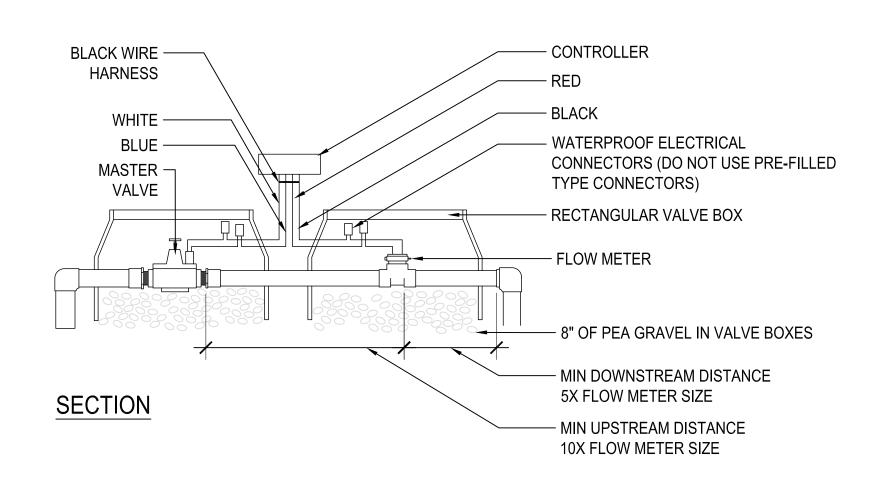

MASTER VALVE & FLOW METER SCALE: NTS

# 225 Miller Avenue, Mill Valley, CA 94941

T 415 383 7900 F 415 383 1433 www.rhaa.com

PROJECT/CLIENT NAME

# **Dunphy Park** Improvement Project

200 Napa Street Sausalito, CA 94965

Owner: City of Sausalito 420 Litho St. Sausalito, CA 94965

RHAA PROJECT NUMBER

16042A

CONSULTANT

SUBMITTAL

Permit Submittal

DATE

21 August 2017

REVISIONS


/1\ 9-18-2017 Permit Plan Check Response

**REGISTRATION AND SIGNATURE** 



SHEET TITLE **IRRIGATION DETAILS** 

DRAWN BY:

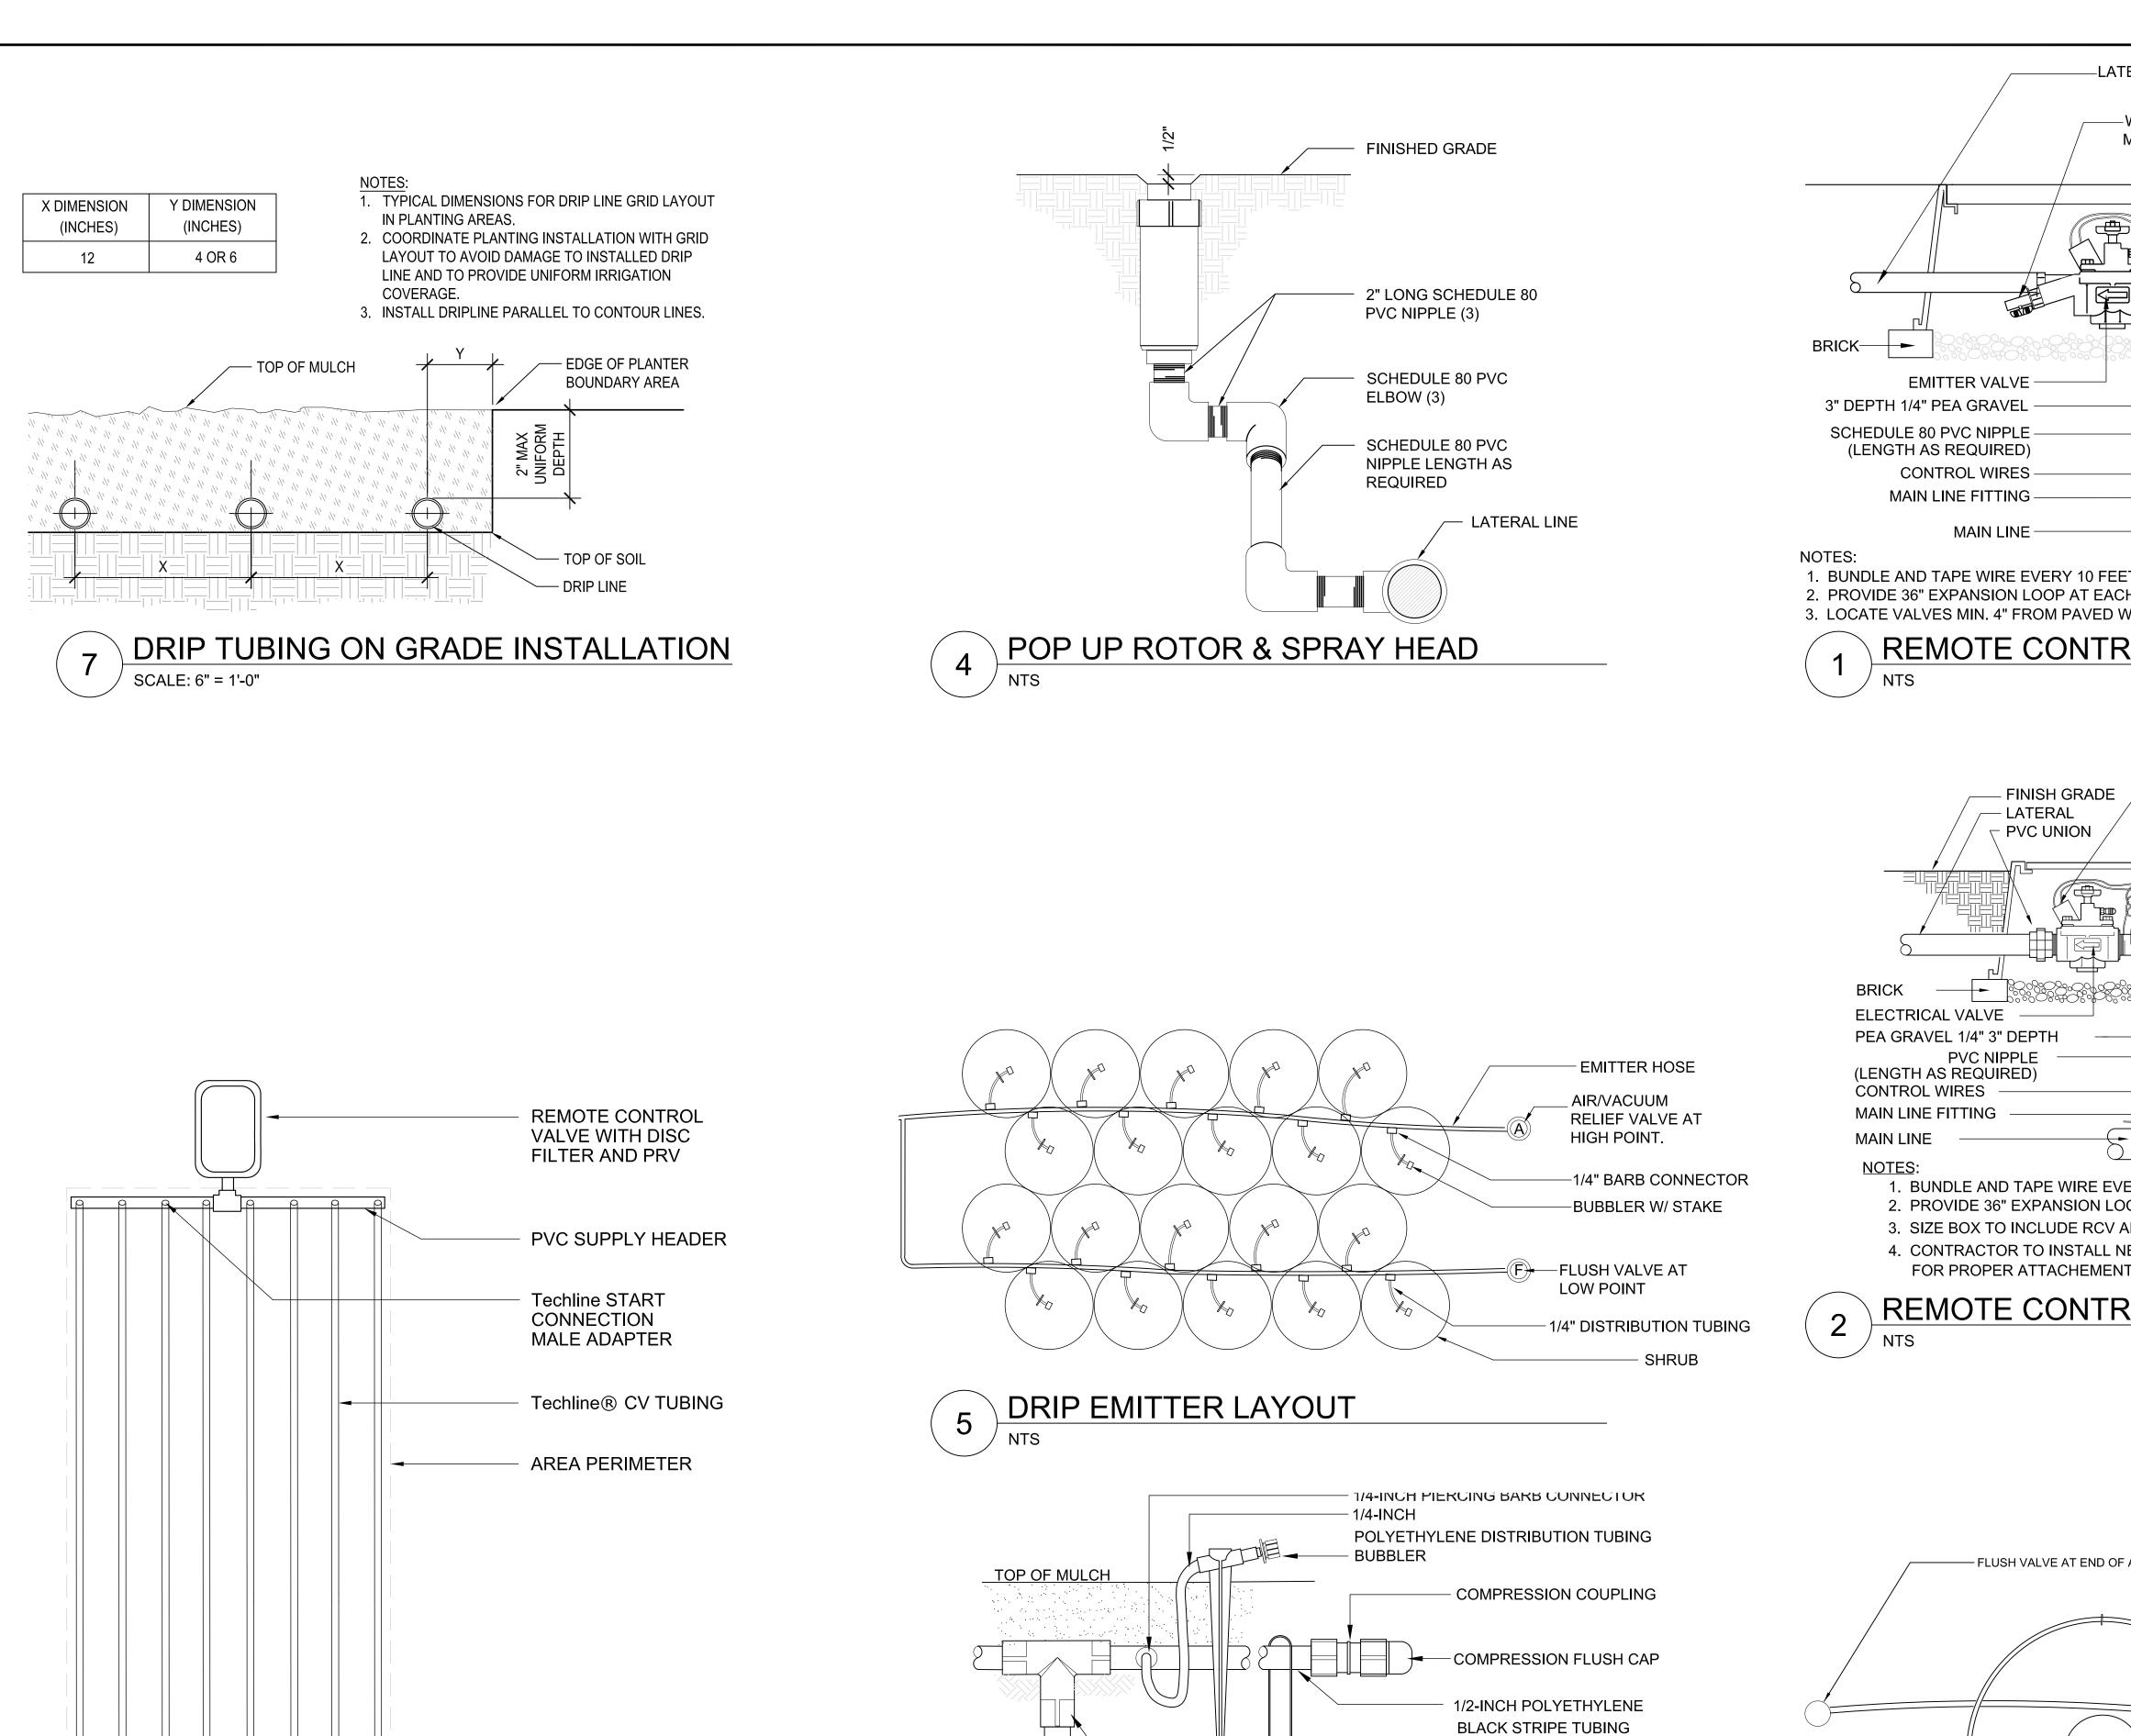

PVC EXHAUST HEADER


PERIMETER LATERALS

MANUAL LINE FLUSHING VALVE

4"-6" FROM EDGE

PLUMBED TO PVC

IN LINE DRIP LAYOUT

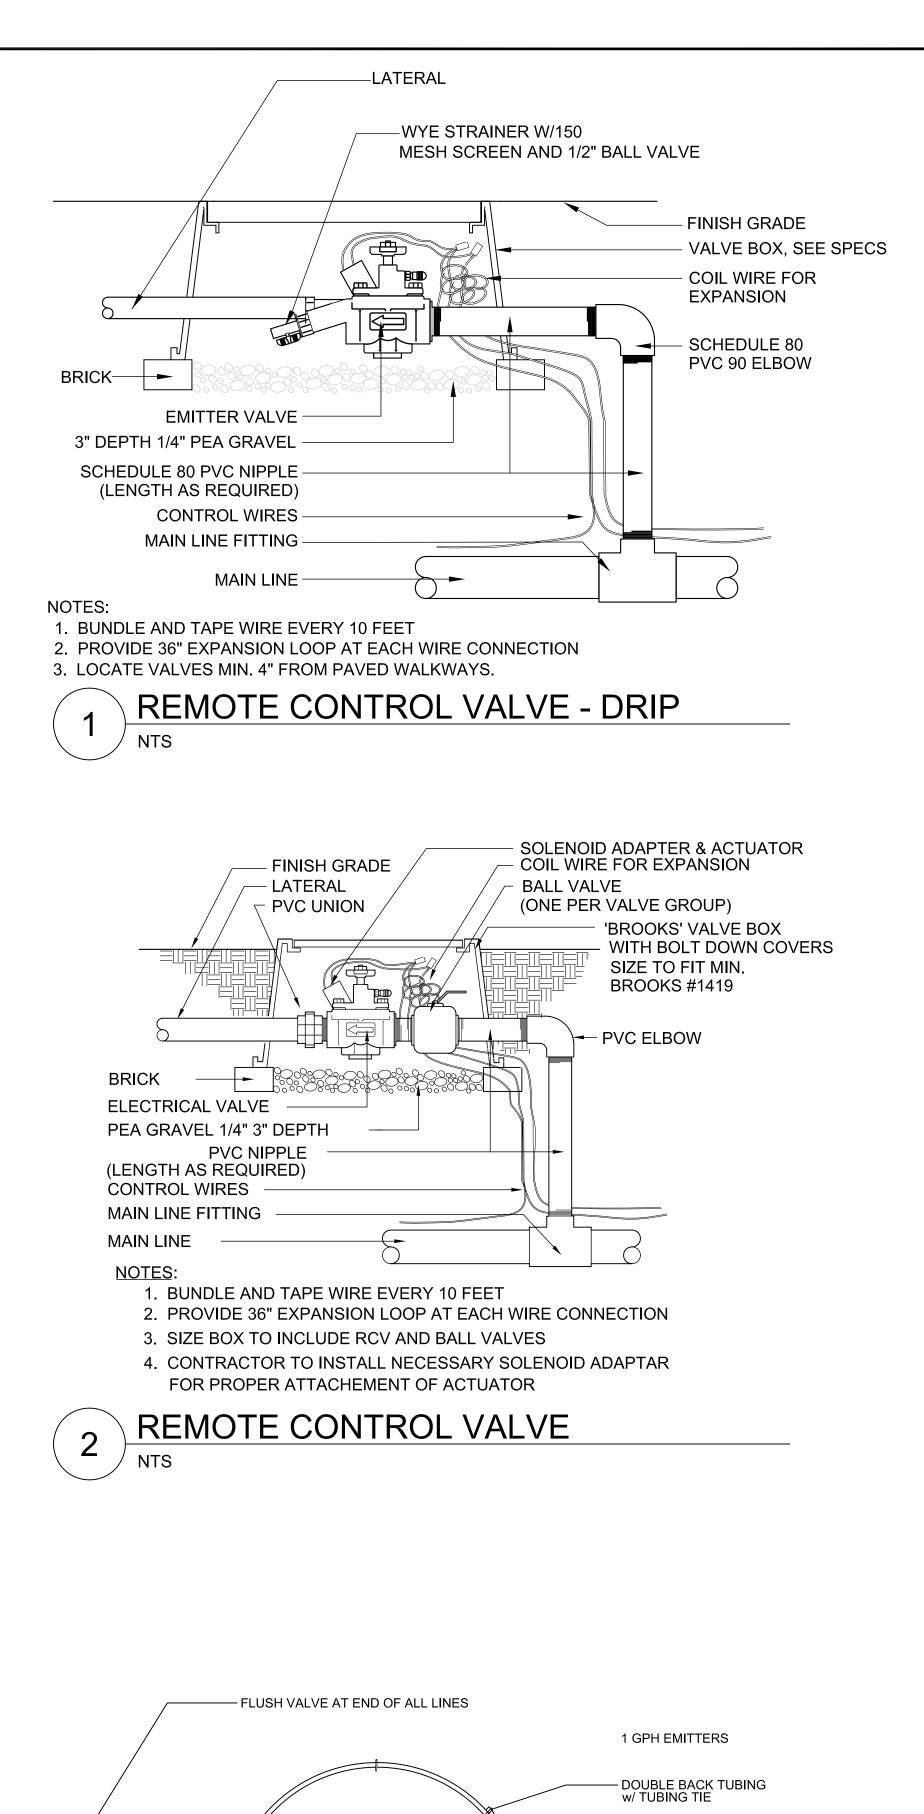



PROJECT/CLIENT NAME

# **Dunphy Park Improvement Project**

200 Napa Street Sausalito, CA 94965

Owner: City of Sausalito 420 Litho St. Sausalito, CA 94965

RHAA PROJECT NUMBER

16042A

CONSULTANT

SUBMITTAL

# Permit Submittal

DATE

21 August 2017

**REVISIONS** 

9-18-2017 Permit Plan Check Response


**REGISTRATION AND SIGNATURE** 



SHEET TITLE **IRRIGATION DETAILS** 

DRAWN BY:

**CHECKED BY:** 

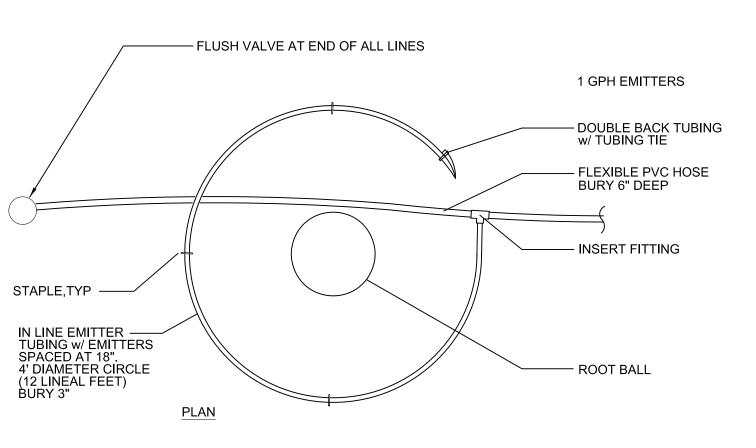

TREE DRIP RING IRRIGATION

TIE-DOWN STAKE:

COMPRESSION TEE

PVC LATERAL PIPE


PVC FITTING

DRIP EMITTER CONNECTION

**COMPRESSION ADAPTER** 

PVC NIPPLE LENGTH AS REQUIRED

- 1/4-INCH TUBING STAKE

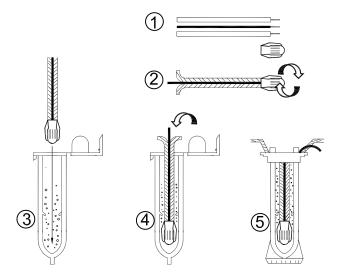



#### NOTES

- 1. STRIP WIRES APPROXIMATELY 1/2" (12.7 MM) TO EXPOSE WIRE.
- 2. TWIST CONNECTOR AROUND WIRES CLOCKWISE UNTIL HAND TIGHT, DO NOT OVERTIGHTEN.
- 3. INSERT WIRE ASSEMBLY INTO PLASTIC TUBE UNTIL WIRE CONNECTOR SNAPS PAST LIP IN BOTTOM OF TUBE.
- 4. PLACE WIRES WHICH EXIT TUBE IN WIRE EXIT HOLES AND CLOSE CAP UNTIL IT
- 5. INSPECT FINAL SPLICE ASSEMBLY TO BE SECURE AND FINISHED.

WATERPROOF WIRE CONNECTION


T / NTS

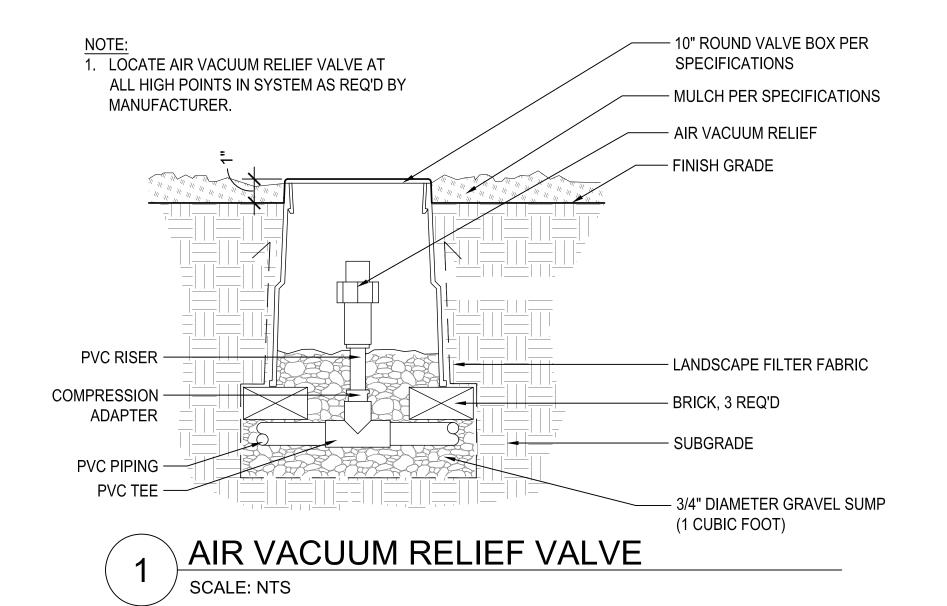

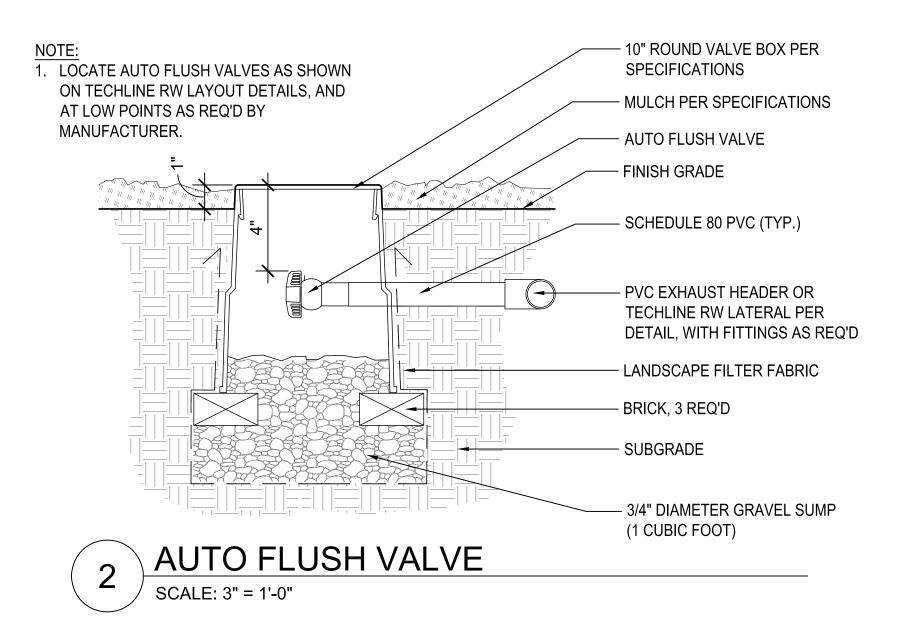

NOTE:

1. LOCATE INDICATOR AT THE FARTHEST
AND/OR HIGHEST POINT ON THE ZONE.

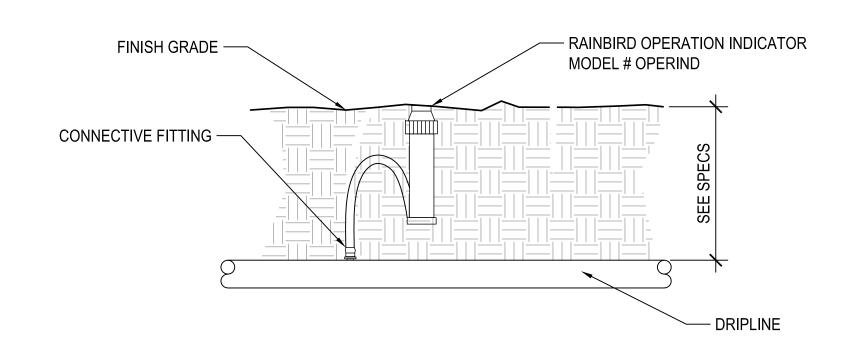





PROJECT/CLIENT NAME

# Dunphy Park Improvement Project

200 Napa Street Sausalito, CA 94965

Owner:
City of Sausalito
420 Litho St.
Sausalito, CA 94965

RHAA PROJECT NUMBER

16042A

CONSULTANT

SUBMITTAL

Permit Submittal

DATE

21 August 2017

**REVISIONS** 

No. Date Description

9-18-2017 Permit Plan Check Response

REGISTRATION AND SIGNATURE



SHEET TITLE
IRRIGATION
DETAILS

DRAWN BY:

CHECKED BY:

L9.4

# DUNPHYPARK

# SAUSALITO, CALIFORNIA

#### GENERAL NOTES

- 1. THE DESIGN SHOWN IN THESE DOCUMENTS WAS BASED ON THE FOLLOWING:
- A. CITY OF SAUSALITO CODE ORDINANCES. B. ALL GUIDELINES AS SET FORTH BY THE GEOTECHNICAL STUDY REPORT: DUNPHY PARK IMPROVEMENTS BY RGH CONSULTANTS, DATED JUN 9, 2015, ADDENDUM NO. 1, DATED
- C. THE GEOTECHNICAL REPORT SHALL BE INCLUDED AS PART OF THE WORKING DOCUMENTS AND THE CONTRACTOR SHALL FOLLOW ALL RECOMMENDATIONS OF THIS REPORT. D. REQUIREMENTS OF ALL PERMITS APPLICABLE TO THIS PROJECT.
- TOPOGRAPHIC BASE SURVEY AS ILLUSTRATED ON THESE PLANS BY LINDA A. CARRUTHERS & ASSOCIATES, DATED DECEMBER 9, 2013 AND REVISED JUNE 15, 2017.
- THE SUBSURFACE OF THE CONSTRUCTION SITE MAY BE SENSITIVE FOR PALEONTOLOGICAL RESOURCES. IF PALEONTOLOGICAL RESOURCES ARE ENCOUNTERED DURING PROJECT SUBSURFACE CONSTRUCTION, ALL GROUND-DISTURBING ACTIVITIES WITHIN 50 FEET SHALL BE REDIRECTED AND THE COMMUNITY DEVELOPMENT AGENCY, PLANNING DIVISION SHALL BE CONTACTED, AS WELL AS OTHER CONSULTING AGENCIES AS APPROPRIATE, AND A QUALIFIED PALEONTOLOGIST TO ASSESS THE SITUATION, AND MAKE RECOMMENDATIONS FOR THE TREATMENT OF THE DISCOVERY. PROJECT PERSONNEL SHALL NOT COLLECT OR MOVE ANY PALEONTOLOGICAL MATERIALS. PALEONTOLOGICAL RESOURCES INCLUDE FOSSIL PLANTS AND ANIMALS, AND SUCH TRACE FOSSIL EVIDENCE OF PAST LIFE AS TRACKS. ANCIENT MARINE SEDIMENTS MAY CONTAIN INVERTEBRATE FOSSILS SUCH AS SNAILS, CLAM AND OYSTER SHELLS, SPONGES, AND PROTOZOA, AND VERTEBRATE FOSSILS SUCH AS FISH, WHALE, AND SEA LION BONES. VERTEBRATE LAND MAMMALS MAY INCLUDE BONES OF MAMMOTH, CAMEL, SABER-TOOTH CAT, HORSE, AND BISON. PALEONTOLOGICAL RESOURCES ALSO INCLUDE PLANT IMPRINTS, PETRIFIED WOOD, AND ANIMAL TRACKS.
- IF HUMAN REMAINS ARE ENCOUNTERED DURING PROJECT ACTIVITIES, WORK WITHIN 50 FEET OF THE DISCOVERY SHALL BE REDIRECTED AND THE TOWN CORONER NOTIFIED IMMEDIATELY. AT THE SAME TIME, AN ARCHAEOLOGIST SHALL BE CONTACTED TO ASSESS THE SITUATION AND CONSULT WITH AGENCIES AS APPROPRIATE. PROJECT PERSONNEL SHALL NOT COLLECT OR MOVE ANY HUMAN REMAINS AND ASSOCIATED MATERIALS. IF THE HUMAN REMAINS ARE OF NATIVE AMERICAN ORIGIN, THE CORONER MUST NOTIFY THE NATIVE AMERICAN HERITAGE COMMISSION WITHIN 24 HOURS OF THIS IDENTIFICATION. THE NATIVE AMERICAN HERITAGE COMMISSION WILL IDENTIFY A MOST LIKELY DESCENDANT (MLD) TO INSPECT THE SITE AND PROVIDE RECOMMENDATIONS FOR THE PROPER TREATMENT OF THE REMAINS AND
- IMPROVEMENTS WITHIN THE PUBLIC RIGHT OF WAY SHALL CONFORM TO THE CITIES AND COUNTY OF MARIN "UNIFORM CONSTRUCTION STANDARDS."

# CITY OF SAUSALITO RICHARD'S BAY

# LOCATION MAP

NTS

#### **GRADING NOTES**

- 1. ALL GRADING AND DRAINAGE TO COMPLY WITH RECOMMENDATIONS IN SOILS REPORT ENTITLED "GEOTECHNICAL STUDY REPORT: DUNPHY PARK IMPROVEMENTS", BY RGH CONSULTANTS. DATED: JUNE 9, 2015.
- 2. ALL GRADING SHALL CONFORM WITH THE CITY OF SAUSALITO CODE ORDINANCES.
- 3. THE CONTRACTOR OR ANY SUBCONTRACTOR SHALL NOTIFY UNDERGROUND SERVICE ALERT ONE CALL PROGRAM 48 HOURS IN ADVANCE OF PERFORMING EXCAVATION WORK BY CALLING THE TOLL-FREE NUMBER 800-227-2600. EXCAVATION IS BEING 18 OR MORE INCHES IN DEPTH BELOW THE EXISTING GROUND.
- ACTUAL GRADING SHALL BEGIN WITHIN 30 DAYS OF VEGETATION REMOVAL OR THE AREA SHALL BE PLANTED TO CONTROL EROSION. SURFACE PLANT GROWTH ONLY, WHICH DOES NOT EXCEED 4 INCHES IN DEPTH.
- CONTRACTOR SHALL NOTIFY THE CITY 48 HOURS PRIOR TO THE INTENTION TO COMMENCE
- A COPY OF ALL COMPACTION TESTS AND FINAL GRADING REPORT SHALL BE SUBMITTED TO THE CITY PRIOR TO SCHEDULING ANY INSPECTIONS.
- PERMANENT CUT AND FILL SLOPES SHALL BE NO STEEPER THAN TWO HORIZONTAL TO ONE VERTICAL (2H:1V) PER GEOTECHNICAL ENGINEER'S REPORT. TEMPORARY CUT SLOPES SHALL BE REVIEWED AND APPROVED BY GEOTECHNICAL ENGINEER.
- PROVIDE 5 FT OF 2% MINIMUM SLOPE FOR PAVED AREAS, 48 MINIMUM SLOPE FOR SOFTSCAPE AREAS AWAY FROM BUILDINGS ON ALL SIDES PER GEOTECH REPORT UNLESS
- 9. SOIL COMPACTION SHALL BE AS NOTED IN THE GEOTECHNICAL REPORT.
- 10. THE CONTRACTOR AGREES THAT IN ACCORDANCE WITH GENERALLY ACCEPTED CONSTRUCTION PRACTICES, CONSTRUCTION CONTRACTOR WILL BE REQUIRED TO ASSUME SOLE AND COMPLETE RESPONSIBILITY FOR THE JOB SITE CONDITIONS DURING THE COURSE OF CONSTRUCTION OF THE PROJECT, INCLUDING SAFETY OF ALL PERSONS AND PROPERTY, THAT THIS REQUIREMENT SHALL BE MADE TO APPLY CONTINUOUSLY AND NOT BE LIMITED TO NORMAL WORKING HOURS.
- 11. TREE PROTECTION FENCING SHALL BE INSTALLED IN ACCORDANCE WITH PROJECT SCOPE PRIOR TO CONSTRUCTION. SEE LANDSCAPE PLAN.
- 12. GRADING OR ANY OTHER OPERATION THAT CREATES DUST SHALL BE STOPPED IMMEDIATELY IF DUST AFFECTS ADJACENT PROPERTIES. MUD TRACKED ONTO ONTO STREETS OR ADJACENT PROPERTIES SHALL BE REMOVED IMMEDIATELY AS DIRECTED BY A TOWN INSPECTOR.
- THIS PLAN REFERENCES AN EXISTING TOPOGRAPHIC SURVEY PREPARED BY LINDA A. CARRUTHERS & ASSOCIATES, DATED DECEMBER 9, 2013. THE CONTRACTOR IS RESPONSIBLE FOR VERIFICATION OF EXISTING TOPOGRAPHICAL INFORMATION PRIOR TO COMMENCEMENT OF ANY CONSTRUCTION.
- $\sim$ CONTRACTOR TO DEVELOP CONSTRUCTION PHASING AND ACCESS PLAN TO ENSURE VEHICULAR TRAFFIC DOES NOT CAUSE OVERCOMPACTION OF SUBGRADES AT PROPOSED PREVIOUS PAVEMENT AREAS. CONTRACTOR TO CONDUCT COMPACTION TESTING OF FINISHED SUBGRADES WITHIN ALL PREVIOUS PAVEMENT AREAS PRIOR TO PLACING PAVING MATERIAL AND PROVIDE PASSING RESULTS TO CIVIL ENGINEER FOR APPROVAL.

#### SURVEY NOTES

- 1. THE BASIS OF BEARINGS FOR THIS SURVEY IS NORTH 58°39'36" WEST BETWEEN FOUND STD. CITY MONUMENTS ON BRIDGEWAY AS SHOWN HEREON.
- 2. THE BENCHMARK USED FOR THIS SURVEY IS A 2.5" BRASS DISK SET IN THE CENTER LINE ISLAND OF NAPA STREET AND BRIDGEWAY. HAVING AN ELEVATION OF 13,67 FEET NAVD 1988.
- THE TYPES, LOCATIONS, SIZES AND/OR DEPTHS OF EXISTING UNDERGROUND UTILITIES AS SHOWN THE TOPOGRAPHICAL SURVEY ARE APPROXIMATE AND OBTAINED FROM SOURCES OF VARYING RELIABILITY. ONLY ACTUAL EXCAVATION WILL REVEAL THE TYPES, EXTENT, SIZES, LOCATIONS, AND DEPTHS OF SUCH UNDERGROUND UTILITIES. A REASONABLE EFFORT HAS BEEN MADE TO LOCATE AND DELINEATE ALL KNOWN UNDERGROUND UTILITIES. HOWEVER, THE ENGINEER CAN ASSUME NO RESPONSIBILITY FOR THE OCMPLETENESS OR ACCURACY OF ITS DELINEATION OF SUCH UNDERGROUND UTILITIES WHICH MAY BE ENCOUNTERED, BUT WHICH ARE NOT SHOWN ON THIS SURVEY.
- THE CONTRACTOR AND/OR OWNER SHALL PROVIDE ALL SURVEYING AND STAKING NECESSARY FOR THE ENTIRE PROJECT.
- AFTER ALL PERMITS ARE OBTAINED, THE CIVIL ENGINEER WILL PROVIDE THE CONTRACTOR WITH DIGITAL FILES OF LAYOUT PLANS FOR STAKING PURPOSES.

#### UTILITY NOTES

- AVAILABLE INFORMATION CONCERNING THE EXTENT AND LOCATION OF EXISTING UTILITIES IS SHOWN ON THE PLAN, BUT CONTRACTOR IS CAUTIONED IT DOES NOT NECESSARILY REPRESENT ACTUAL UTILITY LOCATIONS SIZES OR MATERIALS. IT IS THE CONTRACTOR'S RESPONSIBILITY TO VERIFY THE LOCATION OF ALL EXISTING UTILITIES, INCLUDING BUT NOT LIMITED TO, WATER, SEWER, ELECTRIC, COMMUNICATIONS, GAS, AND STORM DRAIN, PRIOR TO COMMENCING EXCAVATION OR BELOW GRADE DEMOLITION.
- A. CONTACT UNDERGROUND UTILITY LOCATOR TO HAVE UTILITIES LOCATED AND MARKED NOT LESS THAN 2 WORKING DAYS, AND NOT MORE THAN 14 WORKING DAYS PRIOR TO EXCAVATION. B. AS NOTED ON THE PLANS, POTHOLING MAY BE REQUIRED IN SOME AREAS TO CONFIRM THAT MINIMUM REQUIRED VERTICAL CLEARANCES CAN BE ACHIEVED.
- 2. PIPE MATERIALS AND METHODS OF INSTALLATION, INCLUDING TRENCH EXCAVATION AND BACKFILL, SHALL BE IN ACCORDANCE WITH THE APPLICABLE DETAILS PER PLAN AND WITH ALL APPLICABLE MANUFACTURER'S RECOMMENDATIONS.
- 3. PIPES SHALL BE LAID TRUE TO PROPOSED LINE AND GRADE, WITH NO HORIZONTAL DEVIATIONS OR BELLIES. ALL PIPE JOINTS SHALL BE TIGHT AND FULLY SEALED, SO AS TO ACHIEVE WATER-TIGHT OR SOIL-TIGHT JOINTS, AS APPROPRIATE FOR THE SPECIFIC PIPE TYPE.
- 4. PROPOSED UTILITY STRUCTURES SHALL CONFORM TO THE DETAILS SHOWN ON THE PLANS, AND SHALL BE INSTALLED VERTICALLY PLUMB ON A FULLY COMPACTED BASE. STRUCTURES SHALL BE BACKFILLED IN ACCORDANCE WITH THE APPLICABLE DETAIL PER PLAN, AND THE TOP OF EACH STRUCTURE SHALL BE SET SO ALL EXPOSED PORTIONS (FRAME, GRATE, COVER, ETC.) CONFORM TO ADJACENT GRADE UNLESS OTHERWISE NOTED.
- 5. ALL WORK PERFORMED TO RESET EXISTING UTILITY BOXES OR STRUCTURES TO PROPOSED GRADE SHALL BE IN ACCORDANCE WITH THE RESPECTIVE OWNER'S (UTILITY COMPANY OR AGENCY) STANDARDS AND REQUIREMENTS. CONTRACTOR IS RESPONSIBLE FOR OBTAINING EACH UTILITY OWNER'S APPROVAL UPON COMPLETION. AS APPLICABLE IN THE EVENT AN EXISTING STRUCTURE IS BROKEN OR OTHERWISE DAMAGED BEYOND THE POINT OF REUSE, IT SHALL BE REPLACED OR RETROFITTED AS DIRECTED BY THE RESPECTIVE UTILITY OWNER.
- 6. IF A UTILITY OWNER REQUIRES THAT ALL WORK RELATING TO A SPECIFIC BOX RETROFIT OR REPLACEMENT BE EXECUTED BY ITS OWN FORCES OR BY A SEPARATE, UTILITY-CERTIFIED CONTRACTOR, THE CONTRACTOR SHALL PROVIDE INFORMATION TO AND COORDINATE WITH THAT OWNER, TO THE EXTENT NECESSARY TO FULLY FACILITATE THE RECONSTRUCTION WORK.
  - ALL STORM DRAIN INLETS AND CATCH BASINS SHALL BE IMPRINTED WITH "NO DUMPING, DRAINS INTO THE BAY" USING THERMOPLASTIC OR PERMANENTLY EMBOSSED INTO THE FACILITY.
- PRIOR TO APPROVAL FROM THE CITY OF SAUSALITO'S SEWER SYSTEM COORDINATOR, NO BACKFILL OF THE SANITARY SEWER LATERAL OR MAIN TRENCH SHALL OCCUR.

#### SHEET LIST

NOTES AND ABBREVIATIONS SITE IMPROVEMENT PLAN GRADING PLAN

· C2.2 SUBGRADE, PLAN) 21 DRAINAGE AND UTILITY PLAN DRAINAGE AND UTILITY PLAN

C4.0 DETAILS C4.1 DETAILS

DETAILS C4.2

EROSION CONTROL PLAN **EROSION CONTROL DETAILS** 

EROSION CONTROL DETAILS EROSION CONTROL DETAILS

#### ADDDEXII ATIONIC

MAXIMUM

MANHOLE

ABBRE	EVIATIONS		
AB	AGGREGATE BASE	MIN	MINIMUM
AC	ASPHALT CONCRETE	N	NORTH
AD	AREA DRAIN	OC	ON CENTER
ADA	AMERICANS WITH DISABILITIES ACT	(P)	PROPOSED
ВС	BOTTOM OF CURB	PA	PLANTED AREA
BS	BOTTOM OF STEP	PED	PEDESTRIAN
BW	BOTTOM OF WALL / BACK OF WALK	PIP	PROTECT IN PLACE
C <b>&amp;</b> G	CURB & GUTTER	PL	PROPERTY LINE
СВ	CATCH BASIN	POC	POINT OF CONNECTION
CF	CUBIC FEET	PSI	POUNDS PER SQUARE INCH
CL	CENTERLINE	PVMT	PAVEMENT
СО	CLEAN OUT	RCP	REINFORCED CONCRETE PIPE
CONC	CONCRETE	RET	RETAINING
DI	DRAINAGE INLET	RIM	TOP OF STRUCTURE GRATE/ COVE
DS	DOWN SPOUT	RW	RAINWATER
DW	DOMESTIC WATER	RWL	RAINWATER LEADER
E	EAST	S	SLOPE
(E)	EXISTING	SAP	SEE ARCHITECTURAL PLANS
	ELECTRICAL BOX	SCO	SOFTSCAPE CLEANOUT
EC	END CURVE	SD	STORM DRAIN
	ELEVATION	SDE	SHERWOOD DESIGN ENGINEERS
	ELECTRIC	SDMH	
	EDGE OF PAVEMENT	SEP	SEE ELECTRICAL PLANS
EVA	EMERGENCY VEHICLE ACCESS	SE	SQUARE FEET
FC	FACE OF CURB	SG	SUBGRADE 2 1
FEMA	FEDERAL EMERGENCY	SLAU	SEE LANDSCAPE PLANS
	MANAGEMENT AGENCY	SMP	SEE MECHANICAL PLANS
FFE	FINISHED FLOOR ELEVATION	SPD	SEE PLUMBING DRAWINGS
FG	FINISH GRADE	SPRK	FW SPRINKLER LINE
FH	FIRE HYDRANT	SQ	SQUARE
FL	FLOWLINE	SS	SANITARY SEWER
FS	FINISH SURFACE	SSCO	SANITARY SEWER CLEAN OUT
FT	FEET	SSMH	SANITARY SEWER MANHOLE
FW	FIRE WATER	SSP	SEE STRUCTURAL PLANS
G	GAS	STD	STANDARD
GB	GRADE BREAK	SW	SIDEWALK
GM	GAS METER	TB	TOP OF BANK
GV	GATE VALVE	TBD	TO BE DETERMINED
GW	GRAY WATER	TBM	TEMPORARY BENCHMARK
HP	HIGH POINT	TBR	TO BE REMOVED
HT	HEIGHT	TC	TOP OF CURB
INV	INVERT OF PIPE OR CHANNEL	TD	TRENCH DRAIN
IRR	IRRIGATION	TEL	TELEPHONE
JB	JUNCTION BOX	TEMP	TEMPORARY
JP	JOINT POLE	TG	TOP OF GRATE
LA	LANDSCAPE ARCHITECT	TS	TOP OF STEP
LF	LINEAR FEET	TW	TOP OF WALL
LP	LIGHT POLE/ LOW POINT	TYP	TYPICAL
LT	LEFT	UG	UNDERGROUND
		\A/	WATED

WATER

WALKWAY/SIDEWALK

WATER METER

WATER SURFACE

# 225 Miller Avenue, Mill Valley, CA 94941

T 415 383 7900 F 415 383 1433 www.rhaa.com

PROJECT/CLIENT NAME

## **Dunphy Park** Improvement Project

200 Napa Street Sausalito, CA 94965

City of Sausalito 420 Litho St. Sausalito, CA 94965

RHAA PROJECT NUMBER

16042A

CONSULTANT

SUBMITTAL

### Permit Submittal

21 August 2017

#### **REVISIONS**

9-18-2017	Permit Plan Check Response
	0.10.2017


**REGISTRATION AND SIGNATURE** 



SHEET TITLE **NOTES AND ABBREVIATIONS** 

DRAWN BY: JG

CHECKED BY: MW

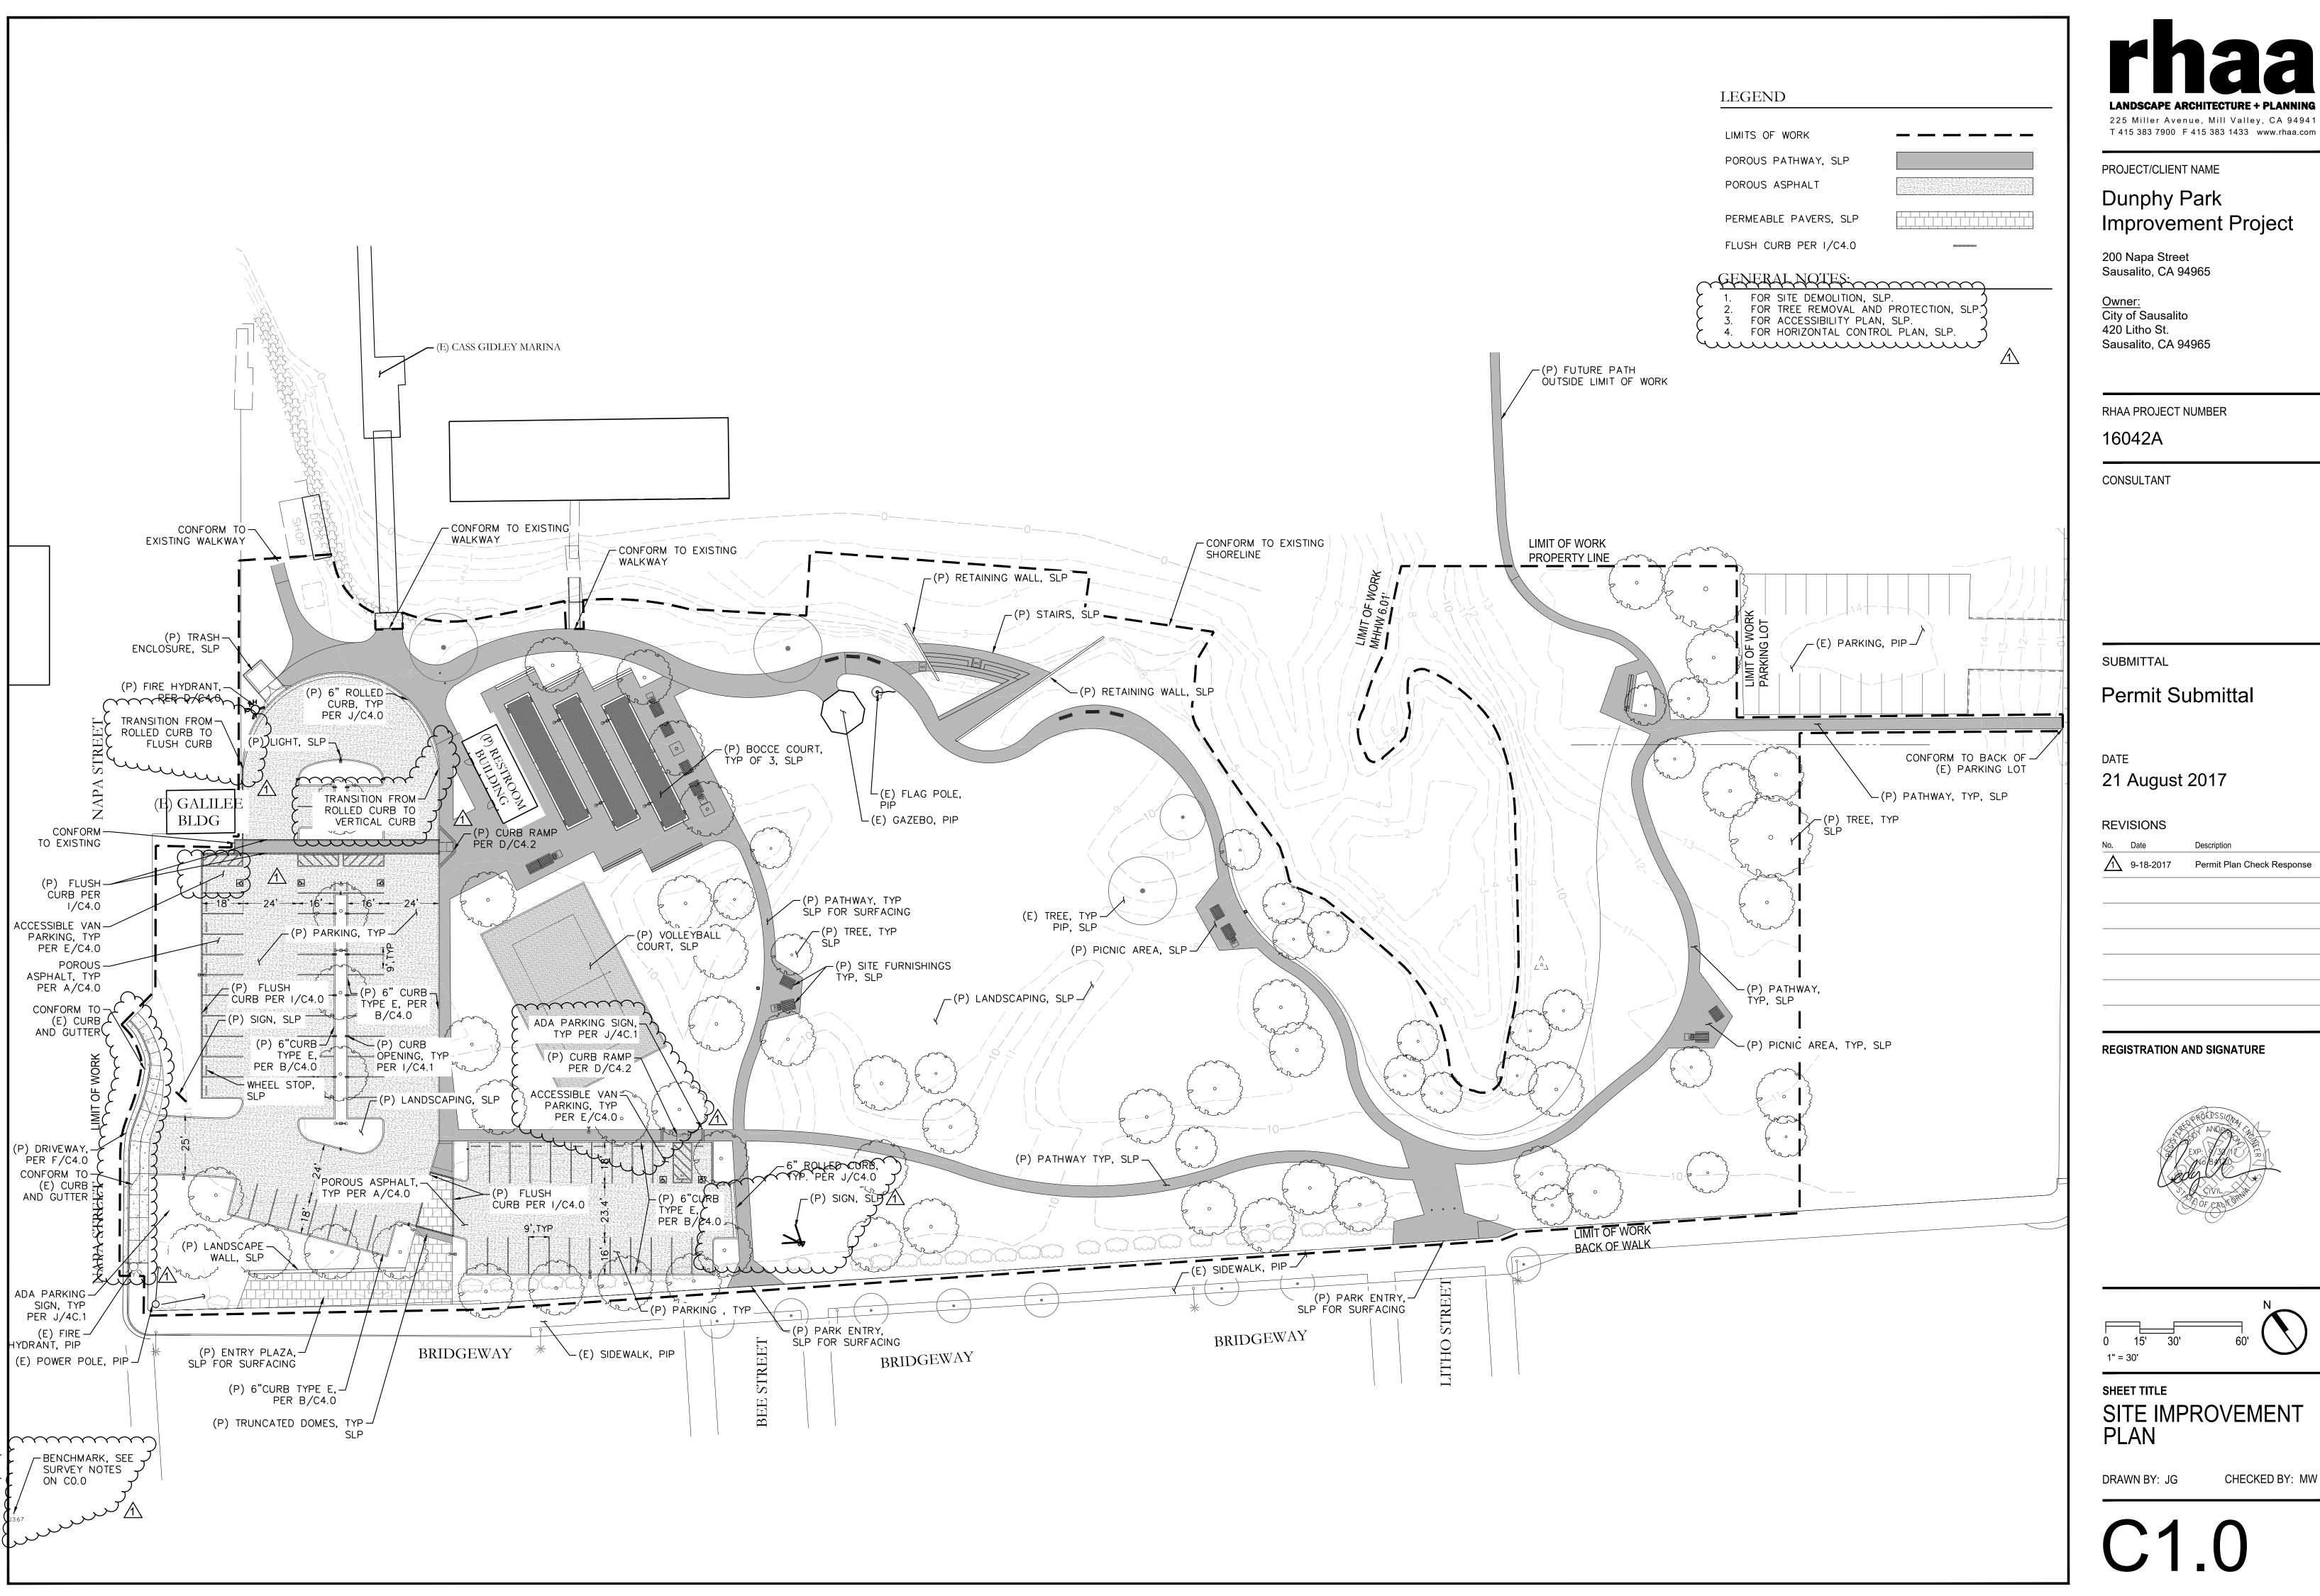

# 225 Miller Avenue, Mill Valley, CA 94941

PROJECT/CLIENT NAME

# Dunphy Park Improvement Project

200 Napa Street Sausalito, CA 94965

City of Sausalito 420 Litho St. Sausalito, CA 94965

RHAA PROJECT NUMBER

16042A

CONSULTANT

SUBMITTAL


Permit Submittal

21 August 2017

**REVISIONS** 

9-18-2017 Permit Plan Check Response



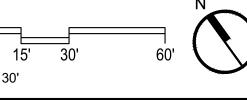

SHEET TITLE

SITE IMPROVEMENT **PLAN** 

DRAWN BY: JG

CHECKED BY: MW