SONOMA COUNTY MARIN COUNTY PACIFIC OCEAN

SHEET INDEX SHEET NO. SHEET TITLE SS1 COVER SHEET GENERAL NOTES, ABBREVIATIONS, & SYMBOLS SS2 SS3 LAYOUT PLAN - BASE BID LAYOUT PLAN - ALTERNATE BID SS3.1 SS4 DETAIL SHEET SS5 DETAIL SHEET

LOCATION MAP

CITY OF SAUSALITO DEPARTMENT OF PUBLIC WORKS

PLANS FOR CONSTRUCTION OF **BLOCK 303 SEWERAGE IMPROVEMENT PLANS**


CITY PROJECT NO: 12.02.003





PROJECT LOCATION

1-INCH - 200 FT

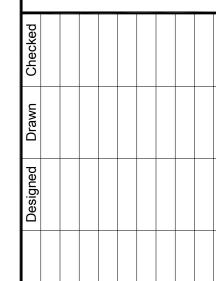


REHABIL BLOCK 303 SEWER COVER

City Of

Sausalito County Of Marin State Of

California

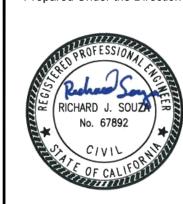

MAY 18, 2024 2300270 Project Number:

ABBREVIATIONS


ADDREVIATIONS						
AB	AGGREGATE BASE	MMWD	MARIN MUNICIPAL WATER			
AC	ASPHALT CONCRETE	NTS	DISTRICT			
ACP	ASBESTOS CEMENT PIPE	_	NOT TO SCALE			
BCDC	BAY CONSERVATION AND DEVELOPMENT COMMISSION	POC PCC	POINT ON CURVE PORTLAND CEMENT CONCRETE			
C&G	CURB & GUTTER	PRC	POINT OF REVERSE CURVE			
СВ	CATCH BASIN	PVC	POLYVINYL CHLORIDE PIPE			
CIP	CAST IRON PIPE	R.C.	RELATIVE COMPACTION			
CL	CENTERLINE / CONTROL LINE	RCP	REINFORCED CONCRETE PIPE			
CONC	CONCRETE	ROW	RIGHT OF WAY			
СР	CONTROL POINT	SD	STORM DRAIN			
DI	DROP INLET	SDCO	STORM DRAIN CLEANOUT			
EG	EXISTING GRADE	SDMH	STORM DRAIN MAINTENANCE HOLE			
EL	ELEVATION	SF	SQUARE FEET			
EX	EXISTING	SL	STREET LIGHT			
FG	FINISH GRADE	SS	SANITARY SEWER			
FH	FIRE HYDRANT	CCMI	SANITARY SEWER MAINTENANC			
FL	FLOWLINE	SSMH	HOLE			
FS	FINISH SURFACE	TC	TOP OF CURB			
GB	GRADE BREAK	TC DEP	TOP OF CURB DEPRESSION			
HDPE	HIGH DENSITY POLYETHYLENE PIPE	TW	TOP OF WALL			
HP	HIGH POINT	tw	TOE OF WALL			
INV	INVERT	TYP	TYPICAL			
JT	JOINT TRENCH	UCS	MARIN COUNTY UNIFORM CONSTRUCTION STANDARDS			
LF	LINEAR FEET	UNO	UNLESS NOTED OTHERWISE			
LOS	LINE OF SIGHT	VIF	VERIFY IN FIELD			
LP	LOW POINT	WSP	WELDED STEEL PIPE			
MH	MAINTENANCE HOLE					

LINETYPES

EXISTING	PROPOSED		
N/A	CAP & ABANDONED SEWER LINE		
N/A	CAP & ABANDONED SEWER LINE		
A A A A A A A A A	RETAINING WALL	N/A	
xxxx	FENCE	N/A	
	PROPERTY / LOT LINE	N/A	
	STORM DRAIN	N/A	
G	GAS LINE	N/A	
SS	SANITARY SEWER		
SSFM	SANITARY SEWER FORCE MAIN		
T	TELECOM LINE	N/A	
Е ———	ELECTRICAL LINE	N/A	
W	WATER	N/A	
N/A	SANITARY SEWER EASEMENT		

SYMBOLS

EXISTING		PROPOSED
	SIGN	N/A
*	LIGHT - POST MOUNTED	N/A
*	STREETLIGHT	N/A
○SSC0	SANITARY SEWER - CLEANOUT	SSCO
N/A	CHECK VALVE ASSEMBLY	OCV
(S)	SANITARY SEWER - MANHOLE	N/A
P	SEWER LIFT EJECTOR STATION	P
	STORM DRAINAGE - CATCH BASIN TYPE 'AC PER UCS DWG NO 235	N/A
	STORM DRAINAGE - DROP INLET PER UCS DWG NO 260	N/A
⋈ ^{GV}	GAS VALVE	N/A
W	WATER METER	N/A
₩V	WATER VALVE	N/A
	FOUND / SET - SURVEY STREET MONUMENT	N/A

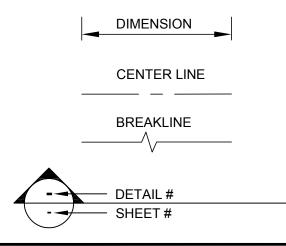

CONSTRUCTION NOTES:

- 1. SAWCUT EXISTING PAVEMENT AT LIMIT OF WORK, TYPICAL
- 2. PROTECT ALL DRAINAGE AND SEWAGE STRUCTURES AND PIPES FROM INFILTRATION OF ALL CONSTRUCTION DEBRIS FOR THE DURATION OF THE WORK, PER THE WATER POLLUTION CONTROL PLAN (WPCP).

GENERAL NOTES:

- 1. ALL WORK SHOWN ON THESE PLANS SHALL BE ACCOMPLISHED IN ACCORDANCE WITH THE SPECIAL PROVISIONS, THE UNIFORM CONSTRUCTION STANDARDS OF THE CITIES OF MARIN AND THE COUNTY OF MARIN DATED JULY, 2018, THE STATE STANDARD PLANS DATED 2018, AND THE STATE STANDARD SPECIFICATION DATED 2022, (INSOFAR AS THE SAME MAY APPLY) AS MODIFIED BY THE REVISED STANDARD PLANS AND SPECIFICATIONS IN EFFECT ON THE DATE OF THESE PLANS, AND THE SPECIAL PROVISIONS FOR THIS PROJECT.
- 2. UTILITY LOCATIONS SHOWN ON THESE PLANS ARE APPROXIMATE ONLY AND MAY NOT BE COMPLETE. THERE MAY BE ADDITIONAL UTILITIES NOT SHOWN. IT SHALL BE THE SOLE RESPONSIBILITY OF THE CONTRACTOR TO VERIFY THE PRESENCE OF UTILITIES WITHIN THE WORK LIMITS, THEIR LOCATION AND THEIR DEPTH. VERIFICATION SHALL BE COORDINATED BY THE CONTRACTOR WITH USA NORTH, THE APPROPRIATE UTILITY OWNERS; AND BY PRUDENT EXAMINATION OF THE SITE FOR INDICATIONS THAT OVERHEAD OR SUBSURFACE INSTALLATIONS EXIST SUCH AS: MAINTENANCE HOLES, VALVE COVERS, WATER METERS, SEWER CLEANOUTS, GAS METERS, POLE RISERS, CABINETS, TRAFFIC LIGHTS, STREET LIGHTS, DRAINAGE INLETS AND ETC.CALL U.S.A. NORTH (UNDERGROUND SERVICE ALERT) 811, AND FOLLOW THE PROCEDURES SPECIFIED IN THE USA NORTH 811EXCAVATION HANDBOOK
- 3. PRIOR TO STARTING AN EXCAVATION, EXAMINE THE SITE FOR INDICATIONS THAT UNMARKED SUBSURFACE INSTALLATIONS EXIST. SEWER LATERALS AND PRIVATE STORM DRAINS ARE EXAMPLES OF UTILITIES NOT MARKED BY UNDERGROUND SERVICE ALERT. CONTRACTOR IS RESPONSIBLE FOR LOCATING, POTHOLING, AND PROTECTING ALL UTILITIES IN PLACE, UNLESS OTHERWISE NOTED.
- 4. THE CONTRACTOR IS RESPONSIBLE FOR MAINTAINING ADEQUATE DRAINAGE OF THE SITE, DURING INTERIM CONDITIONS OF CONSTRUCTION.
- 5. CONTRACTOR SHALL PROVIDE ALL MATERIAL, LABOR, EQUIPMENT, FOR INSTALLATION, IMPLEMENTATION, AND MAINTENANCE OF ALL SURFACE WATER POLLUTION PREVENTION MEASURES THROUGHOUT THE FULL EXTENT OF THE PROJECT. SURFACE WATER IS CLASSIFIED AS ANY BODY OF WATER ABOVE GROUND.
- 6. PAVEMENT MARKINGS DISTURBED, DAMAGED IN ANY FORM, OR TO ANY DEGREE WHILE THE CONTRACTOR HAS CUSTODY OF THE SITE SHALL BE REPLACED IN THEIR ENTIRETY AT CONTRACTOR'S EXPENSE.
- 7. WHERE PARKING IS PERMITTED, THE CONTRACTOR SHALL POST "NO PARKING" SIGNS ON EACH PAVEMENT REHABILITATION STREET AND/OR WORK AREA. THE POSTING SHALL BE VERIFIED BY LAW ENFORCEMENT 72 HOURS PRIOR TO COMMENCING EACH PHASE OF WORK. "NO PARKING" SIGNS WILL BE SUPPLIED BY THE CITY OF SAUSALITO. IF THE INTENDED WORK DOES NOT COMMENCE WITHIN 24 HOURS OF THE SCHEDULED WORK, ALL "NO PARKING" SIGNS SHALL BE REMOVED FROM THE SITE OR AS DIRECTED BY THE ENGINEER AND A REVISED SCHEDULE SHALL BE SUBMITTED FOR REVISION.
- 8. CONTRACTOR TO PROVIDE NOTICE TO PROPERTY OWNERS AND RESIDENTS PRIOR TO MOBILIZATION TO THE SITE. ISSUE ALL ADVANCE NOTICES PER THE REQUIREMENTS IN THE SPECIFICATIONS AND DO NOT HAND OUT NOTIFICATION UNTIL IT IS APPROVED BY THE ENGINEER.
- 9. ALL EXISTING STREET SURFACE FEATURES (MAINTENANCE HOLES, CLEAN-OUTS, MONUMENTS, STRIPING, PAVEMENT MARKINGS, ETC.) SHALL BE REFERENCED BY THE CONTRACTOR PRIOR TO START OF ANY WORK.
- 10. TRAFFIC CONTROL SHALL BE SAFE AND PERFORMED IN ACCORDANCE WITH THE REQUIREMENTS OF THE LATEST "CA MANUAL OF UNIFORM TRAFFIC CONTROL".
- 11. PRIOR TO PERFORMING WORK THAT MAY DAMAGE SURVEY MONUMENTS (DISK, SPIKE, SHINER OR OTHER), CONTRACTOR SHALL OBTAIN CLEARANCE FROM COUNTY SURVEYOR. REPLACE MONUMENT IN ACCORDANCE WITH THE SPECIAL PROVISIONS.

POLLUTION CONTROL NOTES:

- 1. IF SIGNIFICANT SEDIMENT OR OTHER VISUAL SYMPTOMS OF IMPURITIES ARE NOTICED IN THE STORM WATER, CONTACT THE CITY ENGINEER IMMEDIATELY
- 2. CONTRACTOR IS RESPONSIBLE FOR INSPECTION AND RESTORATION OF ALL ASPECTS OF THIS PLAN. SEDIMENT ON SIDEWALKS AND GUTTERS SHALL BE REMOVED BY SHOVEL AND/OR BROOM AND PLACED IN STOCKPILES.
- 3. ALL DUMPSTERS OR OTHER TRASH STORAGE ENCLOSURES SHALL BE UTILIZED SOLELY FOR NON-HAZARDOUS MATERIALS.
- 4. ALL EMPLOYEES, CONTRACTORS, AND SUBCONTRACTORS ARE RESPONSIBLE FOR CONFORMING TO THE ELEMENTS SHOWN ON THIS PLAN OR RELATED DOCUMENTS.
- 5. THE CONTRACTOR IS RESPONSIBLE FOR OBTAINING ALL PERMITS AND FILING ALL PLANS WITH RELATED AGENCIES ASSOCIATED WITH THEIR WORK. THIS SHALL INCLUDE, BUT NOT BE LIMITED TO, PERMITS FOR STORAGE OF HAZARDOUS MATERIALS, BUSINESS PLANS, PERMITS FOR STORAGE OF FLAMMABLE LIQUIDS, GRADING PERMITS, OR OTHER PLANS OR PERMITS REQUIRED BY MARIN COUNTY, THE CITY OF SAUSALITO, OR OTHER AGENCIES. ALL CONTRACTORS, OR SUBCONTRACTORS WORKING ON-SITE ARE INDIVIDUALLY RESPONSIBLE FOR OBTAINING AND SUBMITTING ANY BUSINESS PLANS OR PERMITS REQUIRED BY CITY, STATE OR LOCAL AGENCIES.
- 6. CONTRACTOR SHALL LOCATE STORAGE, DELIVERY, OR WASH-OUT AREAS, TO SUIT THEIR OPERATIONS. CONTRACTOR TO MAINTAIN SECONDARY CONTAINMENT AS NECESSARY TO PROHIBIT POLLUTION AND TOXIC MATERIALS FROM ENTERING STORM DRAIN.
- CONTRACTOR SHALL UTILIZE SILT FILTERS DURING CONCRETE CONSTRUCTION NEAR EXISTING STORM DRAINAGE SYSTEM. AFTER COMPLETION OF THE PAVING, THE SILT FILTERS SHALL BE MODIFIED TO BURLAP SACKS FILLED WITH 3/4" DRAIN ROCK OR OTHER ACCEPTED BMP POSITIONED SURROUNDING EACH CATCH BASIN.

EROSION CONTROL NOTES:

- 1. NO VEHICLES SHALL BE ALLOWED TO TRACK OR SPREAD SOIL FROM THE CONSTRUCTION AREAS ONTO EXISTING PAVED PUBLIC STREETS.
- 2. THE EROSION AND SEDIMENT CONTROL MEASURES WILL BE OPERABLE FOR DURATION OF PROJECT. NO GRADING WILL OCCUR BETWEEN OCTOBER 1ST AND APRIL 15TH, UNLESS AUTHORIZED BY THE CITY ENGINEER.
- 3. DURING THE RAINY SEASON, ALL PAVED AREAS WILL BE KEPT CLEAR OF EARTH MATERIAL AND DEBRIS. THE SITE WILL BE MAINTAINED SO THAT A MINIMUM OF SEDIMENT-LADEN RUNOFF ENTERS THE STORM DRAIN SYSTEM. THESE PLANS SHALL REMAIN IN EFFECT UNTIL THE TRACT IMPROVEMENTS ARE ACCEPTED BY THE CITY, AND ALL SLOPES ARE STABILIZED FROM EROSION.

URBAN RUNOFF POLLUTION NOTES:

- 1. STABILIZE ALL DENUDED AREAS AND MAINTAIN EROSION CONTROL MEASURES CONTINUOUSLY FOR THE DURATION OF THE PROJECT.
- 2. REMOVE SPOILS PROMPTLY AND AVOID STOCKPILING OF FILL MATERIALS WHEN RAIN IS FORECAST. IF RAIN THREATENS, STOCK- PILED SOILS AND OTHER MATERIALS SHALL BE TARPED, OR AS OTHERWISE DIRECTED BY CITY ENGINEER.
- 3. STORE, HANDLE AND DISPOSE OF CONSTRUCTION MATERIALS AND WASTES SO AS TO PREVENT THEIR ENTRY TO THE STORM DRAIN SYSTEM. CONTRACTOR MUST NOT ALLOW NON-STORMWATER DISCHARGE TO ENTER SITE RUNOFF.
- 4. USE FILTRATION OR OTHER MEASURES TO REMOVE SEDIMENT FROM DEWATERING EFFLUENT.
- 5. NO CLEANING, FUELING OR MAINTAINING VEHICLES ON SITE SHALL BE PERMITTED IN ANY MANNER THAT ALLOWS DELETERIOUS MATERIALS TO ENTER CATCH BASINS OR TO ENTER SITE RUNOFF.
- 6. CONTRACTOR TO RELOCATE CONCRETE WASHDOWN, VEHICLE STORAGE DELIVERY, AND NON HAZARDOUS WASTE AREAS AS NECESSARY TO FACILITATE THEIR OPERATION, PROMOTE POLLUTION CONTROL AND TO MINIMIZE PROJECT FOOTPRINT.

PRESERVATION OF SURVEY MONUMENTS

CONTRACTOR SHALL PRESERVE ALL SURVEY MONUMENTS WITHIN THE LIMITS OF WORK. MONUMENT(S) WITHIN THE LIMITS OF WORK SHALL BE REFERENCED, PRIOR TO WORK COMMENCING, BY A LICENSED LAND SURVEYOR AS REQUIRED BY SECTION 8771 OF THE BUSINESS AND PROFESSIONS CODE. CORNER RECORDS OF THIS WORK MUST BE SUBMITTED FOR FILING TO THE COUNTY SURVEYOR OF MARIN COUNTY PUBLIC WORKS DEPARTMENT, ENGINEERING DIVISION, SURVEY SECTION.

THE CONTRACTOR SHALL BE RESPONSIBLE FOR THE PRESERVATION OF EXISTING SURVEY MONUMENTS, BENCHMARKS, REFERENCE MARKS AND STAKES. SHOULD ANY SURVEY MONUMENTS, BENCHMARKS, REFERENCE POINTS, OR STAKES BE DAMAGED OR DESTROYED DURING THE PERFORMANCE OF THIS WORK, THE CONTRACTOR SHALL REPLACE SAID ITEMS PER CITY CONSTRUCTION STANDARDS IN ACCORDANCE WITH THE SPECIAL PROVISIONS AND CONTACT THE COUNTY, SURVEY SECTION, CHIEF OF PARTY FOR FINAL INSPECTION AND ACCEPTANCE OF THE WORK.

SURVEY NOTES

1. DISTANCES SHOWN ARE IN FEET AND DECIMALS THEREOF.

2. FIELD SURVEY WITHIN ALEXANDER ROADWAY WAS PERFORMED IN AUGUST OF 2010 AND NOVEMBER OF 2023 BY CSW/STUBER-STROEH ENGINEERING GROUP, INC. ALL OTHER TOPOGRAPHIC INFORMATION OUTSIDE OF ALEXANDER ROADWAY IS SHOWN APPROXIMATE ONLY.

PROJECT STANDARD PLANS

SAUSALITO MARIN CITY SANITARY DISTRICT

SD17 RESIDENTIAL SEWAGE EJECTION SYSTEM

UNIFORM CONSTRUCTION STANDARDS (UCS)
OF THE CITIES OF MARIN AND COUNTY OF MARIN, JULY 2018

UCS DWG. NO. 100 REQUIREMENTS FOR CONCRETE CURB, GUTTER, SIDEWALK, DRIVEWAY, AND OTHER "FLATWORK" UCS DWG. NO. 105 CURB, GUTTER AND SIDEWALK DETAILS

CSW ST2

CSW/Stuber-Stroeh


Engineering Group, Inc.

45 Leveroni Court tel: 415.883.9850 Novato, CA 94949 fax: 415.883.9835

Civil & Structural Engineers
Surveying & Mapping
Environmental Planning

Land Planning

Construction Management

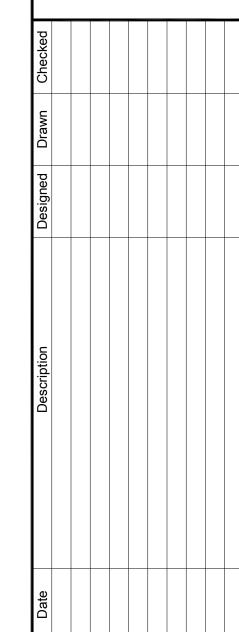

303 SEWER REHABILITATES, EVIATIONS, & SYMBOLS

ATION

City Of
Sausalito
County Of
Marin

 $\mathbf{\Omega}$

California
Prepared Under the Direction of:

State Of




Scale: n/

 Scale:
 n/a

 Date:
 MAY 18, 2024

 Project Number:
 2300270

 Sheet Number:
 2 of 6

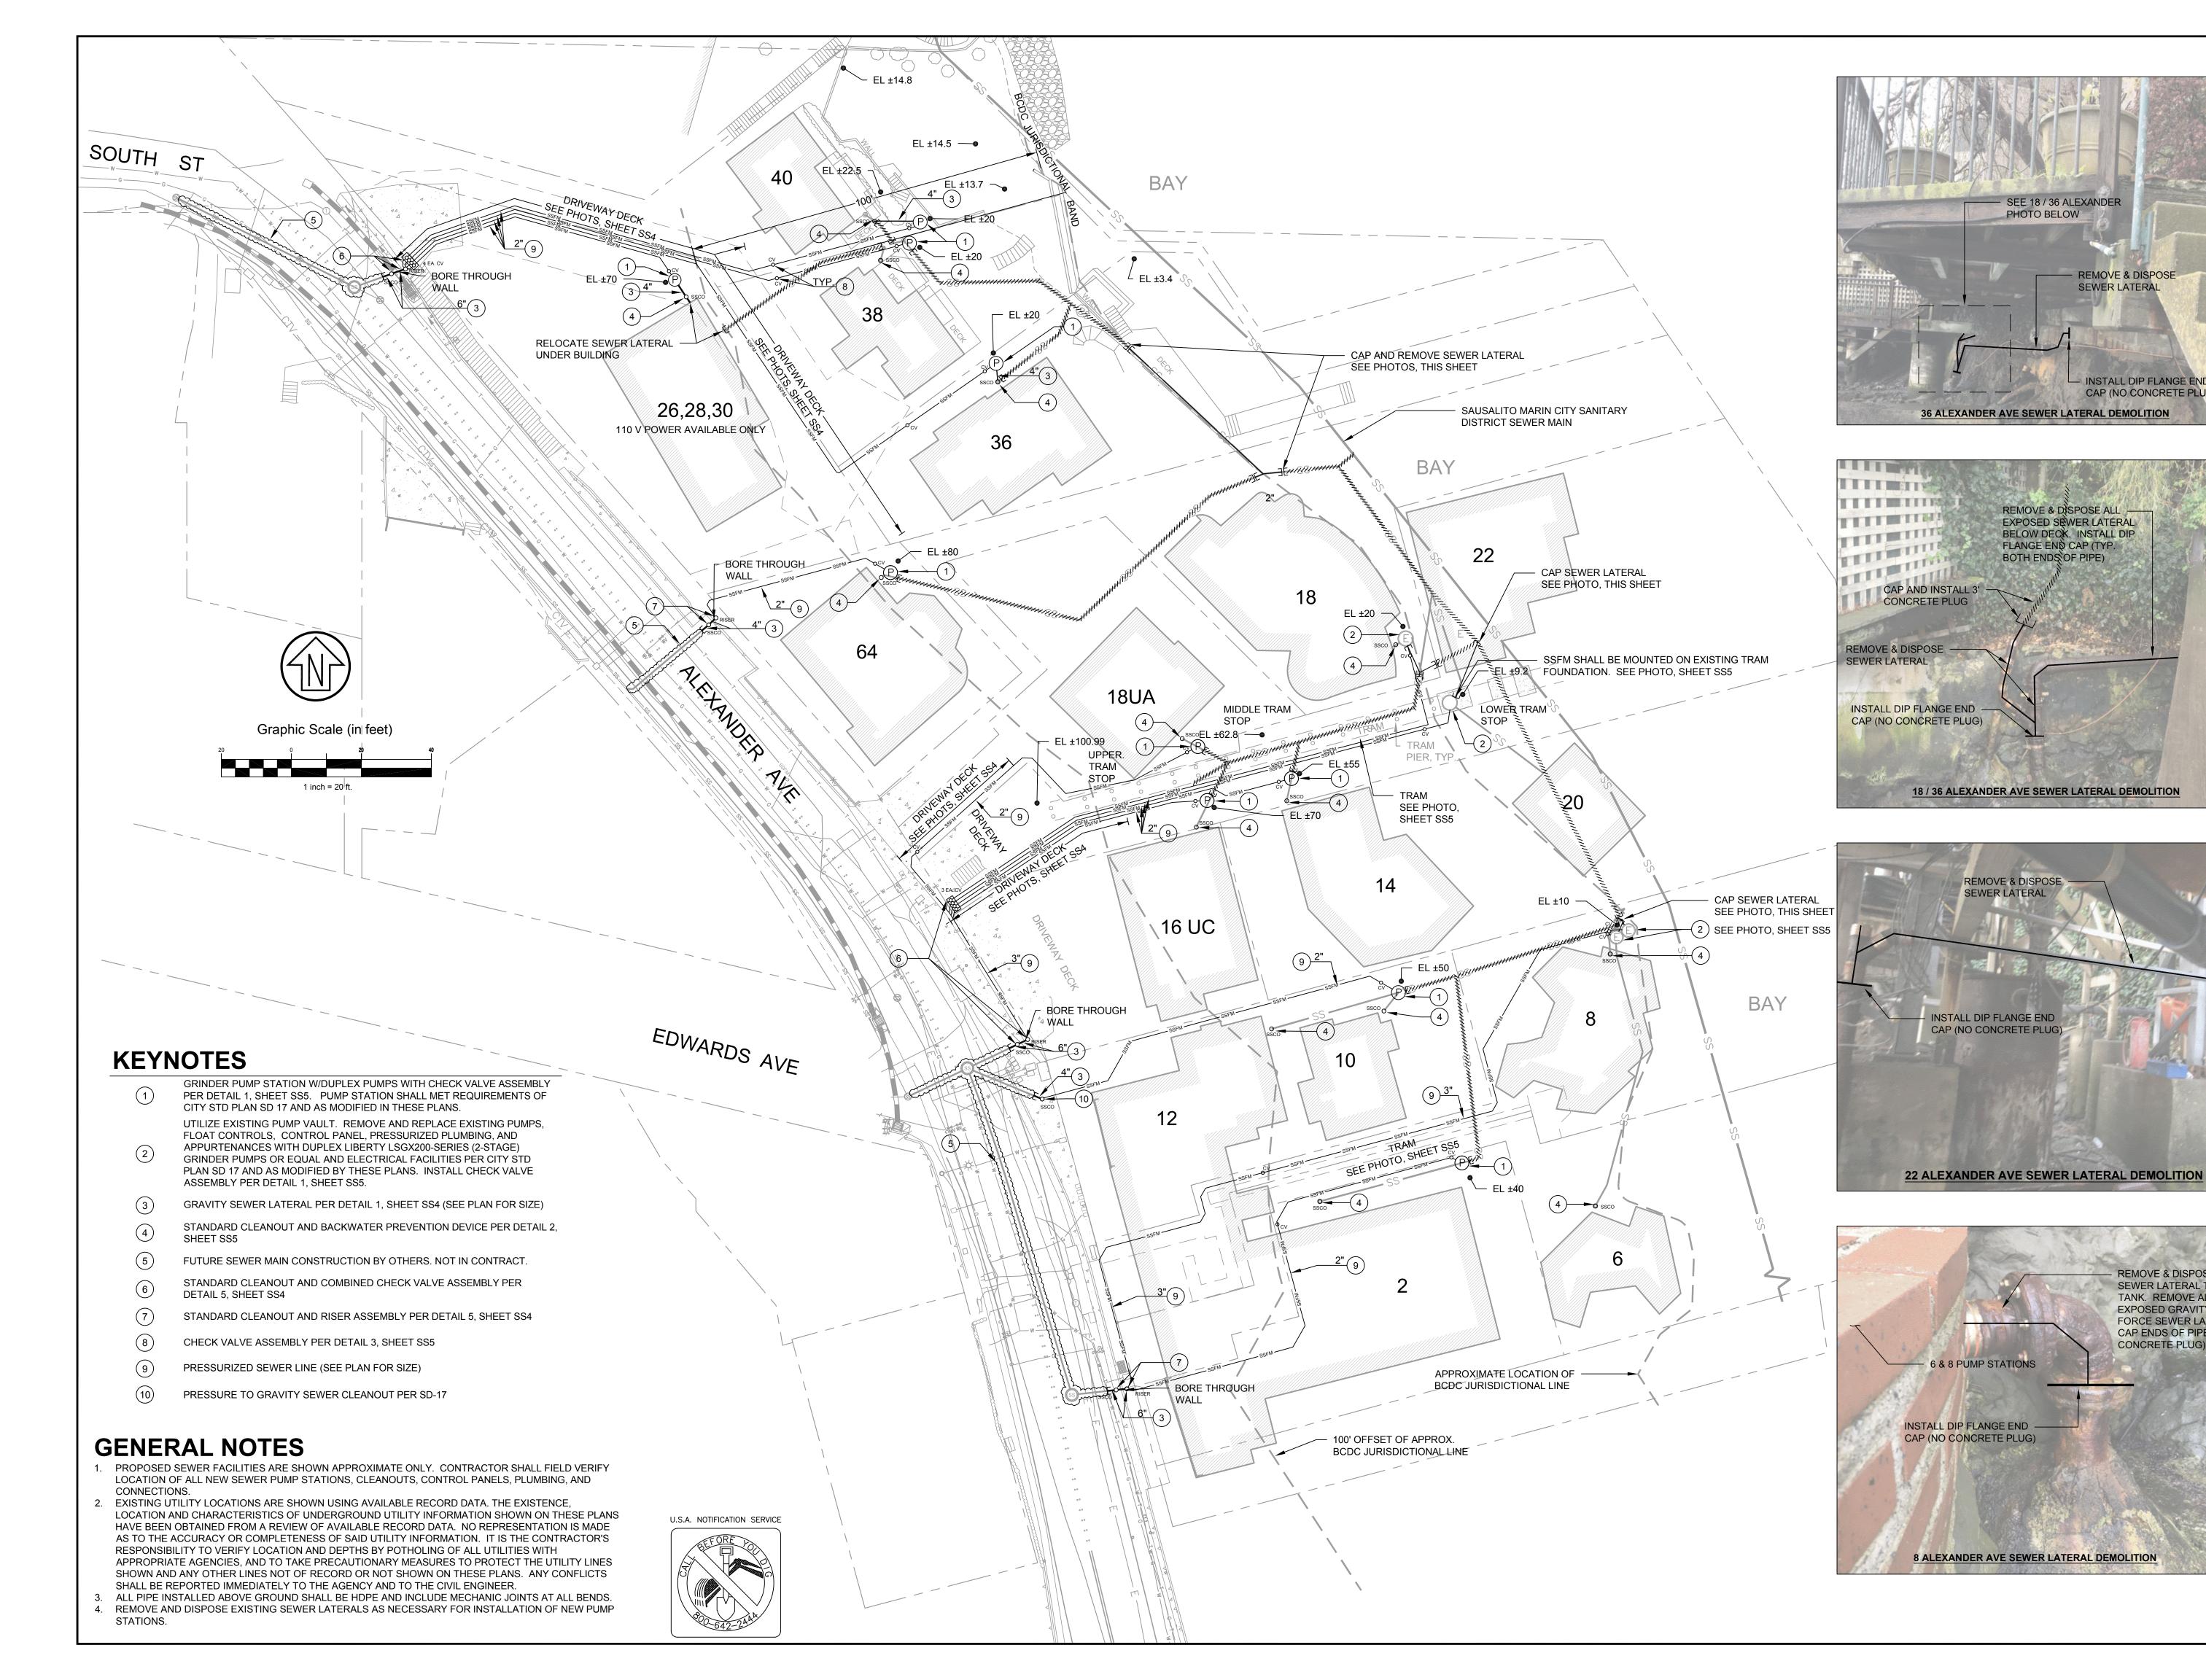

CSW ST2

CSW/Stuber-Stroeh

Engineering Group, Inc.

45 Leveroni Court tel: 415.883.9850 Novato, CA 94949 fax: 415.883.9835

Civil & Structural Engineers Surveying & Mapping Environmental Planning Land Planning

Construction Management

— REMOVE & DISPOSE

INSTALL DIP FLANGE END CAP (NO CONCRETE PLUG)

SEWER LATERAL

B BID 303

> Sausalito County Of

Marin State Of California

Prepared Under the Direction of:

REMOVE & DISPOSE

TANK. REMOVE ALL

CONCRETE PLUG).

SEWER LATERAL TO SUMP


EXPOSED GRAVITY AND

CAP ENDS OF PIPE (NO

FORCE SEWER LATERALS.



1 inch = 20 ft MAY 18, 2024 2300270 Project Number: Sheet Number:

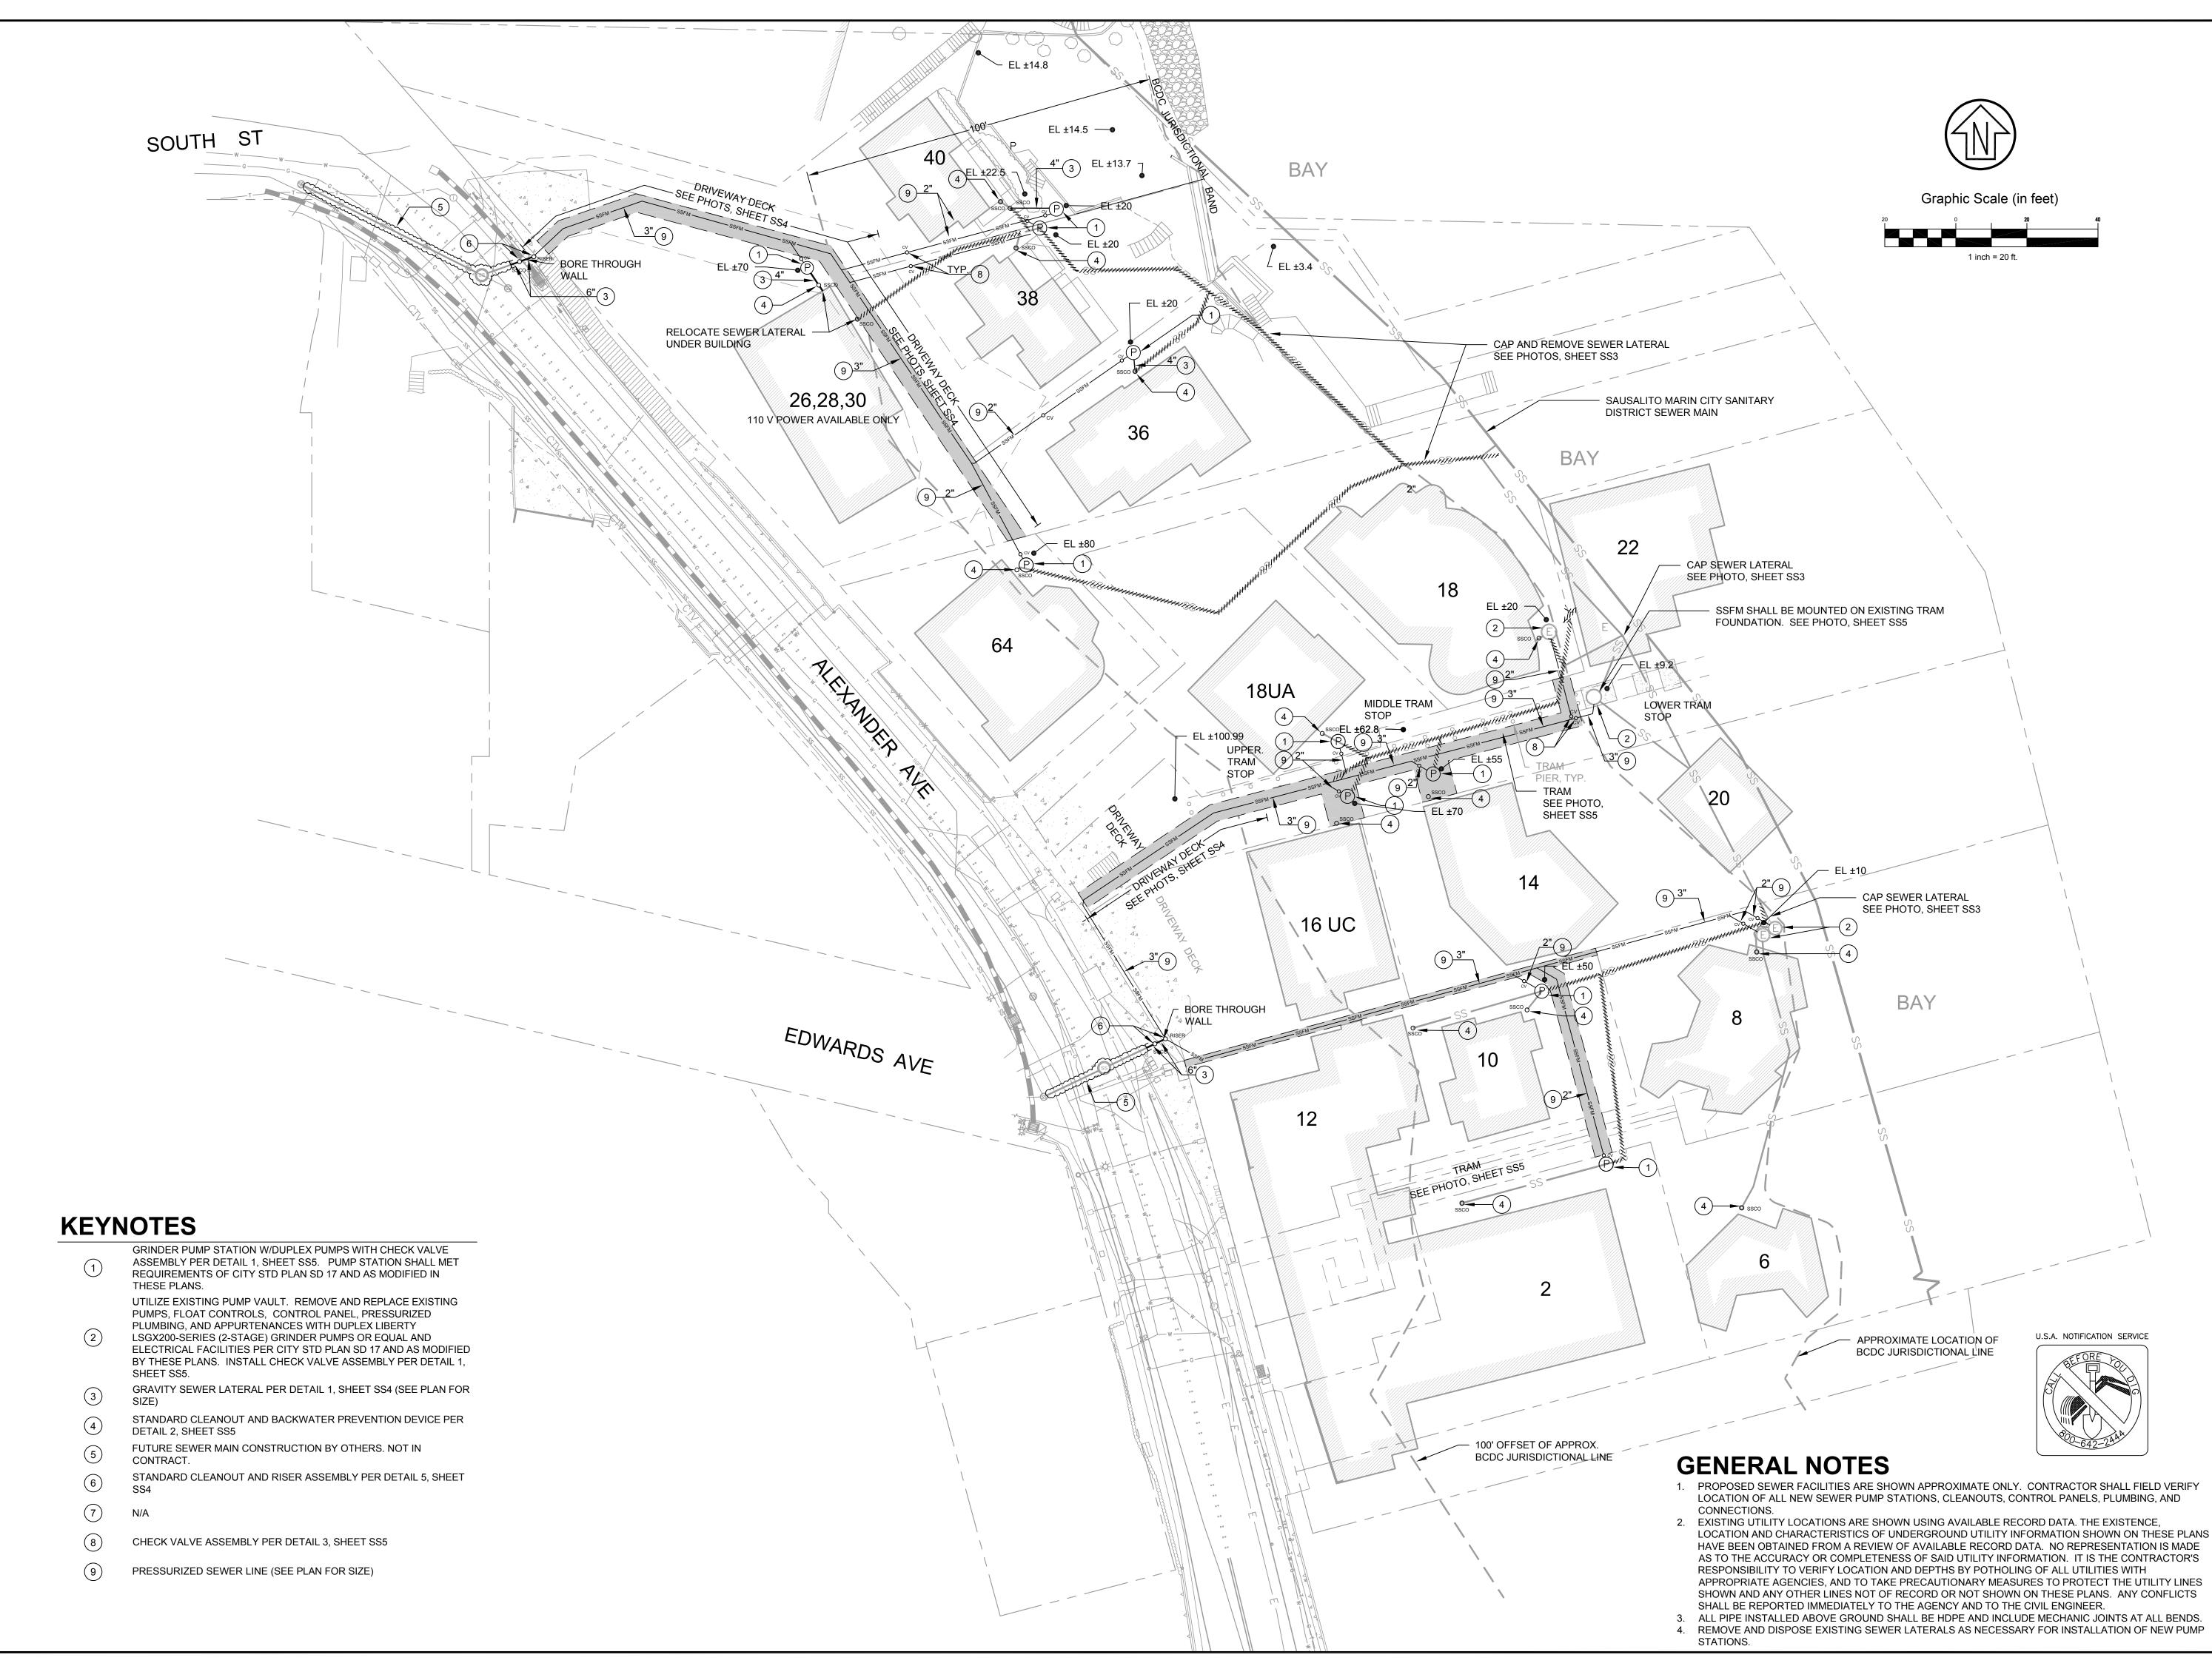

CSW ST2


CSW/Stuber-Stroeh

Engineering Group, Inc.

45 Leveroni Court tel: 415.883.9850 Novato, CA 94949 fax: 415.883.9835 Civil & Structural Engineers Surveying & Mapping Environmental Planning

Land Planning

Construction Management

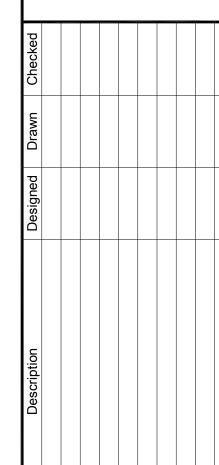

ITATION 303

City Of Sausalito


County Of Marin State Of

California Prepared Under the Direction of:



Sheet Number:

1 inch = 20 ft Scale: MAY 18, 2024 Date: Project Number: 2300270

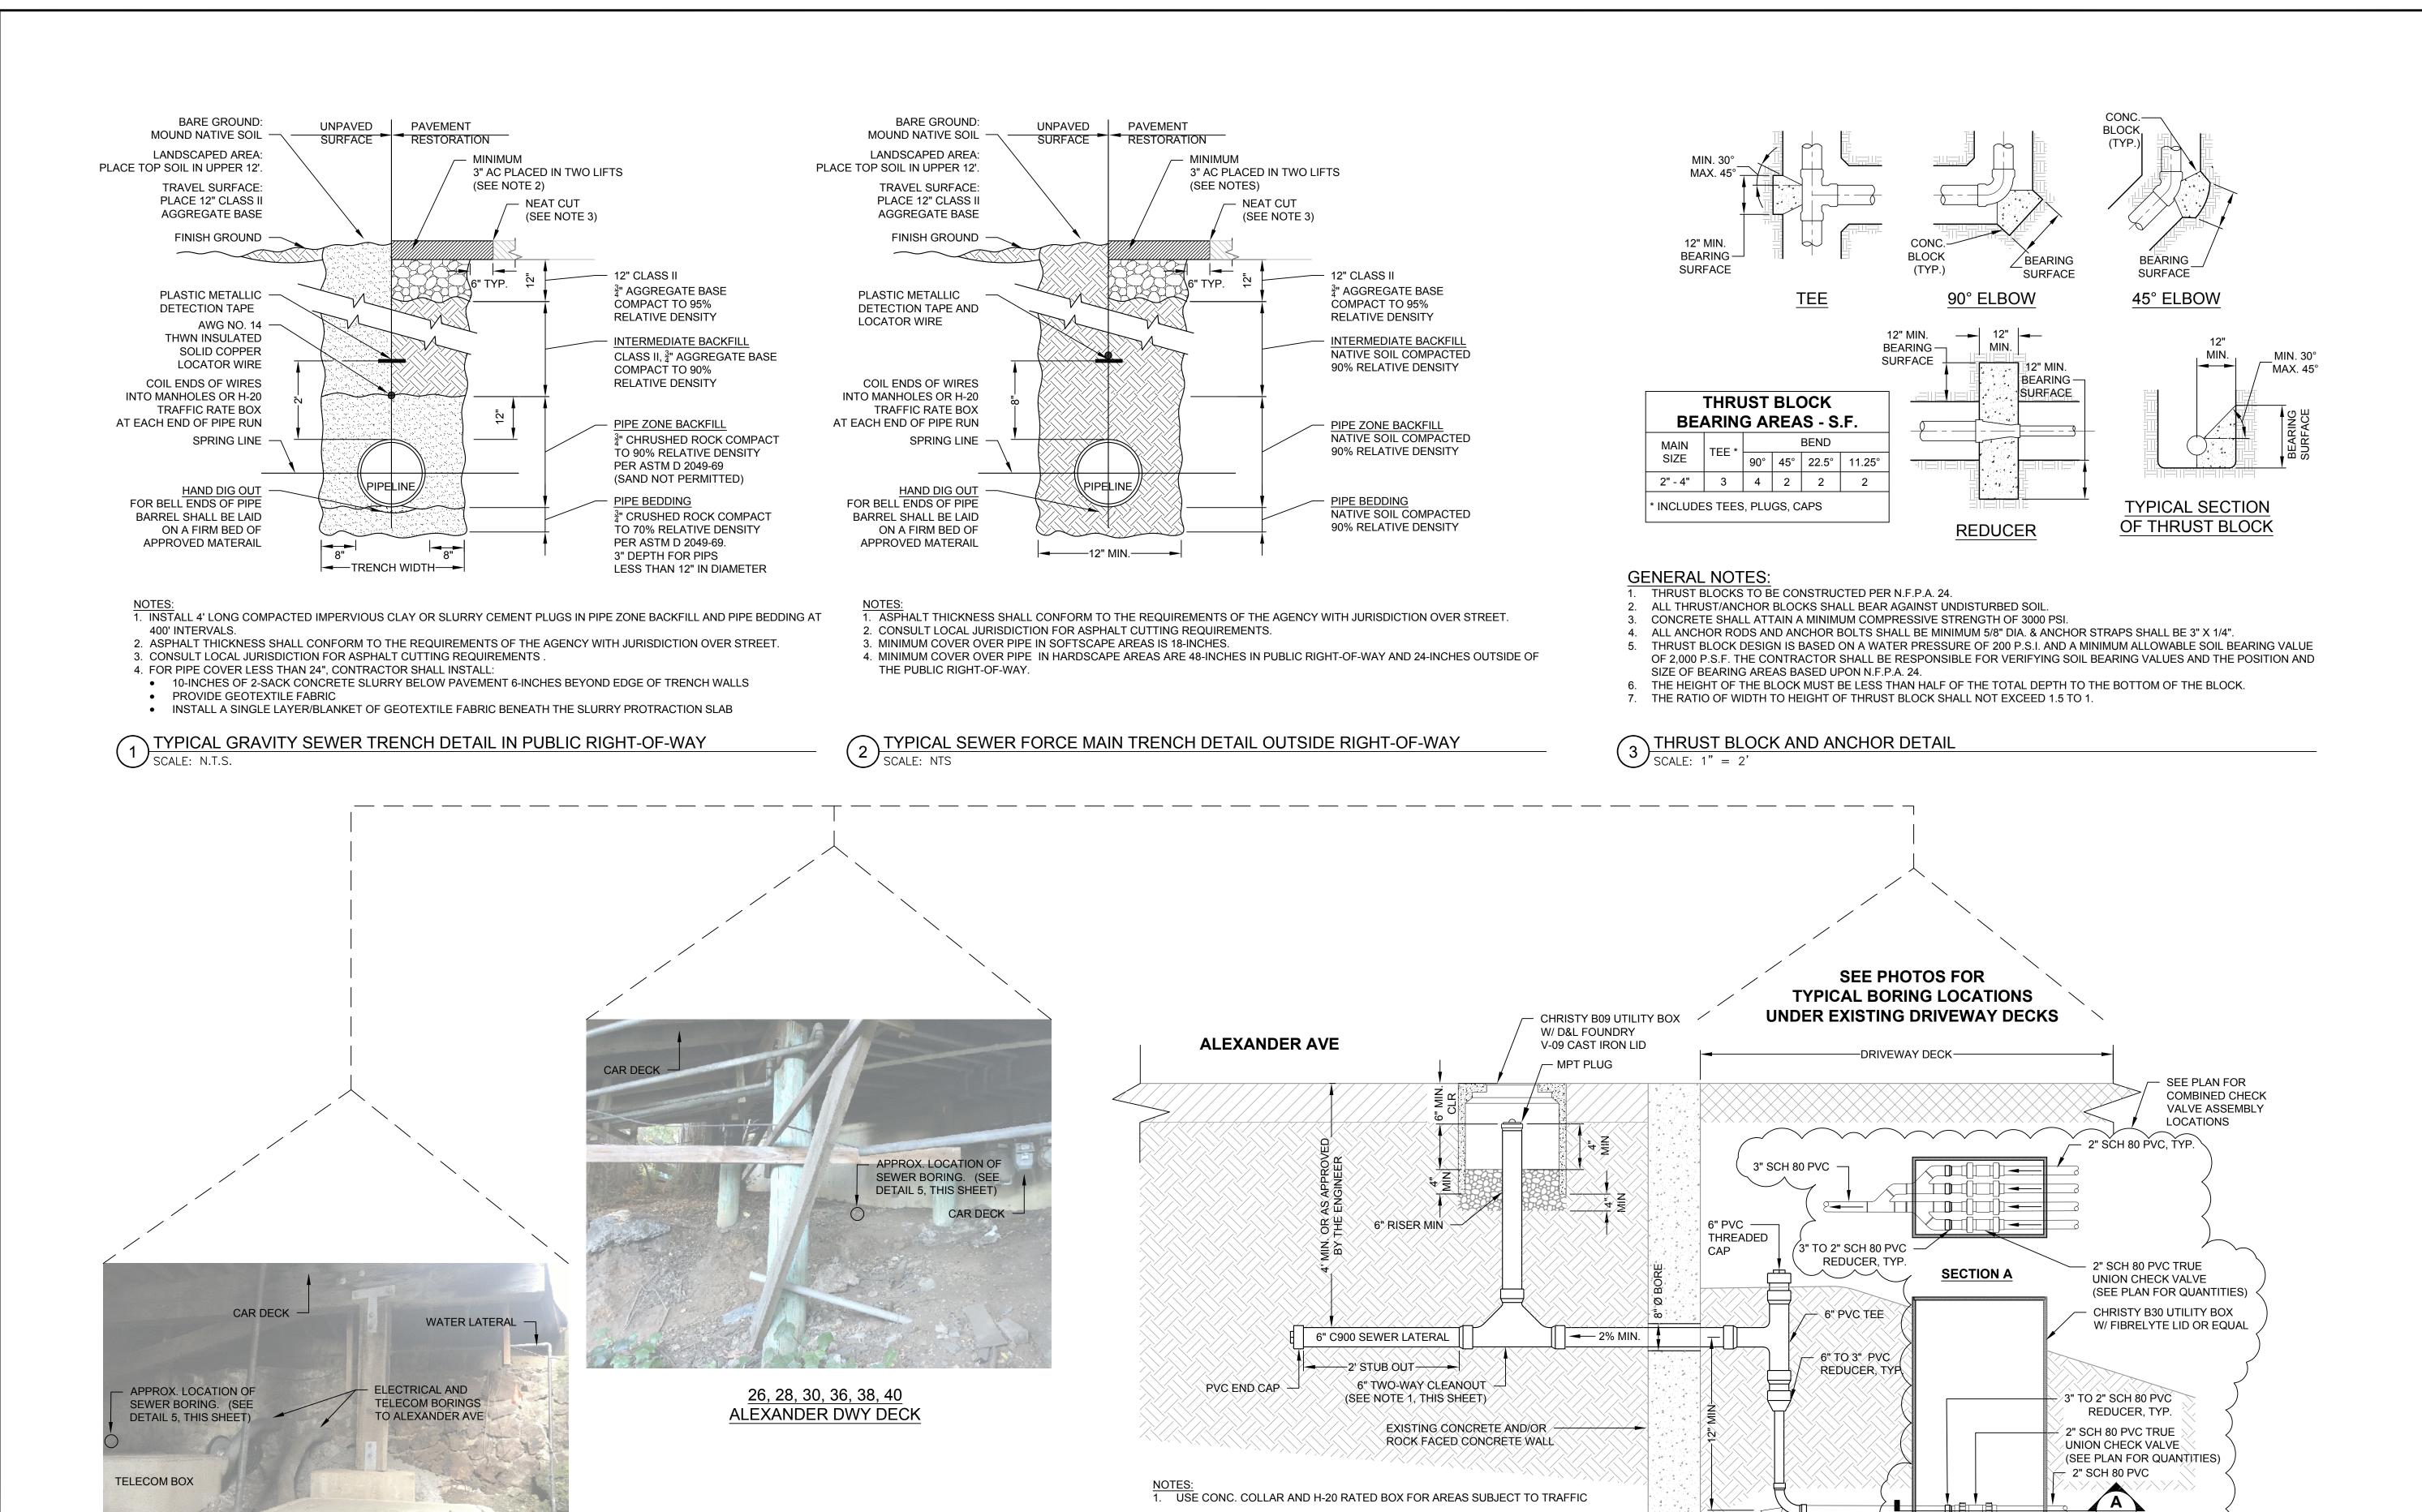

16 ALEXANDER DWY DECK

PG&E BOX

5 STANDARD CLEANOUT AND BACKWATER PREVENTION DEVICE SCALE: N.T.S.

CSW ST2

CSW/Stuber-Stroeh Engineering Group, Inc. 45 Leveroni Court tel: 415.883.9850 Novato, CA 94949 fax: 415.883.9835

Civil & Structural Engineers Surveying & Mapping Environmental Planning

Construction Management nttp://www.cswst2.com

Land Planning

'ATION REHABIL AUSALITO, SEWER

> City Of Sausalito

303

OCK

BL

 $^{\circ}$ 4" MIN OF 3 " CRUSHED ROCK

THRUST BLOCK

County Of Marin State Of


California Prepared Under the Direction of:

Scale: 1 inch = 20 flMAY 18, 2024 2300270 Project Number: Sheet Number:

1. LIBERTY DUPLEX GRINDER PUMP, LSGX200-SERIES (2-STAGE, 2HP, 208-230V) OR EQUAL.


- 2. PUMP STATION AT 26,28,30 HAS 110V BREAKER BOX. USE LIBERTY PRG-SERIES (1 PHASE, 115V, 1 HP)
- DUPLEX PUMPS OR EQUAL.
- 3. AK INDUSTRIES FIBERGLASS PUMP VAULT, MODEL GB-48X--301 OR EQUAL
- 4. FIELD CUT AND GAS-TIGHT SEAL ALL PIPE AND ELECTRICAL CONDUIT CONNECTIONS 5. CONTROL PANEL AND ELECTRICAL FACILITIES SHALL MEET SAUSALITO MARIN CITY SANITARY
- DISTRICT STANDARD PLAN SD17 FOR RESIDENTIAL SEWAGE EJECTION SYSTEM

SEWER LIFT EJECTOR STATION DETAIL SCALE: N.T.S.

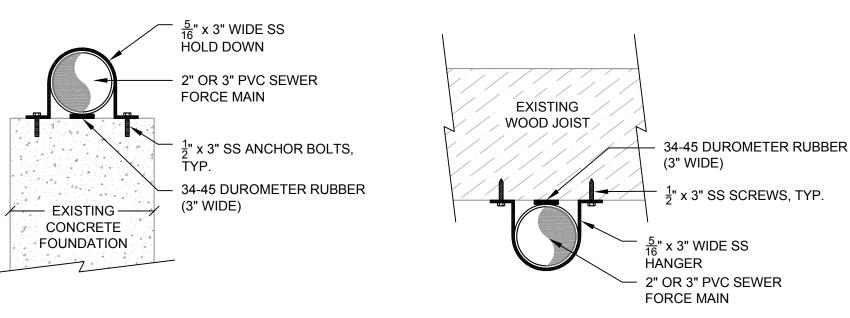

- 1. SEWER FORCE MAINS MOUNTED ABOVE GRADE ON EXISTING STRUCTURES SHALL BE AT 20-FT INTERVALS OR AS APPROVED BY THE ENGINEER.
- 2. SEWER FORCE MAIN LOCATIONS MOUNTED ABOVE GRADE SHALL BE APPROVED BY THE ENGINEER.
- 3. CONTRACTOR MAY UTILIZE SS UNISTRUT OR EQUAL ANCHORING SYSTEM


SPLICE BOX DETAIL SCALE: N.T.S.

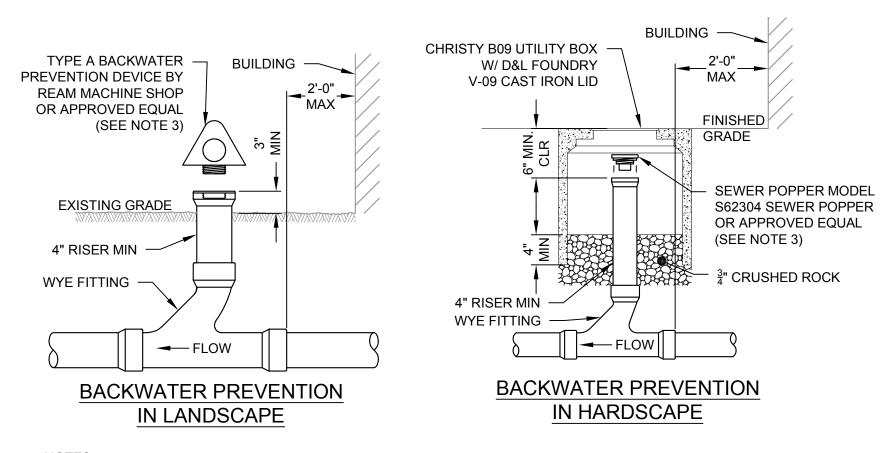


CLEANOUTS LOCATED UNDER PAVED DRIVEWAYS, WALKWAYS, ETC SHALL BE RAISED TO GRADE AND INSTALLED IN PRECAST CONC METER BOXES FLUSH FITTED TO PAVING W/ GALVANIZED STEEL CHECKERED PLATE TRAFFIC LIDS MARKED "SEWER", CHRISTY B16 OR EQUAL, AS DIRECTED BY THE

- 2. CLEANOUTS LOCATED IN LANDSCAPE AREAS SHALL BE RAISED 3" ABOVE GRADE AND INSTALLED IN PRECAST CONC METER BOXES FLUSH FITTED TO PAVING W/ GALVANIZED STEEL CHECKERED PLATE TRAFFIC LIDS MARKED "SEWER", CHRISTY B09 OR EQUAL, AS DIRECTED BY THE DISTRICT
- SEWER POPPER OR TYPE A BACKWATER PREVENTION DEVICE SHALL BE INSTALLED NO LOWER THAN THE LOWEST DRAINED FIXTURE UNIT IN THE BUILDING (VIF). IF THE DIFFERENCE IN ELEVATION OF THE LOWEST FIXTURE AND THE BACKWATER PREVENTION DEVICE IS LESS THAN 6 INCHES, A BACKWATER CHECK VALVE SHALL BE INSTALLED AS SHOWN IN STD DETAIL SD7.

STANDARD CLEANOUT AND BACKWATER PREVENTION DEVICE

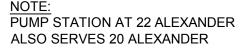


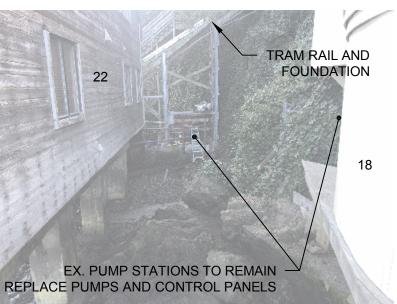

18 & 26 ALEXANDER PUMP STATIONS




TO 14, 16UC, 18, 18UC, 20, 22 ALEXANDER

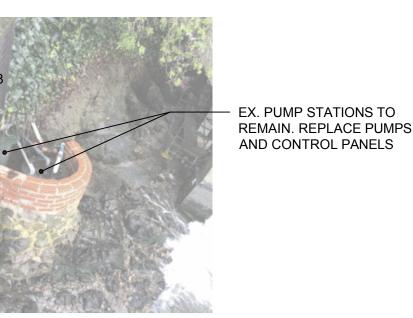

6 & 8 ALEXANDER PUMP STATIONS




TRAM RAIL AND FOUNDATION TO 6, 8 10, 12 ALEXANDER

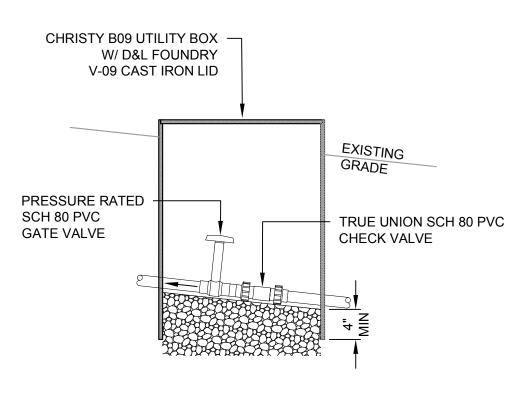

CHECK VALVE ASSEMBLY IN LANDSCAPE AREA


NOTES: INSTALL CHECK VALVE ASSEMBLY EVERY 300-FT FOR 2" SEWER FORCE AND 200-FT FOR 3" SEWER FORCE MAIN

SEWER FORCE MAIN CHECK VALVE ASSEMBLY DETAIL

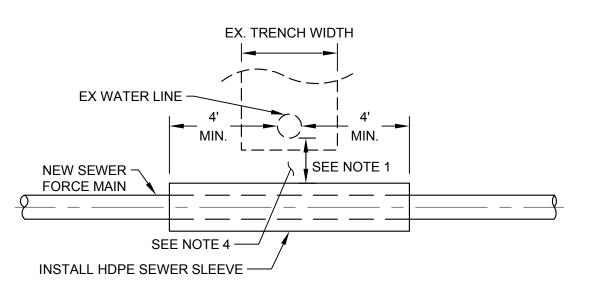

- FOR OPEN TRENCH INSTALLATIONS, INSTALL HDPE SLEEVE WHERE VERTICAL CLEARANCE IS LESS THAN 12" BETWEEN NEW SEWER AND EXISTING WATER LINE. VERTICAL CLEARANCE BETWEEN UTILITY LINES SHALL NOT BE LESS THAN 4 ".
- IF SEWER CROSSES ABOVE EXISTING WATER LINE WITH LESS THAN 12" CLEARANCE. THEN HDPE SLEEVE SHALL EXTEND 10' MINIMUM FROM OUTSIDE Ø OF WATER LINE.
- FILL ANNULAR SPACE BETWEEN NEW PIPE AND SLEEVE WITH CLSM OR LDCC. 4. BACKFILL WITH CLSM OR LDCC WHERE SPECIFIED COMPACTION CANNOT BE ACHIEVED BETWEEN UTILITIES.

SEWER FORCE MAIN CROSSING WATER LINE SCALE: N.T.S.

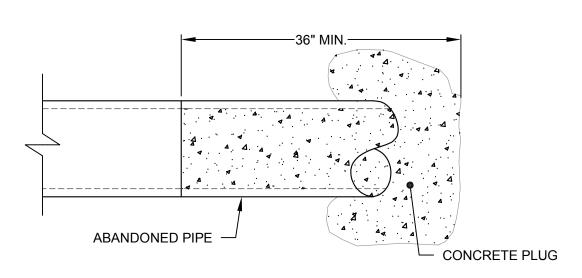

TYPICAL PIPE CONCRETE PLUG DETAIL

CSW ST2

CSW/Stuber-Stroeh

Engineering Group, Inc. 45 Leveroni Court tel: 415.883.9850 Novato, CA 94949 fax: 415.883.9835

Civil & Structural Engineers Surveying & Mapping Environmental Planning Land Planning

Construction Management

http://www.cswst2.com

REHABIL

B City Of Sausalito County Of Marin

303

State Of California

Prepared Under the Direction of:

1 inch = 20 ft

MAY 18, 2024 2300270 Project Number: Sheet Number: