



STAFF REPORT

SAUSALITO CITY COUNCIL

AGENDA TITLE:

First Amendment to the AT&T Cell Tower Lease @ Hwy 101 & Rodeo Drive

RECOMMENDED MOTION:

Adopt a Resolution of the City Council of the City of Sausalito Approving the First Amendment to Lease Agreement with AT&T @ Hwy 101 & Rodeo Drive and Authorizing the City Manager to execute the Amendment on behalf of the City

DISCUSSION

AT&T requested consent to amend their existing lease and modify their communications facility at the corner of Hwy. 101 and Rodeo Avenue in October 2008. The scope of work was as follows:

- Replace 2 antennas with like kind antennas
- Add 2 like kind antennas
- Replace equipment cabinet and add 4 remote radio units (RRU's) inside underground vault
- Add 2 Tower Mounted Amplifiers (TMA's) behind antennas
- Add 2 Remote Electrical Tilt Kits (RET's) to bottom of antennas

AT&T received approval before the planning commission on July 1, 2009 (see attached Planning Commission Resolution 2009-30) to modify the site. Subsequent to Planning Commission approval, AT&T and was advised by the City Attorney that a lease modification was required.

TERMS AND CONDITIONS

Finance Department initiated negotiations with AT&T and exacted the following terms and conditions:

- The lease agreement was originally intended to only encompass 2 antennas. At the time of the original lease, the discussions surrounding the size of the antennas clearly demonstrated the City's concern with just two antennas. Accordingly, AT&T's request to add two additional antennas warrants additional consideration in terms of monthly compensation. City research indicated that public tower companies would typically charge up to an additional \$250 per antenna and line. The City therefore requested and AT&T agreed to an additional \$500 per month in lease revenue, for a total of \$3,100 per month. This amount is consistent with the City's comparable leases at this site for size of equipment, ground space leased and number of antennas. The lease contains an annual escalator clause of 4%

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- The lease amendment requesting any equipment required by a local, state or federal entity for emergency 911 seemed a bit vague and open-ended. The City is comfortable with considering on a case-by-case basis all requests from AT&T for additional or new equipment, with adequate supporting documentation demonstrating that the equipment is actually mandated by E-911 laws. AT&T agreed.

STANDARDS AND CRITERIA FOR WIRELESS COMMUNICATIONS FACILITIES

All cell tower leases must comply with Chapter 10.45 of the City of Sausalito Zoning Ordinance. Consistent with the ordinance, the City has implemented a uniform and standard set of guidelines and criteria for the orderly development and siting of wireless communications facilities in order to avoid or minimize land use conflicts related to land use compatibility, visual resources, public safety, and environmental impacts. AT&T submitted a complete and comprehensive packet of information, and the Planning Commission approved a Conditional Use Permit and Design Review and made the following findings:

- The proposed project is consistent with the General Plan, the Zoning Ordinance, and any applicable specific plans.
- The proposed project complements the surrounding neighborhood and/or district and, when antenna is attached to, or part of, a structure, the antenna and its screening complement the architecture of the structure.
- The proposed project is consistent with the general scale of structures and buildings in the surrounding neighborhood and/or district.
- The proposed project has been located and designed to minimize obstruction of public views and primary views from private property.
- The proposed project will not result in a prominent profile (silhouette) above a ridgeline.
- The proposed landscaping provides appropriate visual relief, complements the buildings and structures on the site, and provides an attractive environment for the enjoyment of the public.
- Mechanical equipment is appropriately designed and located to minimize visual, noise, and air quality impacts to adjacent properties and the general public.
- The proposed design preserves protected trees and significant natural features on the site to a reasonable extent and minimizes site degradation from construction activities and other potential impacts.
- The proposed use, together with the applicable conditions, will not be detrimental to the public health, safety, or general welfare of the City.
- The proposed facility will not materially adversely affect nearby properties or their permitted uses.

There were no appeals to the Planning Commission's Resolution Number 2009-30.

FISCAL IMPACT

The city's General Fund would realize \$6,000 in additional new revenues annually.


STAFF and OMIT RECOMMENDATIONS

Staff recommends that the City Council of the City of Sausalito Adopt a Resolution of the City Council of the City of Sausalito Approving the First Amendment to the cell tower lease with AT&T @ Hwy 101 & Rodeo Drive and Authorizing the City Manager to execute the Amendment on behalf of the City


ATTACHMENTS

1. Sausalito Planning Commission Resolution 2009-30
2. Resolution of the City Council of the City of Sausalito Approving the First Amendment to the Lease Agreement with AT&T @ Hwy 101 & Rodeo Drive and Authorizing the City Manager to execute the Amendment on behalf of the City
3. Exhibit A to Resolution - First Amendment to Lease Agreement


PREPARED BY:

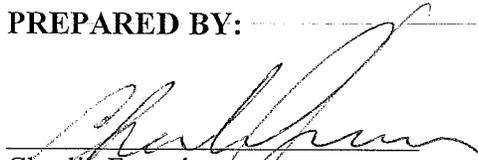
Charlie Francis
Administrative Services Director


REVIEWED BY:

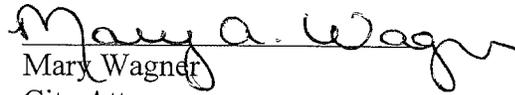
Mary Wagner
City Attorney

SUBMITTED BY:

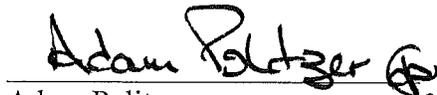
Adam Politzer
City Manager

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ATTACHMENT 1

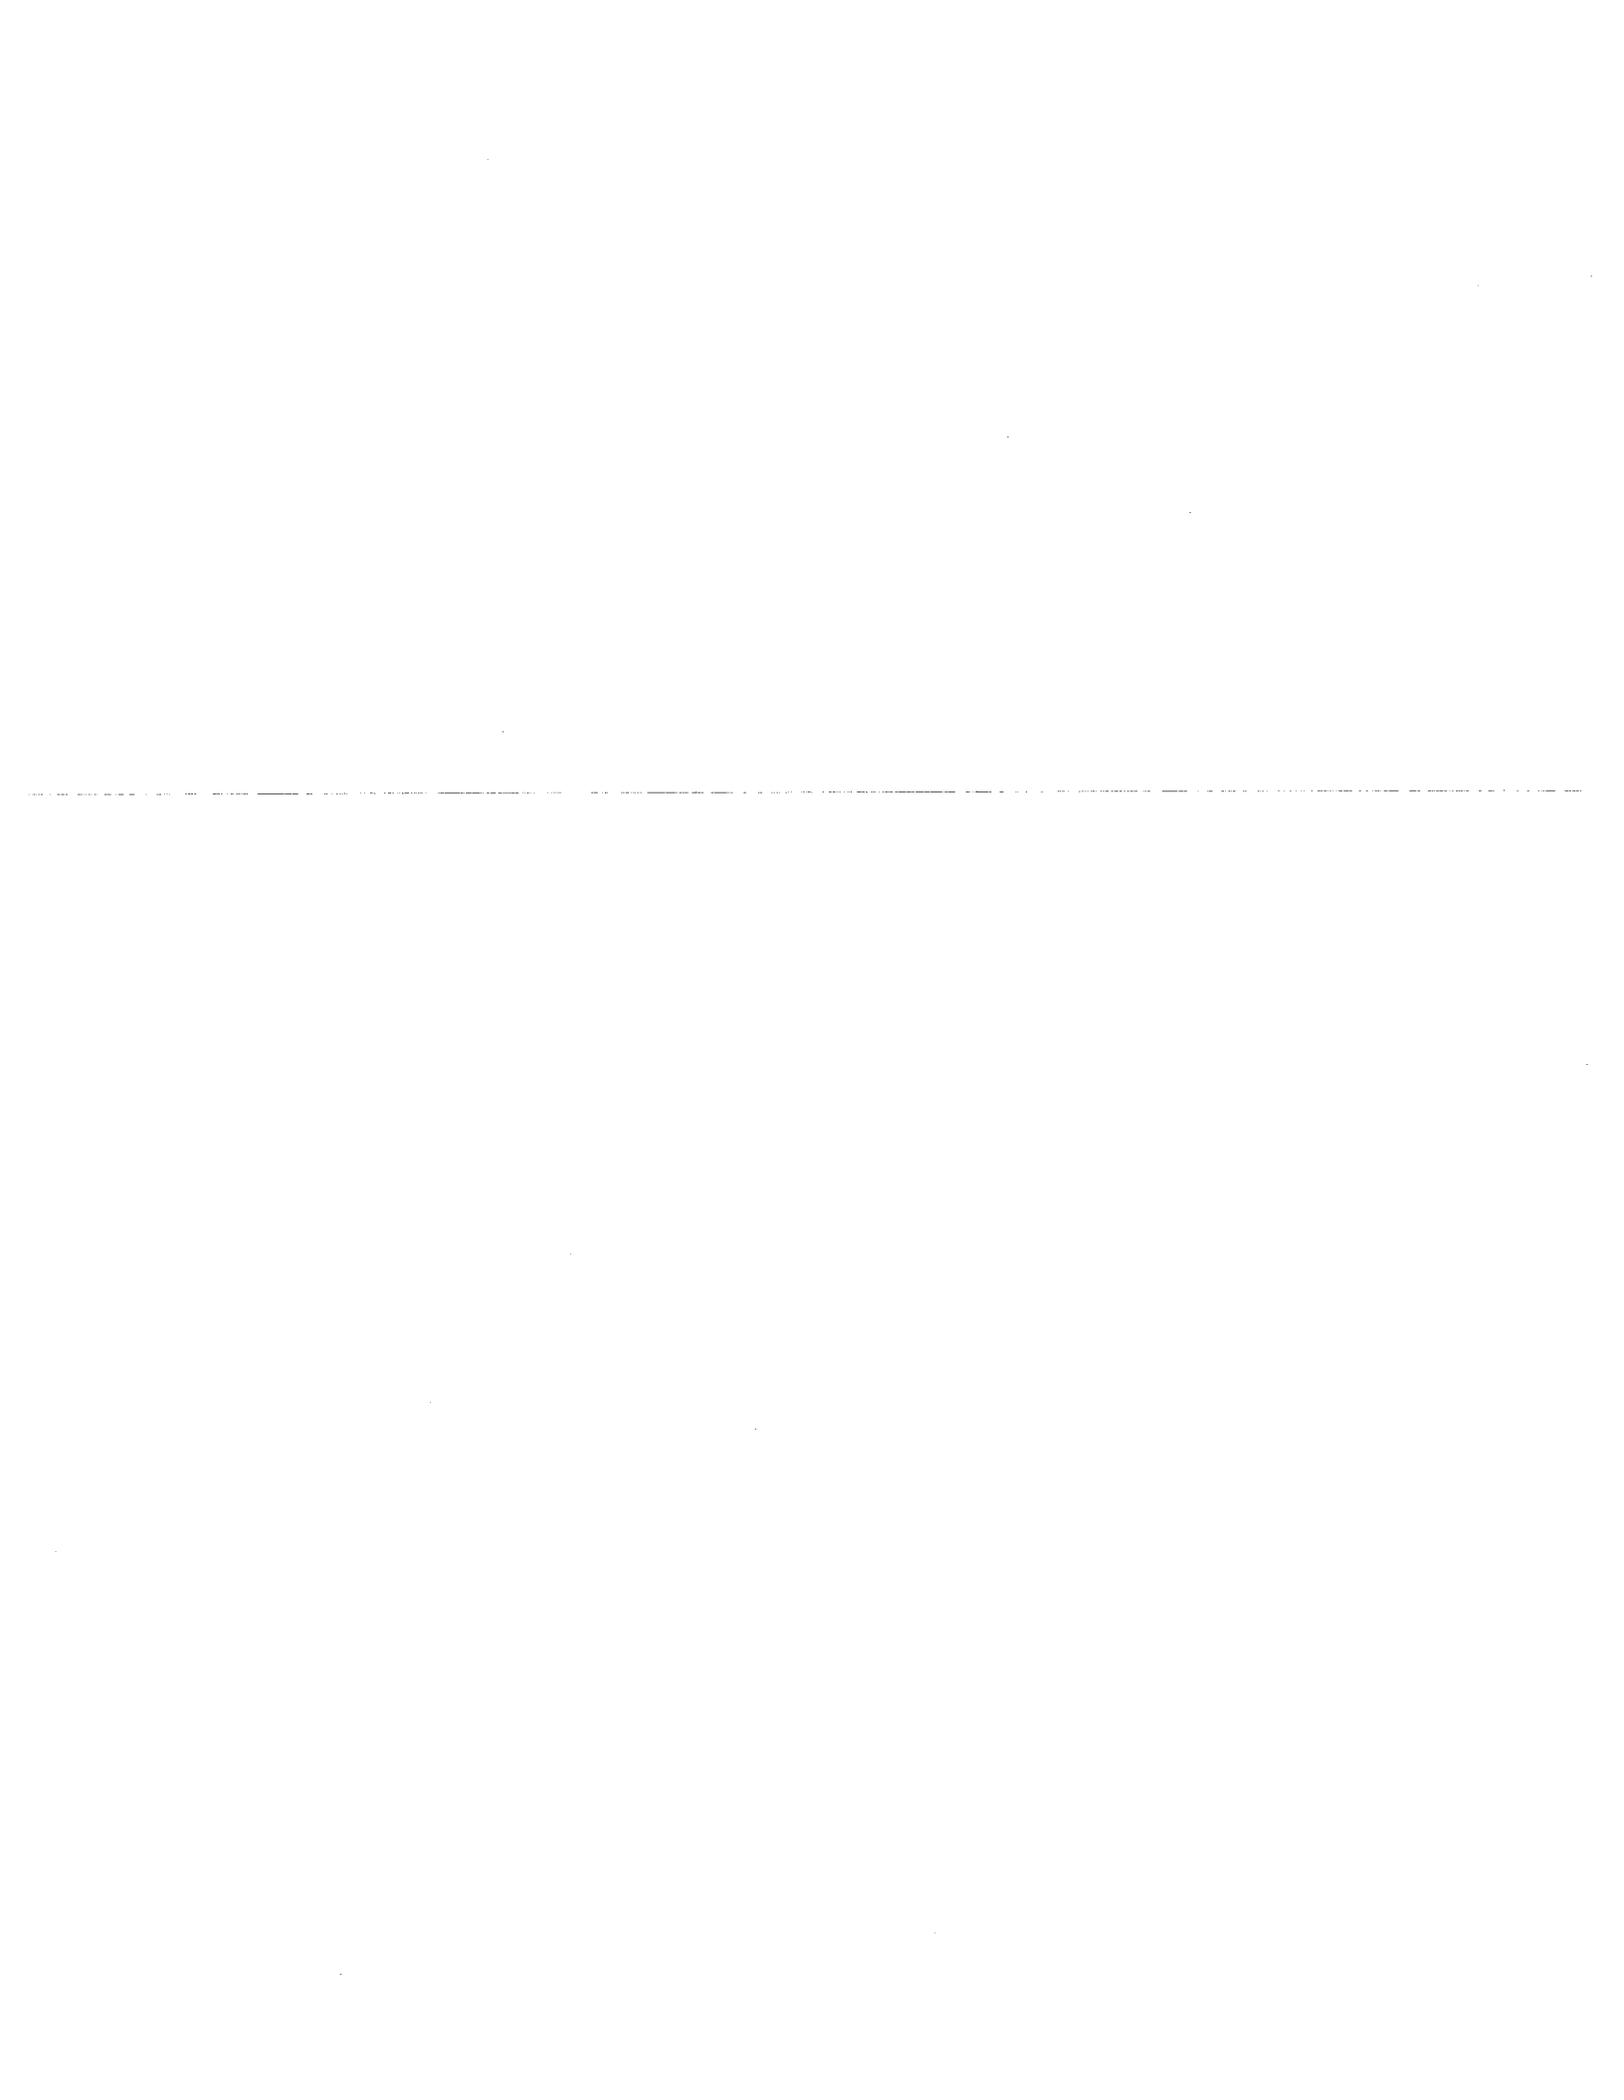Planning Commission Resolution 2009-30

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**SAUSALITO PLANNING COMMISSION
RESOLUTION NO. 2009-30**

**APPROVAL OF A CONDITIONAL USE PERMIT AND A DESIGN REVIEW PERMIT
FOR REPLACEMENT OF TWO EXISTING ANTENNAS AND INSTALLATION OF
TWO NEW ANTENNAS ON AN EXISTING MONOPOLE; INSTALLATION OF
EQUIPMENT IN AN EXISTING UNDERGROUND EQUIPMENT VAULT EAST OF THE
INTERSECTION OF RODEO AVENUE AND HIGHWAY 101
(CUP/DR 09-030)**

WHEREAS, on March 12, 2002 the City Council adopted Resolution 4584, approving a Conditional Use Permit and Design Review Permit (UP/DR 00-17) for the construction of a 35 foot tall monopole within the City-owned open space area southeast of the intersection of Rodeo Avenue and Highway 101 (064-181-40); and

WHEREAS, on March 19, 2009 an application was filed by Liz Johnson, on behalf of AT&T Mobility, requesting Planning Commission approval of a modification to a Conditional Use Permit and Design Review Permit for the replacement in-kind of two antennas and installation of two new antennas on an existing 35-foot tall monopole, and installation of equipment in an existing underground equipment vault east of the intersection of Rodeo Avenue and Highway 101; and

WHEREAS, the Planning Commission conducted a duly-noticed public hearing on July 1, 2009, at which time all interested persons were given an opportunity to be heard; and

WHEREAS, the Planning Commission has reviewed and considered the project plans titled "AT&T 2ND CARRIER MODS, 101 & RODEO, CNU4525", date stamped received March 19, 2009; and

WHEREAS, the Planning Commission has received and considered oral and written testimony on the subject application; and

WHEREAS, the Planning Commission has reviewed and considered the information contained in the staff reports dated July 1, 2009 for the proposed project; and

WHEREAS, the Planning Commission finds that the project is categorically exempt from California Environmental Quality Act (CEQA) pursuant to Sections 15302 and 15303 of the CEQA Guidelines; and

WHEREAS, the Planning Commission finds that, as conditioned herein, the proposed project complies with the requirements of the General Plan and Zoning Ordinance as described in the staff report dated July 1, 2009.

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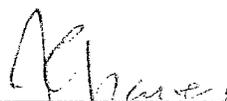
Project 6

NOW, THEREFORE, THE PLANNING COMMISSION HEREBY RESOLVES:

The Conditional Use Permit and Design Review Permit for the replacement in-kind of two antennas and installation of two new antennas on an existing 35-foot tall monopole, and installation of equipment in an existing underground equipment vault east of the intersection of Rodeo Avenue and Highway 101 are approved based upon the attached (Attachment 1), subject to the conditions of approval (Attachment 2) and as shown in the project plans titled "AT&T 2ND CARRIER MODS, 101 & RODEO, CNU4525," date stamped received March 19, 2009 (Attachment 3).

RESOLUTION PASSED AND ADOPTED, at the regular meeting of the Sausalito Planning Commission on the 1st day of July, 2009, by the following vote:

AYES: Commissioner: Cox, Bair, Keller
NOES: Commissioner:
ABSENT: Commissioner: Keegin, Stout
ABSTAIN: Commissioner:



Jeremy Graves, AICP
Secretary to the Planning Commission

ATTACHMENTS

- 1- Findings
- 2- Conditions of Approval
- 3- Project Plans

I:\CDD\PROJECTS - ADDRESS\M-R\Rodeo at 101(Wireless Site)\DR CUP 09-030\pcreso 7-1-09.doc

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PLANNING COMMISSION RESOLUTION

July 1, 2009

CUP/DR 09-030

Rodeo Avenue and Hwy 101

ATTACHMENT 1: FINDINGS

WIRELESS COMMUNICATIONS CONDITIONAL USE PERMIT AND DESIGN REVIEW PERMIT FINDINGS

Pursuant to Zoning Ordinance Section 10.45.020 (Conditional Use Permit and Design Review Approval for a Wireless Communications Facility), the Conditional Use Permit and Design Review Permit are approved based on the following findings:

A. The proposed project is consistent with the General Plan, the Zoning Ordinance, and any applicable specific plans.

The proposed project is consistent with all applicable policies, standards, and regulations of the General Plan and Zoning Ordinance.

B. The proposed project complements the surrounding neighborhood and/or district and, when antenna is attached to, or part of, a structure, the antenna and its screening complement the architecture of the structure.

The antennas and equipment would be installed to minimize visibility by being painted to match the existing antenna, associated equipment and monopole. Therefore, the antennas and related equipment are consistent with this standard.

C. The proposed project is consistent with the general scale of structures and buildings in the surrounding neighborhood and/or district.

The project is located in an open space area on an existing monopole. No additional bulk or height is proposed and therefore this finding does not apply.

D. The proposed project has been located and designed to minimize obstruction of public views and primary views from private property.

The existing wireless monopole may be viewed from a distance both from Highway 101, residences beyond the freeway to the west, and within the Open Space area. The new antennas and equipment would be installed to minimize visibility by being painted to match the existing antenna, associated equipment and monopole. The existing equipment vault is located underground, and therefore does not have an impact on public and private views.

E. The proposed project will not result in a prominent profile (silhouette) above a ridgeline.

The subject site is located directly below a ridgeline. The existing monopole is visible from Highway 101. The new antennas are proposed below the existing antennas and therefore will not be visible from the Highway. Therefore, the proposed project will not result in a prominent profile above the ridgeline.

F. The proposed landscaping provides appropriate visual relief, complements the buildings and structures on the site, and provides an attractive environment for the enjoyment of the public.

No landscaping is proposed as the proposed antennas and equipment would be located within an existing wireless communications facility and no landscape improvements are warranted.

G. Mechanical equipment is appropriately designed and located to minimize visual, noise, and air quality impacts to adjacent properties and the general public.

New equipment will be installed in the underground vault which is appropriately located to minimize visual, noise and air quality impacts to adjacent properties and the general public.

H. The proposed design preserves protected trees and significant natural features on the site to a reasonable extent and minimizes site degradation from construction activities and other potential impacts.

The project would have no affect on natural features on-site. No grading is proposed and construction will be limited to the installation of the antennas and associated equipment.

I. The proposed use, together with the applicable conditions, will not be detrimental to the public health, safety, or general welfare of the City.

The proposed use would comply with all applicable health regulations and would not be detrimental to the public health, safety, or general welfare of the City.

J. The proposed facility will not materially adversely affect nearby properties or their permitted uses.

The project would not have any significant affect on nearby properties, adverse or otherwise.

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PLANNING COMMISSION RESOLUTION

July 1, 2009

CUP/DR 09-030

Rodeo Avenue and Hwy 101

ATTACHMENT 2: CONDITIONS OF APPROVAL

These conditions of approval apply to the plans prepared by Jeffrey Rome and Associates, Inc., entitled "AT&T 2ND CARRIER MODS, 101 & RODEO, CNU4525", date stamped received March 19, 2009.

1. All conditions of approval listed in City Council Resolution No. 4584 for UP/DR 00-17 remain in effect. Prior to issuance of a building permit the applicant shall demonstrate compliance with Conditions of Approval 1, 2, 9, 12 and 13 in Resolution No. 4584.
2. Construction materials, equipment, vehicles, and debris boxes shall be placed to minimize obstruction of roads and gutters, shall be maintained in a clean and safe condition, and shall not be maintained in a manner that becomes a nuisance to the neighborhood.
3. No exterior security lighting may be installed on the subject site unless otherwise reviewed and approved by the Community Development Department and found to by staff to be consistent with Chapter 10.45 of the Zoning Ordinance.
4. No alternative or unrelated construction, site improvements, tree removal and/or alteration, exterior alterations and/or renovations shall be performed on the project site prior to commencement of construction of the proposed project. In such cases, this approval shall be rendered null and void unless approved by the Community Development Department as a modification to this approval.
5. The Applicant shall annually provide a written report to the Community Development Department evaluating the facility's compliance with all conditions of approval. The report shall be submitted no later than thirty (30) days following the anniversary of the approval of this permit. If the report is not provided in a timely manner or shows any conditions of approval are not being met, the Community Development Director shall schedule a public hearing to consider revocation of the permit. Additionally, a processing fee, as established by resolution of the City Council, shall be submitted concurrently with the report to pay for staff review and processing of the report, as well as the EMF exposure reports required by Section 10.45.110 of the Zoning Ordinance.
6. The biannual electromagnetic field (EMF) exposure reports required by Zoning Ordinance Section 10.45.110 shall be submitted within thirty (30) days of the anniversary of approval of this permit.
7. The applicant shall provide an affidavit certifying that the lease for the project does not prohibit co-location by other wireless providers, and that the applicant will do nothing to obstruct future co-location.

8. Normal testing and maintenance activities shall occur between the hours of 8am and 6pm Monday through Friday, excluding emergency repair.

Advisory Notes

Advisory notes are provided to inform the applicant of Sausalito Municipal Code requirements, and requirements imposed by other agencies. These requirements include, but are not limited to, the items listed below.

1. This approval will expire in five (5) years from the date of adoption of this resolution if the property owner has not exercised the entitlements hereby granted.
2. An approval granted by the Planning Commission does not constitute a building permit or authorization for construction. Appropriate construction permit(s) issued by the Building Division must be obtained prior to construction.
3. Pursuant to Zoning Ordinance Section 10.45.050, the applicant shall enter into a Performance Agreement with the City of Sausalito prior to the commencement of any construction on the cellular facility.

4. Pursuant to Zoning Ordinance Section 10.45.090, if use of a wireless communications facility ceases for one year or more the permit shall be deemed abandoned. The facility shall be dismantled and the premise restore in accordance with the procedures and standards listed in Section 10.45.090.
5. Pursuant to Zoning Ordinance Section 10.45.110, required EMF reports shall be paid for by the applicant and prepared by a third party consultant acceptable to the Community Development Director and using a testing protocol acceptable to the Community Development Director. All applicable City fees as established by City Council resolutions and ordinances shall be paid.
6. Within sixty (60) days of a wireless communications facility becoming operational, the applicant shall provide to the City a report indicating the actual EMF levels measured (pursuant to FCC protocol) at the property line or nearest point of public access, whichever is closer, in the direction of maximum radiation from each antenna. Reports shall specify signal levels with the site operating at full power and baseline levels with the site inoperative. Technical data shall be presented showing levels relative to the currently permitted Federal regulations. Raw measurements shall be provided as an appendix In addition, the report shall include, in lay terms, a summary of the technical data as presented in the report.
7. Pursuant to Zoning Ordinance Section 10.45.110.A, wireless communications facilities operating alone and in conjunction with other telecommunications facilities shall not generate electromagnetic field (EMF) exposure or other measurable radiation in excess of the standards for permissible human exposure, as provided by applicable Federal regulations.
8. Biannually, the operator of the antenna shall have EMF exposure levels tested and shall submit to the City written report of the results of the tests. On years when testing is not required, the operator of the antenna shall submit to the City written certification by an

independent licensed engineer that no modifications have been made to the facility design or configuration that have increased or will increase EMF exposure. If modifications have been made to the facility which have increased or will increase the EMF exposure, the applicant shall provide a supplemental report measuring the modified facility as set forth in Section 10.45.110(B) of the Zoning Ordinance.

9. Construction Impact Fees shall be paid in accordance with the Construction Impact Fee Ordinance. The fee is due prior to issuance of Building Permit.
10. Encroachment permit, grading permit, third party review fees (cost plus 10%) fees shall be paid.
11. An encroachment permit shall be obtained from the Public Works Department prior to using the public right of way for non-public purposes (e.g., material storage, sidewalk construction or demolition) including any and all construction and demolition activities.
12. Grading/drainage permit(s) shall be obtained from the Public Works Department for any earthwork in excess of 50 cubic yards.
13. Grading on hillside land with of geologic formation known to slide will be limited to between April 15 and October 15 without written approval of the City Engineer.
14. Pursuant to Municipal Code Chapter 8.54, applicants shall submit a Recycling Management Plan to the Community Development Department prior to the issuance of any construction permits, unless the requirement is waived pursuant to Section 8.54.050.
15. Pursuant to Municipal Code Chapter 11.17, dumping of residues from washing of painting tools, concrete trucks and pumps, rock, sand, dirt, agricultural waste, or any other materials discharged into the City storm drain system that is not composed entirely of storm water is prohibited. Liability for any such discharge shall be the responsibility of person(s) causing or responsible for the discharge. Violations constitute a misdemeanor in accordance with Section 11.17.060.B.
16. Pursuant to Municipal Code Section 12.16.140, the operation of construction, demolition, excavation, alteration, or repair devices and equipment within all residential zones and areas within a 500 foot radius of residential zones shall only take place during the following hours:
Weekdays – Between 8:00 a.m. and 7:00 p.m.
Saturdays – Between 9:00 a.m. and 5:00 p.m.
Sundays – Prohibited
Holidays recognized by the City – Between 9:00 a.m. and 7:00 p.m.

Homeowners currently residing on the property and other legal residents may operate the equipment themselves on Sundays between 9:00 a.m. and 7:00 p.m.
17. Permits required by other agencies having jurisdiction within the construction area must be obtained in accordance with the respective agency's regulations.
 - a. Marin Municipal Water District – (415-945-1400), including landscaping and irrigation regulations;

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- b. Southern Marin Fire Protection District – (415-388-8182); and
- c. Bay Conservation and Development Commission – (415-352-3600).

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PLANNING COMMISSION RESOLUTION
July 1, 2009
CUP/DR 09-030
Rodeo Avenue and Hwy 101

ATTACHMENT 3: PROJECT PLANS

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HLB Review Criteria- 50-year review- Finding of No Significance:

1 hour...Counter application review and acceptance

.5 hour....routing memo and route the project to HLB for assignment of Historic Significance Memo

.75 hour...study session memo for HLB packet

.5 hour...HLB review

TOTAL: 2.75 Hours

HLB Review Criteria- 50-year review- Finding of Significance:

1 hour...Counter application review and acceptance

.5 hour....routing memo and route the project to HLB for assignment of Historic Significance Memo

.75 hour...study session memo for HLB packet

2 hours...HLB review

TOTAL: 4.25 Hours

HLB Review for Historic District & Noteworthy Structures

1 hour...Study Session memo for HLB packet


2 hours...HLB review and recommendation

TOTAL: 3 Hours

I:\CDD\Boards & Committees\HLB\Fees\Estimated Review Time.docx

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at&t

CNU4525/101 & RODEO 101 RODEO AVENUE SAUSALITO, CALIFORNIA 94965

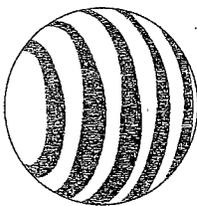CONSULTANT TEAM

CLIENTS REPRESENTATIVE
BLACK DOT WIRELESS
326 COMMERCIAL
SAN FRANCISCO, CALIFORNIA 94102
PHONE: (415) 855-3800
FAX: (415) 271-7440

SITE ACQUISITION
LEE JOHNSON
PHONE: (424) 845-1333

CONSTRUCTION MANAGER
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PHONE: (949) 789-3329
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ARCHITECT
JEFFREY ROSE & ASSOCIATES
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NEWPORT BEACH, CALIFORNIA 92660
PHONE: (949) 789-3329
CELLULAR: (408) 968-8810
FAX: (949) 789-3330
CONTACT: JESSE JAMES VALERO

SPECIAL INSPECTIONS

1. ALL VERIFY SOIL CONDITIONS ARE SUBSTANTIALLY AS SHOWN ON THE GEOTECHNICAL REPORT

2. ALL CONCRETE SHALL BE PLACED WITHIN THE SPECIFIED TIME FRAME

3. ALL CONCRETE SHALL BE PLACED WITHIN THE SPECIFIED TIME FRAME

4. ALL STRUCTURAL STEEL SHALL BE WELDED TO THE SPECIFIED REQUIREMENTS

5. ALL STRUCTURAL STEEL SHALL BE WELDED TO THE SPECIFIED REQUIREMENTS

6. ALL STRUCTURAL STEEL SHALL BE WELDED TO THE SPECIFIED REQUIREMENTS

7. ALL STRUCTURAL STEEL SHALL BE WELDED TO THE SPECIFIED REQUIREMENTS


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11. ALL STRUCTURAL STEEL SHALL BE WELDED TO THE SPECIFIED REQUIREMENTS

12. ALL STRUCTURAL STEEL SHALL BE WELDED TO THE SPECIFIED REQUIREMENTS



SHEET INDEX

T-1 TITLE SHEET
T-2 SPECIFICATIONS AND NOTES
A-0 SITE PLAN
A-1 EXISTING UTILITIES PLAN
A-1.1 EXISTING ELEVATIONS NORTHWEST AND SOUTHEAST
A-1.2 EXISTING ELEVATIONS NORTHWEST AND SOUTHWEST
A-2 PROPOSED ELEVATIONS NORTHWEST AND SOUTHWEST
A-2.1 PROPOSED ELEVATIONS NORTHWEST AND SOUTHWEST
A-2.2 PROPOSED ELEVATIONS NORTHWEST AND SOUTHWEST
A-3 SITE SECTION

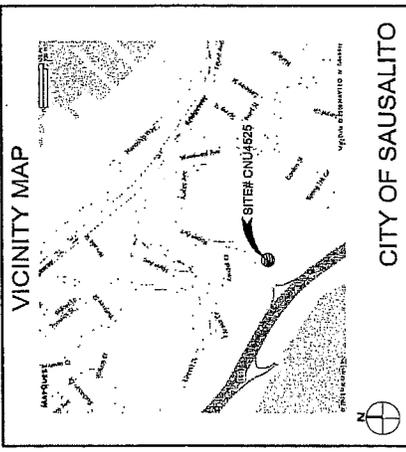APPLICABLE CODES

ALL WORK SHALL COMPLY WITH THE FOLLOWING APPLICABLE CODES:

2007 CALIFORNIA BUILDING CODE AND LOCAL ORDINANCES
2007 CALIFORNIA MECHANICAL CODE AND LOCAL ORDINANCES
2007 CALIFORNIA ELECTRICAL CODE AND LOCAL ORDINANCES
2007 CALIFORNIA PLUMBING CODE AND LOCAL ORDINANCES

IN THE EVENT OF CONFLICT, THE MOST RESTRICTIVE CODE SHALL PREVAIL.

ACCESSIBILITY DISCLAIMER

THIS PROJECT IS AN UNOCCUPIED WIRELESS FOR TELECOMMUNICATIONS FACILITY AND IS EXEMPT FROM DISABLED ACCESS REQUIREMENTS.

SCALE

THE DRAWING SCALES SHOWN IN THIS SET REPRESENT THE CORRECT SCALE ONLY WHEN THESE DRAWINGS ARE PRINTED IN A 24"x36" FORMAT. IF THIS DRAWING SET IS NOT A 24"x36", THIS SET IS NOT TO SCALE.

DEVELOPMENT SUMMARY

APPLICANT: WIRELESS MOBILITY
4435 ROBERTSDORF DRIVE
PULVERMONT, CALIFORNIA 94988

OWNER: CITY OF SAUSALITO
101 RODEO AVENUE
SAUSALITO, CALIFORNIA 94965

OTHER ON-SITE TELECOM FACILITIES: YES
PROJECT ADDRESS: 101 RODEO AVENUE
SAUSALITO, CALIFORNIA 94965

ASSESSORS PARCEL NUMBER: 84-181-040
LANDMARK: 37-85807
LATITUDE: -122.57
LAY/LINER TYPE: N/A-83
EXISTING ZONING: TBO
PROPOSED PROJECT AREA: NO INCREASE IN S.F.
EXISTING TYPE OF CONSTRUCTION: TYPE V-B
PROPOSED TYPE OF CONSTRUCTION: TYPE V-B
EXISTING OCCUPANCY: U-2
JURISDICTION: CITY OF SAUSALITO
PERMITS: NO DRAWING REQUIRED

PROJECT DESCRIPTION

WIRELESS MOBILITY PROPPOSES TO CONSTRUCT, OPERATE AND MAINTAIN AN UNOCCUPIED WIRELESS COMMUNICATIONS FACILITY. THIS FACILITY WILL CONSIST OF THE FOLLOWING:

- REMOVE (1) (2) TOWER EQUIPMENT CABINET.
- INSTALL (1) (2) TOWER EQUIPMENT CABINET.

ACCESSIBILITY DISCLAIMER

THIS PROJECT IS AN UNOCCUPIED WIRELESS FOR TELECOMMUNICATIONS FACILITY AND IS EXEMPT FROM DISABLED ACCESS REQUIREMENTS.

SCALE

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JRA Jeffrey Rose & Associates, Inc. Athens • California • Nevada ARIZONA: (520) 284-4379 CALIFORNIA: (415) 790-3379 NEVADA: (702) 795-0559	PROPRIETARY INFORMATION THE INFORMATION CONTAINED HEREIN IS THE PROPERTY OF JRA. IT IS TO BE USED ONLY FOR THE PROJECT AND SITE SPECIFICALLY IDENTIFIED. NO PART OF THIS INFORMATION IS TO BE REPRODUCED OR TRANSMITTED IN ANY FORM OR BY ANY MEANS, ELECTRONIC OR MECHANICAL, INCLUDING PHOTOCOPYING, RECORDING, OR BY ANY INFORMATION STORAGE AND RETRIEVAL SYSTEM, WITHOUT THE WRITTEN PERMISSION OF JRA.
APPLICANT 	OWNER 4435 ROBERTSDORF DRIVE PULVERMONT, CALIFORNIA 94988
PROJECT ADDRESS 101 RODEO AVENUE SAUSALITO, CALIFORNIA 94965	PERMITS DRAWING DATES 01/16/09 01/27/09 02/17/09 03/10/09 03/10/09
APPROVALS CITY OF SAUSALITO PLANNING DEPARTMENT (P1) PLANNING DEPARTMENT (P4)	REVISIONS REVISION A-2 REVISION A-3 REVISION A-4 REVISION A-5 REVISION A-6 REVISION A-7 REVISION A-8 REVISION A-9 REVISION A-10 REVISION A-11 REVISION A-12 REVISION A-13 REVISION A-14 REVISION A-15 REVISION A-16 REVISION A-17 REVISION A-18 REVISION A-19 REVISION A-20 REVISION A-21 REVISION A-22 REVISION A-23 REVISION A-24 REVISION A-25 REVISION A-26 REVISION A-27 REVISION A-28 REVISION A-29 REVISION A-30
PROJECT NAME AT&T 2ND CARRIER MODS SITE NUMBER CNU4525	TITLE SHEET SHEET TITLE

RECEIVED

MAR 19 2009

CITY OF SAUSALITO
COMMUNITY DEVELOPMENT

JRA
Jeffrey Berra & Associates, Inc.
Attorneys • Architects • Engineers
ARIZONA (602) 254-5577
CALIFORNIA (415) 947-5277
KANSAS (913) 742-0825

PROPRIETARY INFORMATION
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at&t
APPLICANT
1430 ROSEWOOD DRIVE
PLACERDOME, CALIFORNIA 95864
OWNER
420 UNION STREET
SUITE 210
SACRAMENTO, CALIFORNIA 95833
APPROVALS

R.F.	DATE
ZONING	DATE
CONSTRUCTION	DATE
SITE ACQUISITION	DATE
OWNER APPROVAL	DATE

AT&T 2ND CARRIER HODS
101 AT&T VIDEO
515 VIDEO
SHEET NUMBER
CNU4523
PROJECT NAME
PROJECT ADDRESS
101 TOWER AVENUE
SACRAMENTO, CALIFORNIA 95833
APN NUMBER
44-130-02-101
DRAWING DATES
12/19/88
9/24/89 (P1)
02/11/89
02/14/89
PLANNING COMMENTS (P4)
03/03/89

SPECIFICATIONS AND NOTES

SHEET TITLE	
REVISION	DATE

STRUCTURAL SPECIFICATIONS

7. **WIND** PREPARATION OF CONCRETE SHALL CONFORM TO ASTM C-44, NO MORE THAN 10 UNITS SHALL EXPOSE BETWEEN THE FACE OF CONCRETE AND THE FORMWORK SURFACE APPROVED BY A TESTING AGENCY.

8. **SEGREGATION OF AGGREGATES** CONCRETE SHALL NOT BE FLOPPED THROUGH REINFORCING STEEL (AS IN WALLS, COLUMNS, CORNERS, OR OTHER LOCATIONS) OR ALLOWED TO SETTLE OR SLURRY. UNLESS OTHERWISE NOTED, ALL MIXTURES SHALL BE PLACED AND CONSOLIDATED WITHIN 15 MINUTES OF MIXING. UNLESS OTHERWISE NOTED, ALL MIXTURES SHALL BE PLACED AND CONSOLIDATED WITHIN 15 MINUTES OF MIXING.

9. **REINFORCING STEEL** SHALL BE LAPPELLED A MINIMUM OF 30 BAR DIAMETERS AND SHALL BE LAPPELLED A MINIMUM OF 10 BAR DIAMETERS AT TOP AND BOTTOM. UNLESS OTHERWISE NOTED, ALL REINFORCING SHALL BE PLACED AT THE FACE OF THE MEMBER TO BE REINFORCED.

10. **REINFORCEMENT** SHALL BE PLACED IN A MANNER WHICH WILL NOT CAUSE WEAK SPOTS OR POINTS OF CONCENTRATED STRESS. UNLESS OTHERWISE NOTED, ALL REINFORCEMENT SHALL BE PLACED AT THE FACE OF THE MEMBER TO BE REINFORCED.

11. **CONCRETE** IN CONTACT WITH EARTH, UNLESS OTHERWISE NOTED, SHALL BE PLACED AND FINISHED WITH A FINISH AS FOLLOWS:
 A. CONCRETE IN CONTACT WITH EARTH, FINISHED WITH A FINISH AS FOLLOWS:
 B. CONCRETE IN CONTACT WITH EARTH, FINISHED WITH A FINISH AS FOLLOWS:
 C. WALL, EXTERIOR FACE
 D. WALL, INTERIOR FACE
 E. STRUCTURAL JOISTS
 F. JOISTS

12. **BEARING CAPACITY** SHALL BE MAINTAINED THROUGHOUT THE LIFE OF THE STRUCTURE. UNLESS OTHERWISE NOTED, ALL STRUCTURES SHALL BE DESIGNED TO WITHSTAND A WIND SPEED OF 130 MPH AS SPECIFIED IN THE LOCAL CODES. UNLESS OTHERWISE NOTED, ALL STRUCTURES SHALL BE DESIGNED TO WITHSTAND A WIND SPEED OF 130 MPH AS SPECIFIED IN THE LOCAL CODES.

13. **ANCHORING** SHALL BE MAINTAINED THROUGHOUT THE LIFE OF THE STRUCTURE. UNLESS OTHERWISE NOTED, ALL ANCHORS SHALL BE DESIGNED TO WITHSTAND A WIND SPEED OF 130 MPH AS SPECIFIED IN THE LOCAL CODES.

14. **CURING** SHALL BE MAINTAINED THROUGHOUT THE LIFE OF THE STRUCTURE. UNLESS OTHERWISE NOTED, ALL CONCRETE SHALL BE CURIED TO A MINIMUM CURE OF 7 DAYS.

15. **CONCRETE** SHALL BE PLACED AND FINISHED WITHIN 15 MINUTES OF MIXING. UNLESS OTHERWISE NOTED, ALL CONCRETE SHALL BE PLACED AND FINISHED WITHIN 15 MINUTES OF MIXING.

16. **REINFORCING STEEL** SHALL BE PLACED AND FINISHED WITHIN 15 MINUTES OF MIXING. UNLESS OTHERWISE NOTED, ALL REINFORCING SHALL BE PLACED AND FINISHED WITHIN 15 MINUTES OF MIXING.

17. **WELDING** SHALL BE PERFORMED IN ACCORDANCE WITH THE AMERICAN WELDING SOCIETY (AWS) D1.1 SPECIFICATION FOR STEEL WELDING. UNLESS OTHERWISE NOTED, ALL WELDING SHALL BE PERFORMED IN ACCORDANCE WITH THE AMERICAN WELDING SOCIETY (AWS) D1.1 SPECIFICATION FOR STEEL WELDING.

18. **STEEL** SHALL BE PLACED AND FINISHED WITHIN 15 MINUTES OF MIXING. UNLESS OTHERWISE NOTED, ALL STEEL SHALL BE PLACED AND FINISHED WITHIN 15 MINUTES OF MIXING.

19. **PAINTING** SHALL BE PERFORMED IN ACCORDANCE WITH THE AMERICAN PAINT AND COLOUR MANUFACTURERS ASSOCIATION (APCA) SPECIFICATION FOR PAINTING. UNLESS OTHERWISE NOTED, ALL PAINTING SHALL BE PERFORMED IN ACCORDANCE WITH THE AMERICAN PAINT AND COLOUR MANUFACTURERS ASSOCIATION (APCA) SPECIFICATION FOR PAINTING.

20. **FINISHES** SHALL BE PERFORMED IN ACCORDANCE WITH THE AMERICAN PAINT AND COLOUR MANUFACTURERS ASSOCIATION (APCA) SPECIFICATION FOR FINISHES. UNLESS OTHERWISE NOTED, ALL FINISHES SHALL BE PERFORMED IN ACCORDANCE WITH THE AMERICAN PAINT AND COLOUR MANUFACTURERS ASSOCIATION (APCA) SPECIFICATION FOR FINISHES.

21. **FOUNDATION** SHALL BE PERFORMED IN ACCORDANCE WITH THE AMERICAN WELDING SOCIETY (AWS) D1.1 SPECIFICATION FOR FOUNDATION. UNLESS OTHERWISE NOTED, ALL FOUNDATION SHALL BE PERFORMED IN ACCORDANCE WITH THE AMERICAN WELDING SOCIETY (AWS) D1.1 SPECIFICATION FOR FOUNDATION.

22. **ROOFING** SHALL BE PERFORMED IN ACCORDANCE WITH THE AMERICAN WELDING SOCIETY (AWS) D1.1 SPECIFICATION FOR ROOFING. UNLESS OTHERWISE NOTED, ALL ROOFING SHALL BE PERFORMED IN ACCORDANCE WITH THE AMERICAN WELDING SOCIETY (AWS) D1.1 SPECIFICATION FOR ROOFING.

23. **MECHANICAL** SHALL BE PERFORMED IN ACCORDANCE WITH THE AMERICAN WELDING SOCIETY (AWS) D1.1 SPECIFICATION FOR MECHANICAL. UNLESS OTHERWISE NOTED, ALL MECHANICAL SHALL BE PERFORMED IN ACCORDANCE WITH THE AMERICAN WELDING SOCIETY (AWS) D1.1 SPECIFICATION FOR MECHANICAL.

24. **ELECTRICAL** SHALL BE PERFORMED IN ACCORDANCE WITH THE AMERICAN WELDING SOCIETY (AWS) D1.1 SPECIFICATION FOR ELECTRICAL. UNLESS OTHERWISE NOTED, ALL ELECTRICAL SHALL BE PERFORMED IN ACCORDANCE WITH THE AMERICAN WELDING SOCIETY (AWS) D1.1 SPECIFICATION FOR ELECTRICAL.

25. **PLUMBING** SHALL BE PERFORMED IN ACCORDANCE WITH THE AMERICAN WELDING SOCIETY (AWS) D1.1 SPECIFICATION FOR PLUMBING. UNLESS OTHERWISE NOTED, ALL PLUMBING SHALL BE PERFORMED IN ACCORDANCE WITH THE AMERICAN WELDING SOCIETY (AWS) D1.1 SPECIFICATION FOR PLUMBING.

26. **MECHANICAL** SHALL BE PERFORMED IN ACCORDANCE WITH THE AMERICAN WELDING SOCIETY (AWS) D1.1 SPECIFICATION FOR MECHANICAL. UNLESS OTHERWISE NOTED, ALL MECHANICAL SHALL BE PERFORMED IN ACCORDANCE WITH THE AMERICAN WELDING SOCIETY (AWS) D1.1 SPECIFICATION FOR MECHANICAL.

27. **GENERAL** SHALL BE PERFORMED IN ACCORDANCE WITH THE AMERICAN WELDING SOCIETY (AWS) D1.1 SPECIFICATION FOR GENERAL. UNLESS OTHERWISE NOTED, ALL GENERAL SHALL BE PERFORMED IN ACCORDANCE WITH THE AMERICAN WELDING SOCIETY (AWS) D1.1 SPECIFICATION FOR GENERAL.

PAINTING NOTES & SPECIFICATIONS

1. **GENERAL**
 1. ALL PAINT PRODUCT LABELS SHALL BE KEPT ON HAND UNLESS SPECIFICALLY NOTED OTHERWISE.

2. CONTRACTOR SHALL PREPARE ALL SURFACES AND APPLY ALL FINISHES FOR EACH ITEM OF WORK IN ACCORDANCE WITH THE SPECIFICATIONS AND THE CITY OF SACRAMENTO ORDINANCES.

3. CONTRACTOR SHALL PROTECT ALL SURFACES AND FINISHES FROM DAMAGE DURING THE COURSE OF WORK. UNLESS OTHERWISE NOTED, ALL SURFACES AND FINISHES SHALL BE KEPT IN GOOD CONDITION THROUGHOUT THE COURSE OF WORK.

4. **PAINTING**
 1. PAINT THE FOLLOWING MATERIALS AND SYSTEMS CHECKED BELOW WITH THE COATING SYSTEM INDICATED.

2. PAINT THE FOLLOWING MATERIALS AND SYSTEMS CHECKED BELOW WITH THE COATING SYSTEM INDICATED.

3. PAINT THE FOLLOWING MATERIALS AND SYSTEMS CHECKED BELOW WITH THE COATING SYSTEM INDICATED.

ITEM	PAINTING SYSTEM
1	1. ALL EXPOSED METAL SHALL BE HOT-DIPPED GALVANNEED.
2	2. ALL EXPOSED METAL SHALL BE HOT-DIPPED GALVANNEED.
3	3. ALL EXPOSED METAL SHALL BE HOT-DIPPED GALVANNEED.
4	4. ALL EXPOSED METAL SHALL BE HOT-DIPPED GALVANNEED.
5	5. ALL EXPOSED METAL SHALL BE HOT-DIPPED GALVANNEED.
6	6. ALL EXPOSED METAL SHALL BE HOT-DIPPED GALVANNEED.
7	7. ALL EXPOSED METAL SHALL BE HOT-DIPPED GALVANNEED.
8	8. ALL EXPOSED METAL SHALL BE HOT-DIPPED GALVANNEED.
9	9. ALL EXPOSED METAL SHALL BE HOT-DIPPED GALVANNEED.
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11	11. ALL EXPOSED METAL SHALL BE HOT-DIPPED GALVANNEED.
12	12. ALL EXPOSED METAL SHALL BE HOT-DIPPED GALVANNEED.
13	13. ALL EXPOSED METAL SHALL BE HOT-DIPPED GALVANNEED.
14	14. ALL EXPOSED METAL SHALL BE HOT-DIPPED GALVANNEED.
15	15. ALL EXPOSED METAL SHALL BE HOT-DIPPED GALVANNEED.
16	16. ALL EXPOSED METAL SHALL BE HOT-DIPPED GALVANNEED.
17	17. ALL EXPOSED METAL SHALL BE HOT-DIPPED GALVANNEED.
18	18. ALL EXPOSED METAL SHALL BE HOT-DIPPED GALVANNEED.
19	19. ALL EXPOSED METAL SHALL BE HOT-DIPPED GALVANNEED.
20	20. ALL EXPOSED METAL SHALL BE HOT-DIPPED GALVANNEED.
21	21. ALL EXPOSED METAL SHALL BE HOT-DIPPED GALVANNEED.
22	22. ALL EXPOSED METAL SHALL BE HOT-DIPPED GALVANNEED.
23	23. ALL EXPOSED METAL SHALL BE HOT-DIPPED GALVANNEED.
24	24. ALL EXPOSED METAL SHALL BE HOT-DIPPED GALVANNEED.
25	25. ALL EXPOSED METAL SHALL BE HOT-DIPPED GALVANNEED.
26	26. ALL EXPOSED METAL SHALL BE HOT-DIPPED GALVANNEED.
27	27. ALL EXPOSED METAL SHALL BE HOT-DIPPED GALVANNEED.
28	28. ALL EXPOSED METAL SHALL BE HOT-DIPPED GALVANNEED.
29	29. ALL EXPOSED METAL SHALL BE HOT-DIPPED GALVANNEED.
30	30. ALL EXPOSED METAL SHALL BE HOT-DIPPED GALVANNEED.
31	31. ALL EXPOSED METAL SHALL BE HOT-DIPPED GALVANNEED.
32	32. ALL EXPOSED METAL SHALL BE HOT-DIPPED GALVANNEED.
33	33. ALL EXPOSED METAL SHALL BE HOT-DIPPED GALVANNEED.
34	34. ALL EXPOSED METAL SHALL BE HOT-DIPPED GALVANNEED.
35	35. ALL EXPOSED METAL SHALL BE HOT-DIPPED GALVANNEED.
36	36. ALL EXPOSED METAL SHALL BE HOT-DIPPED GALVANNEED.
37	37. ALL EXPOSED METAL SHALL BE HOT-DIPPED GALVANNEED.
38	38. ALL EXPOSED METAL SHALL BE HOT-DIPPED GALVANNEED.
39	39. ALL EXPOSED METAL SHALL BE HOT-DIPPED GALVANNEED.
40	40. ALL EXPOSED METAL SHALL BE HOT-DIPPED GALVANNEED.
41	41. ALL EXPOSED METAL SHALL BE HOT-DIPPED GALVANNEED.
42	42. ALL EXPOSED METAL SHALL BE HOT-DIPPED GALVANNEED.
43	43. ALL EXPOSED METAL SHALL BE HOT-DIPPED GALVANNEED.
44	44. ALL EXPOSED METAL SHALL BE HOT-DIPPED GALVANNEED.
45	45. ALL EXPOSED METAL SHALL BE HOT-DIPPED GALVANNEED.
46	46. ALL EXPOSED METAL SHALL BE HOT-DIPPED GALVANNEED.
47	47. ALL EXPOSED METAL SHALL BE HOT-DIPPED GALVANNEED.
48	48. ALL EXPOSED METAL SHALL BE HOT-DIPPED GALVANNEED.
49	49. ALL EXPOSED METAL SHALL BE HOT-DIPPED GALVANNEED.
50	50. ALL EXPOSED METAL SHALL BE HOT-DIPPED GALVANNEED.

5. **FINISHES**
 1. ALL FINISHES SHALL BE APPLIED TO ALL SURFACES AND FINISHES FOR EACH ITEM OF WORK IN ACCORDANCE WITH THE SPECIFICATIONS AND THE CITY OF SACRAMENTO ORDINANCES.

2. ALL FINISHES SHALL BE APPLIED TO ALL SURFACES AND FINISHES FOR EACH ITEM OF WORK IN ACCORDANCE WITH THE SPECIFICATIONS AND THE CITY OF SACRAMENTO ORDINANCES.

3. ALL FINISHES SHALL BE APPLIED TO ALL SURFACES AND FINISHES FOR EACH ITEM OF WORK IN ACCORDANCE WITH THE SPECIFICATIONS AND THE CITY OF SACRAMENTO ORDINANCES.

6. **ROOFING**
 1. ROOFING SHALL BE PERFORMED IN ACCORDANCE WITH THE AMERICAN WELDING SOCIETY (AWS) D1.1 SPECIFICATION FOR ROOFING. UNLESS OTHERWISE NOTED, ALL ROOFING SHALL BE PERFORMED IN ACCORDANCE WITH THE AMERICAN WELDING SOCIETY (AWS) D1.1 SPECIFICATION FOR ROOFING.

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GENERAL SPECIFICATIONS

1. THE LATEST EDITION OF THE AMERICAN INSTITUTE OF ARCHITECTS' BOUQUARD SHALL BE REFERRED TO AS THE "BOUQUARD" THROUGHOUT THESE DOCUMENTS.

2. THE LATEST EDITION OF THE AMERICAN WELDING SOCIETY (AWS) D1.1 SPECIFICATION FOR STEEL WELDING SHALL BE REFERRED TO AS THE "AWS D1.1" THROUGHOUT THESE DOCUMENTS.

3. THE LATEST EDITION OF THE AMERICAN PAINT AND COLOUR MANUFACTURERS ASSOCIATION (APCA) SPECIFICATION FOR PAINTING SHALL BE REFERRED TO AS THE "APCA" THROUGHOUT THESE DOCUMENTS.

4. THE LATEST EDITION OF THE AMERICAN WELDING SOCIETY (AWS) D1.1 SPECIFICATION FOR FOUNDATION SHALL BE REFERRED TO AS THE "AWS D1.1" THROUGHOUT THESE DOCUMENTS.

5. THE LATEST EDITION OF THE AMERICAN WELDING SOCIETY (AWS) D1.1 SPECIFICATION FOR ROOFING SHALL BE REFERRED TO AS THE "AWS D1.1" THROUGHOUT THESE DOCUMENTS.

6. THE LATEST EDITION OF THE AMERICAN WELDING SOCIETY (AWS) D1.1 SPECIFICATION FOR MECHANICAL SHALL BE REFERRED TO AS THE "AWS D1.1" THROUGHOUT THESE DOCUMENTS.

7. THE LATEST EDITION OF THE AMERICAN WELDING SOCIETY (AWS) D1.1 SPECIFICATION FOR ELECTRICAL SHALL BE REFERRED TO AS THE "AWS D1.1" THROUGHOUT THESE DOCUMENTS.

8. THE LATEST EDITION OF THE AMERICAN WELDING SOCIETY (AWS) D1.1 SPECIFICATION FOR GENERAL SHALL BE REFERRED TO AS THE "AWS D1.1" THROUGHOUT THESE DOCUMENTS.

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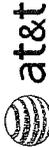
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24. THE LATEST EDITION OF THE AMERICAN WELDING SOCIETY (AWS) D1.1 SPECIFICATION FOR GENERAL SHALL BE REFERRED TO AS THE "AWS D1.1" THROUGHOUT THESE DOCUMENTS.

JRA
 Jeffrey Remy & Associates, Inc.
 Alhambra • California • Inland Empire
 ANIMONIA (626) 284-5074
 CALIFORNIA (949) 740-3332
 NEWARK (714) 781-8859

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APPLICANT

 4130 ROSEWOOD DRIVE
 PLEASANTON, CALIFORNIA 94588
 DRIVER
 CITY OF SAUSALITO
 SAUSALITO, CALIFORNIA 94865
 APPROVALS


R.F.	DATE
ZONING	DATE
CONSTRUCTION	DATE
SITE ACQUISITION	DATE
OWNER APPROVAL	DATE

PROJECT NAME
 AT&T 2ND CARRIER MODS
SITE NO.
 101
PROJECT ADDRESS
 101 WOOD AVENUE
 SAUSALITO, CALIFORNIA 94865
APN NUMBER
 84-10-12-010
DRAWING DATES
 07/10/08 PER 20 REVIEW (P1)
 07/16/08 PER 20 REVIEW (P2)
 07/23/08 PER 20 REVIEW (P3)
 07/23/08 PER 20 REVIEW (P4)

ISSUE REVISION 4.2
SHEET TITLE
 SITE PLAN

A-0

- SITE PLAN KEYNOTES**
- 1 (E) EXISTING ANTENNAS AND (E) ANTENNAS TO BE REPLACED.
 - 2 (E) ANTENNAS AFTER MODIFICATIONS (N); SEE SHEET A-1.
 - 3 (E) WOODED AREA.
 - 4 (E) UNDERGROUND CABLE ROUTE.
 - 5 (E) 18" WIDE GRAVEL ACCESS ROAD.
 - 6 (E) SINGLE FAMILY RESIDENTIAL NEIGHBORHOOD.
 - 7 (E) MULTI FAMILY RESIDENTIAL NEIGHBORHOOD.

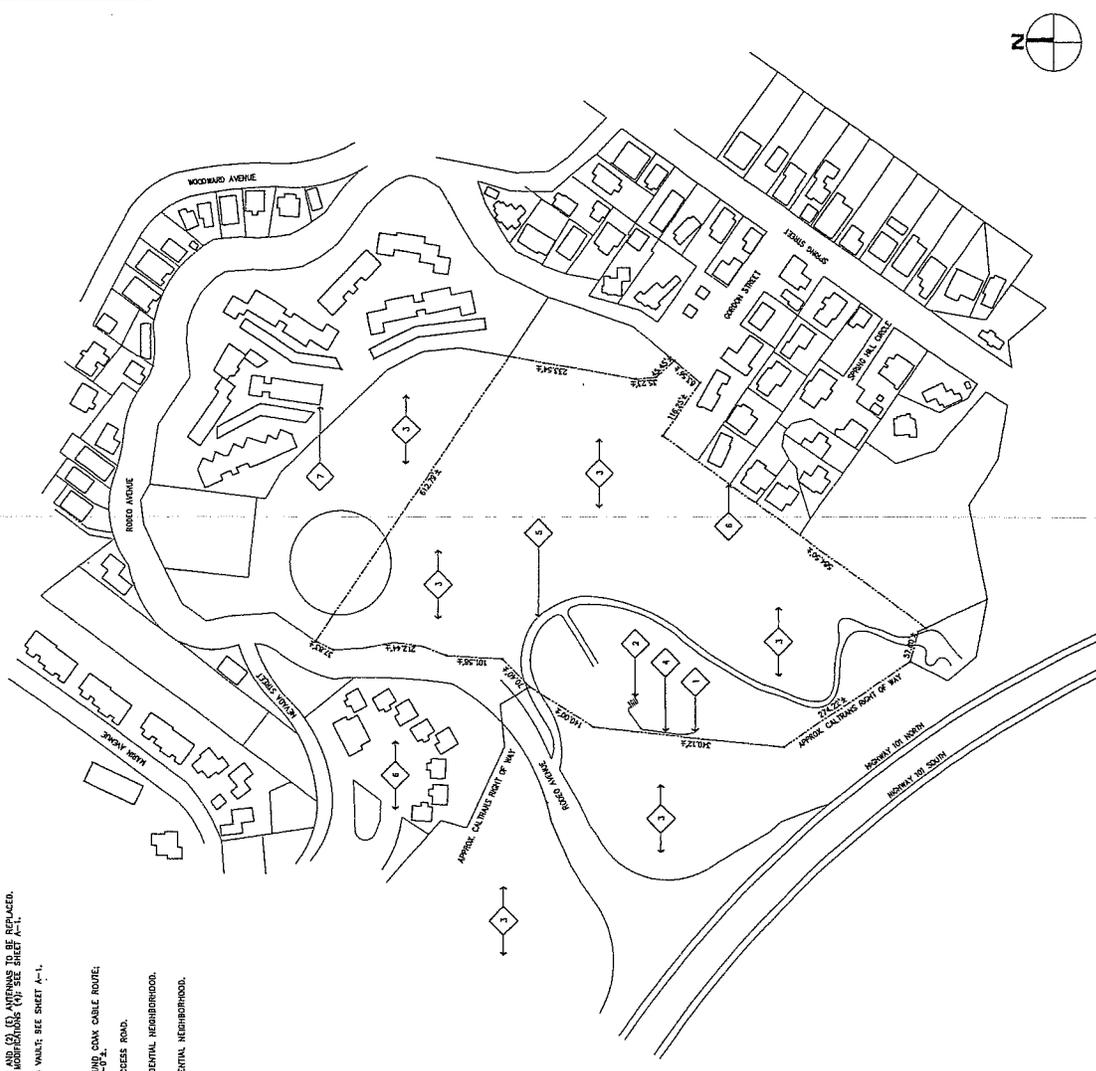

SCALE:
 1" = 100'

DATE:
 MAR 19 2008

CITY OF SAUSALITO
 COMMUNITY DEVELOPMENT

2 SITE PLAN

NOT USED

482

JRA
 Jeffrey Romo & Associates, Inc.
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 (480) 793-3388
 (702) 749-0889

PROPRIETARY INFORMATION
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at&t
 APPLICANT
 1430 ROSEWOOD DRIVE
 PLEASANTON, CALIFORNIA, 94888
 DRIVER
 101 RODO AVENUE
 420 LINDO STREET
 SAUSALITO, CALIFORNIA, 94865
 APPROVALS

R.F. _____ DATE _____
 ZONING _____ DATE _____
 CONSTRUCTION _____ DATE _____
 SITE ACQUISITION _____ DATE _____
 OTHER APPROVAL _____ DATE _____

AT&T 2ND CARRIER MODS
101 & RODO
 PROJECT ADDRESS
 101 RODO AVENUE
 SAUSALITO, CALIFORNIA 94865

APR NUMBER
 64-181-040
 DRAWING DATES
 12/19/08 ROK 20 REVIEW (P)
 01/14/09 ROK 20 REVIEW (P)
 03/03/09 PLANNING COMMENTS (P-4)

RFS
 REVISION 4.2
 SHEET TITLE

ENLARGED SITE PLAN

A-1

1. CONTRACTOR TO PROVIDE ALL WARE TO METAL COAX, RETN AND ANTENNAS AS SPECIFIED ON SHEETS 101-1 THROUGH 101-11.
2. EROSION TO PROVIDE ALL COAX, CONNECTORS, ANGLULAR EQUIPMENT (INCLUDING WEATHER STRIPPING, GROUND NITS, ETC.).
3. CONTRACTOR TO COLOR CODE ALL COAX, COLORED BANDS OF TAPE ON COAX ALL COAX UNLESS OTHERWISE NOTED.

SECTOR "A"

TR 1	TR 2	TR 3	TR 4	TR 5	TR 6
1 WHITE	2 ORANGE	3 WHITE	4 GREEN	5 BLUE	6 RED
1 WHITE	2 ORANGE	3 WHITE	4 GREEN	5 BLUE	6 RED
1 WHITE	2 ORANGE	3 WHITE	4 GREEN	5 BLUE	6 RED
1 WHITE	2 ORANGE	3 WHITE	4 GREEN	5 BLUE	6 RED
1 WHITE	2 ORANGE	3 WHITE	4 GREEN	5 BLUE	6 RED
1 WHITE	2 ORANGE	3 WHITE	4 GREEN	5 BLUE	6 RED


SECTOR "B"

TR 1	TR 2	TR 3	TR 4	TR 5	TR 6
1 YELLOW	2 BLUE	3 RED	4 GREEN	5 ORANGE	6 WHITE
1 YELLOW	2 BLUE	3 RED	4 GREEN	5 ORANGE	6 WHITE
1 YELLOW	2 BLUE	3 RED	4 GREEN	5 ORANGE	6 WHITE
1 YELLOW	2 BLUE	3 RED	4 GREEN	5 ORANGE	6 WHITE
1 YELLOW	2 BLUE	3 RED	4 GREEN	5 ORANGE	6 WHITE
1 YELLOW	2 BLUE	3 RED	4 GREEN	5 ORANGE	6 WHITE

SECTOR "C"

TR 1	TR 2	TR 3	TR 4	TR 5	TR 6
1 YELLOW	2 BLUE	3 RED	4 GREEN	5 ORANGE	6 WHITE
1 YELLOW	2 BLUE	3 RED	4 GREEN	5 ORANGE	6 WHITE
1 YELLOW	2 BLUE	3 RED	4 GREEN	5 ORANGE	6 WHITE
1 YELLOW	2 BLUE	3 RED	4 GREEN	5 ORANGE	6 WHITE
1 YELLOW	2 BLUE	3 RED	4 GREEN	5 ORANGE	6 WHITE
1 YELLOW	2 BLUE	3 RED	4 GREEN	5 ORANGE	6 WHITE

4. WHEN ANTENNA LINES ARE BLENDED, THE COLOR CODE OF THE HIGHEST FREQUENCY SERVICE (I.E. UMS) SHOULD HAVE COLOR 4 BANDS).
5. ALL ANTENNA LINES SHALL BE INSTALLED BY ANTENNA INSTALLATION CONTRACTOR.
6. PRIOR TO PLACEMENT OF ANTENNA POLE, THE CONTRACTOR SHALL VERIFY THAT THE ANTENNA AND UNDERGROUND SERVICE SHALL BE INSTALLED IN ACCORDANCE WITH THE APPLICABLE REGULATIONS AND THE APPLICABLE REGULATIONS.
7. ANTENNA INSTALLATION CONTRACTOR SHALL PROVIDE ALL CONDUIT, CABLE TRAY, GROUNDING, ETC. FOR COMPLETE INSTALLATION OF ANTENNAS AND CABLES SHOWN AND EROSION INC. SHALL PROVIDE A COMPLETE OPENING SYSTEM IN ACCORDANCE WITH EROSION INC. STANDARD.
8. NO COAX SHALL THERE BE ANY MORE THAN TWO (2) 90° TURNS (OR EQUIVALENT) IN ANY CONTINUOUS LENGTH OF CONDUIT BETWEEN PULL BOXES OR SIMILAR FEATURES.
9. ANTENNA CONDUIT SHALL ONLY INCLUDE FACTORY-MADE LARGE RADIUS SWEEPS AT 90° AND 45° MINIMUM BELOW GROUND. RADIUS SHALL BE 15" MINIMUM ABOVE GROUND AND 30" MINIMUM BELOW GROUND.
10. CONDUIT SHALL BE 3/4" MINIMUM. ALL UNDERGROUND CONDUIT SHALL BE SCHEDULE 40 WALL THICKNESS. CONDUIT SHALL BE INSTALLED IN ACCORDANCE WITH THE APPLICABLE REGULATIONS AND THE APPLICABLE REGULATIONS ON A HIGH SHALL BE EMT OR UV STABILIZED PAINTED SCHEDULE 40 PVC.
11. IN HIGH TRAFFIC AREAS OR WHERE SUSCEPTIBLE TO DAMAGE CONTRACTOR SHALL PROVIDE ALL CONDUIT SHALL BE INSTALLED IN ACCORDANCE WITH THE APPLICABLE REGULATIONS AND THE APPLICABLE REGULATIONS. CONTRACTOR SHALL PROVIDE ALL CONDUIT SHALL BE INSTALLED IN ACCORDANCE WITH THE APPLICABLE REGULATIONS AND THE APPLICABLE REGULATIONS. CONTRACTOR SHALL PROVIDE ALL CONDUIT SHALL BE INSTALLED IN ACCORDANCE WITH THE APPLICABLE REGULATIONS AND THE APPLICABLE REGULATIONS.
12. HENRY ROUTE AND LENGTH OF CABLE FROM TO CUTTING. ADJUST INDICATED ROUTE AS REQUIRED TO CLEAR (E) EQUIPMENT AT FACILITIES.
13. MAXIMUM LENGTH OF 7/8" COAX CABLE SHALL BE 140'-0". MAXIMUM LENGTH OF 1-1/4" COAX CABLE SHALL BE 190'-0". MAXIMUM LENGTH OF 1-5/8" COAX CABLE SHALL BE 235'-0".
14. VERIFY MODEL NUMBERS OF ANTENNA WITH EROSION INC. SERVICES.
15. THE CONTRACTOR SHALL PROVIDE TESTING OF ANTENNAS AND SHALL PROVIDE REPORT TO THE EROSION INC. PROJECT MANAGER.
16. SPECIFICATIONS AND RECOMMENDATIONS.

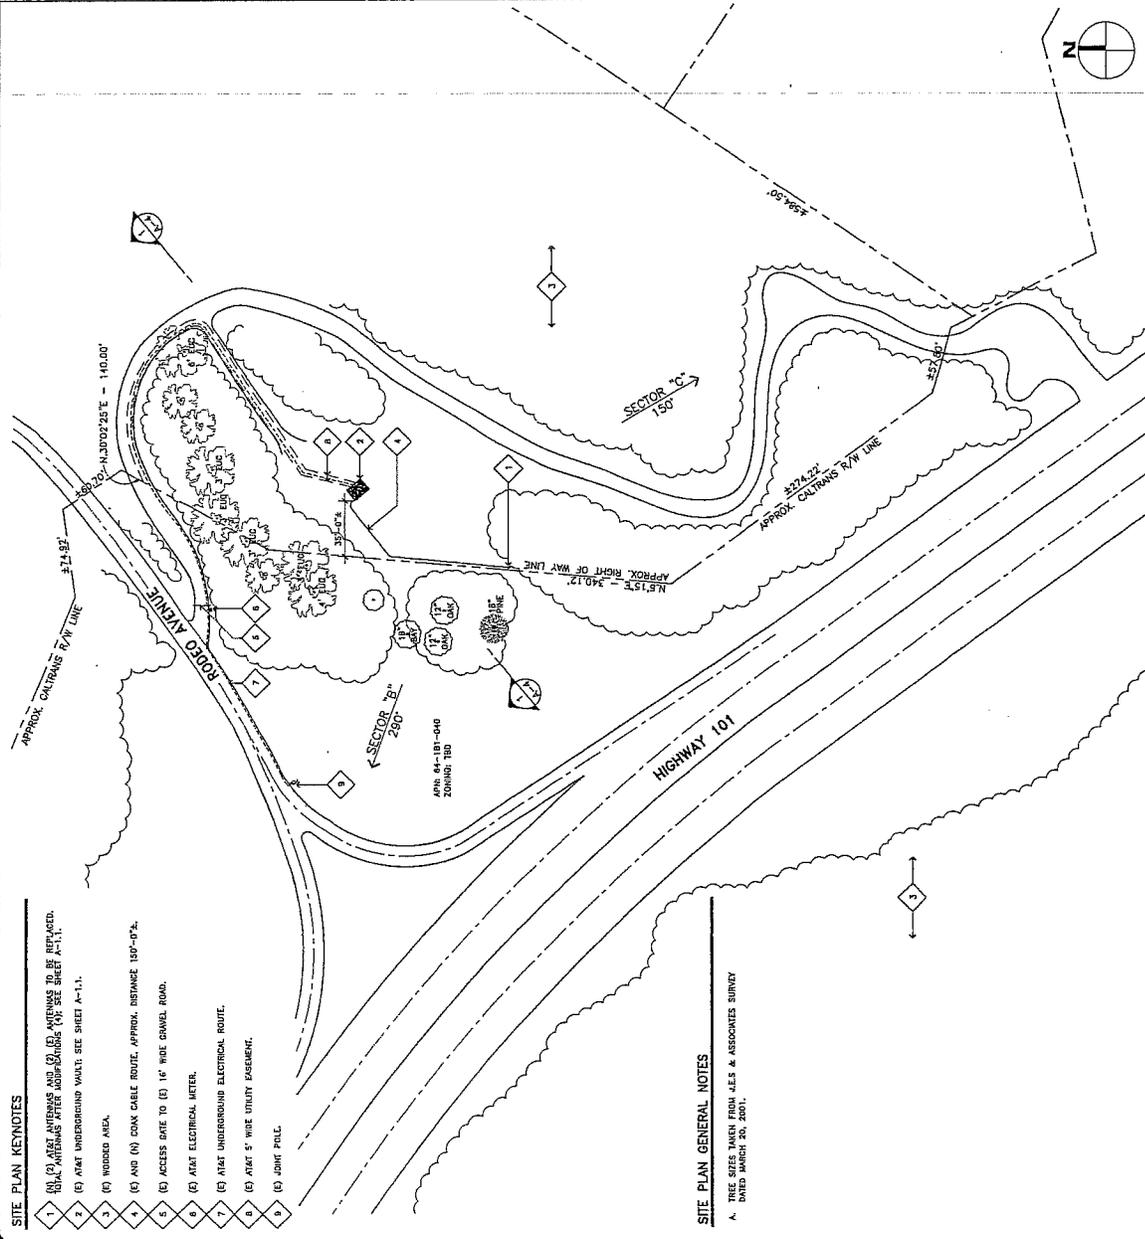

- SITE PLAN KEYNOTES**
1. (P) ANTENNA SERVICE SHALL BE PROVIDED BY THE CONTRACTOR.
 2. (E) ANTENNA SERVICE SHALL BE PROVIDED BY THE CONTRACTOR.
 3. (E) ANTENNA SERVICE SHALL BE PROVIDED BY THE CONTRACTOR.
 4. (E) ANTENNA SERVICE SHALL BE PROVIDED BY THE CONTRACTOR.
 5. (E) ANTENNA SERVICE SHALL BE PROVIDED BY THE CONTRACTOR.
 6. (E) ANTENNA SERVICE SHALL BE PROVIDED BY THE CONTRACTOR.
 7. (E) ANTENNA SERVICE SHALL BE PROVIDED BY THE CONTRACTOR.
 8. (E) ANTENNA SERVICE SHALL BE PROVIDED BY THE CONTRACTOR.
 9. (E) ANTENNA SERVICE SHALL BE PROVIDED BY THE CONTRACTOR.
 10. (E) ANTENNA SERVICE SHALL BE PROVIDED BY THE CONTRACTOR.

- SITE PLAN GENERAL NOTES**
1. THESE AREA SURVEY FROM JES & ASSOCIATES SURVEY DATED MARCH 20, 2001.

GENERAL ANTENNA & CABLE NOTES

SCALE: 1"=50'

0 25' 50'

2

ENLARGED SITE PLAN

MAR 19
 CITY OF SAUSALITO
 COMMUNITY DEVELOPMENT

482
 PAGE 4 OF 20

JRA

Jeffrey Rowe & Associates, Inc.
 Address • California • Inverdo
 ARIZONA (480) 284-8579
 CALIFORNIA (414) 790-3229
 NEVADA (702) 795-0555

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APPLICANT
at&t
 4430 ROSEWOOD DRIVE
 PLEASANTON, CALIFORNIA, 94566
 OWNER
 CTS CORPORATION
 100 LINDO STREET
 SAUSALITO, CALIFORNIA, 94965
 APPROVALS

REG.	DATE
ZONING	DATE
CONSTRUCTION	DATE
SITE ACQUISITION	DATE
OFFICE APPROVAL	DATE


PROJECT NAME
AT&T 2ND CARRIER MODS
 SITE NO. **101**
 SITE NAME **RODEO**
 CITY **CONCORD**
 COUNTY **CONCORD**
 PROJECT ADDRESS
 101 RODEO AVENUE
 SAUSALITO, CALIFORNIA 94965

APN NUMBER
 01-115-040
 DRAWING DATES
 07/10/08
 08/20/08
 09/16/08
 03/05/09

PERMITS
 REGION 4.2
 SHEET TITLE

**NORTHWEST AND SOUTHEAST
 EXISTING ELEVATIONS**

A-2

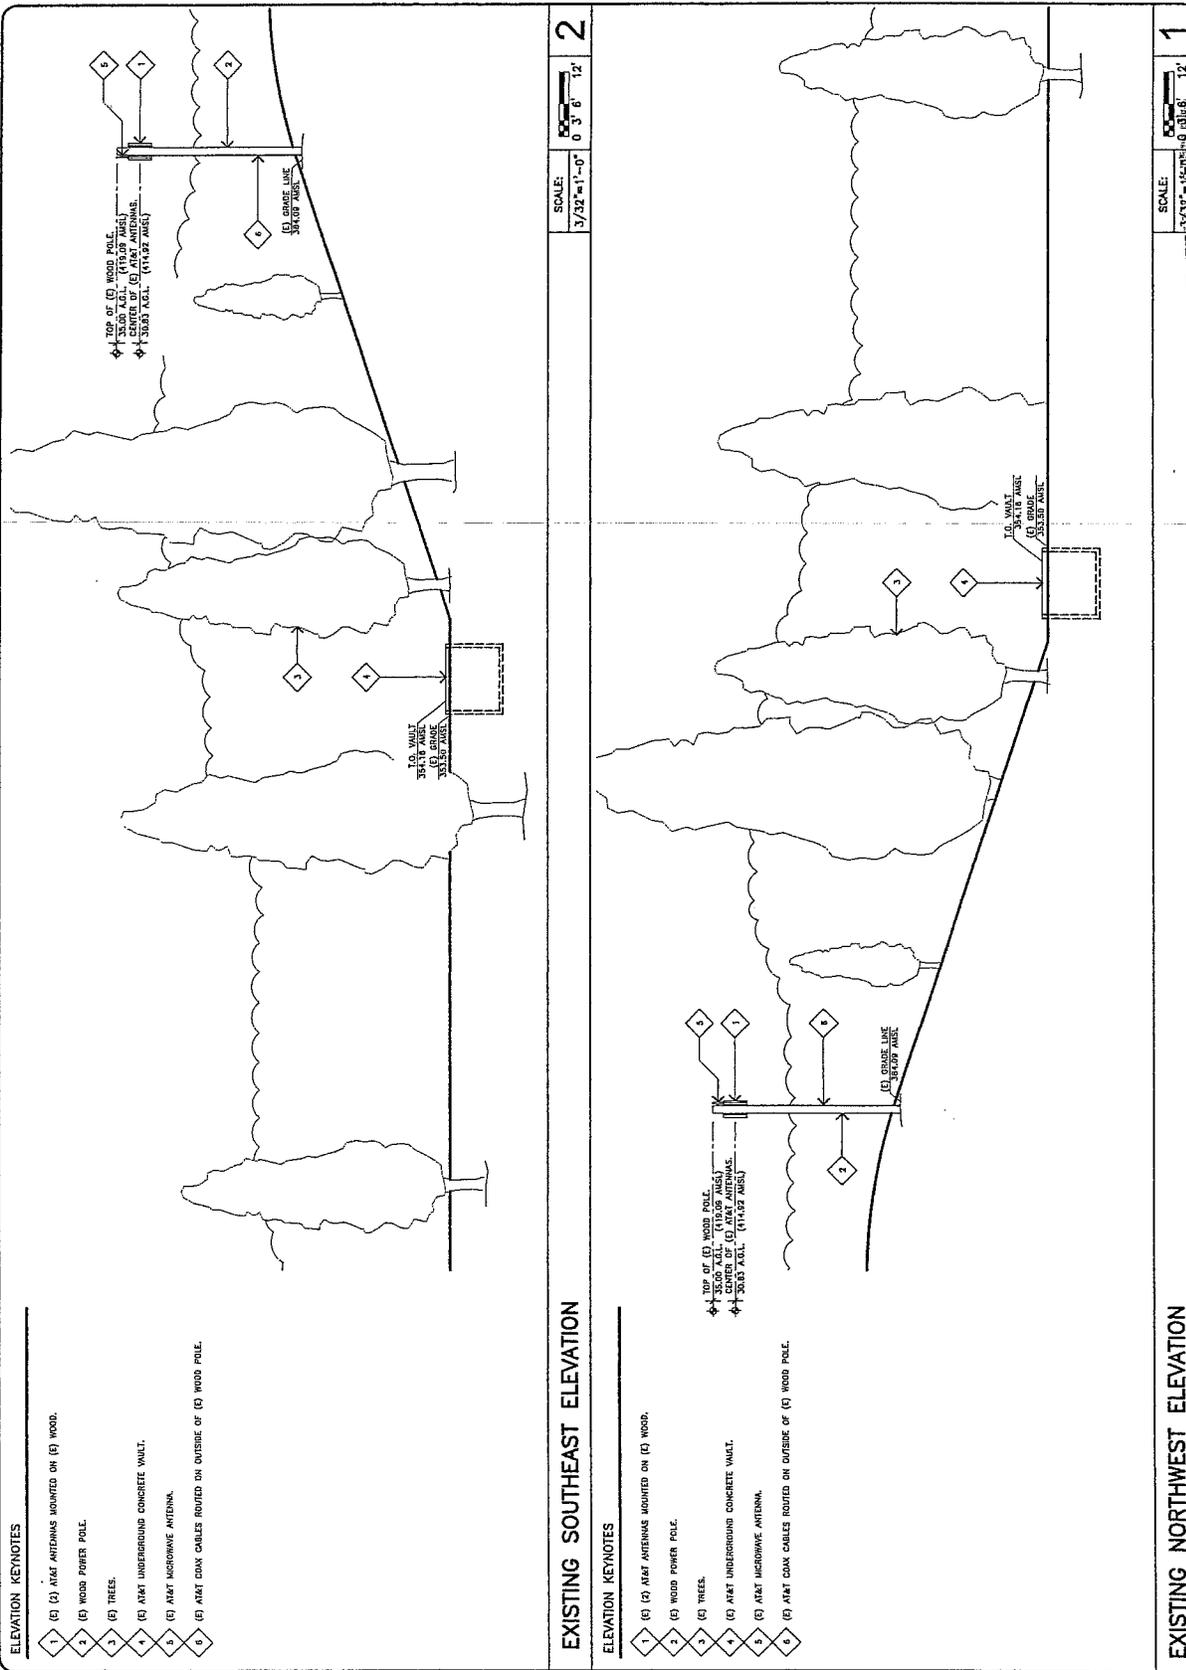

ELEVATION KEYNOTES

- 1 (E) AT&T ANTENNAS MOUNTED ON (E) WOOD.
- 2 (E) WOOD POWER POLE.
- 3 (E) TREES.
- 4 (E) AT&T UNDERGROUND CONCRETE VENT.
- 5 (E) AT&T MICRODOME ANTENNA.
- 6 (E) AT&T COAX CABLES ROUTED ON OUTSIDE OF (E) WOOD POLE.

EXISTING SOUTHEAST ELEVATION

ELEVATION KEYNOTES


- 1 (E) AT&T ANTENNAS MOUNTED ON (E) WOOD.
- 2 (E) WOOD POWER POLE.
- 3 (E) TREES.
- 4 (E) AT&T UNDERGROUND CONCRETE VENT.
- 5 (E) AT&T MICRODOME ANTENNA.
- 6 (E) AT&T COAX CABLES ROUTED ON OUTSIDE OF (E) WOOD POLE.

EXISTING NORTHWEST ELEVATION

RECEIVED


MAR 19 2009
 CITY OF SAUSALITO
 COMMUNITY DEVELOPMENT

- ELEVATION KEYNOTES
- 1 (E) AT&T UNDERGROUND VAULT.
 - 2 (E) TREES.
 - 3 (E) SHRUBS.
 - 4 (E) ACCESS DRIVE.

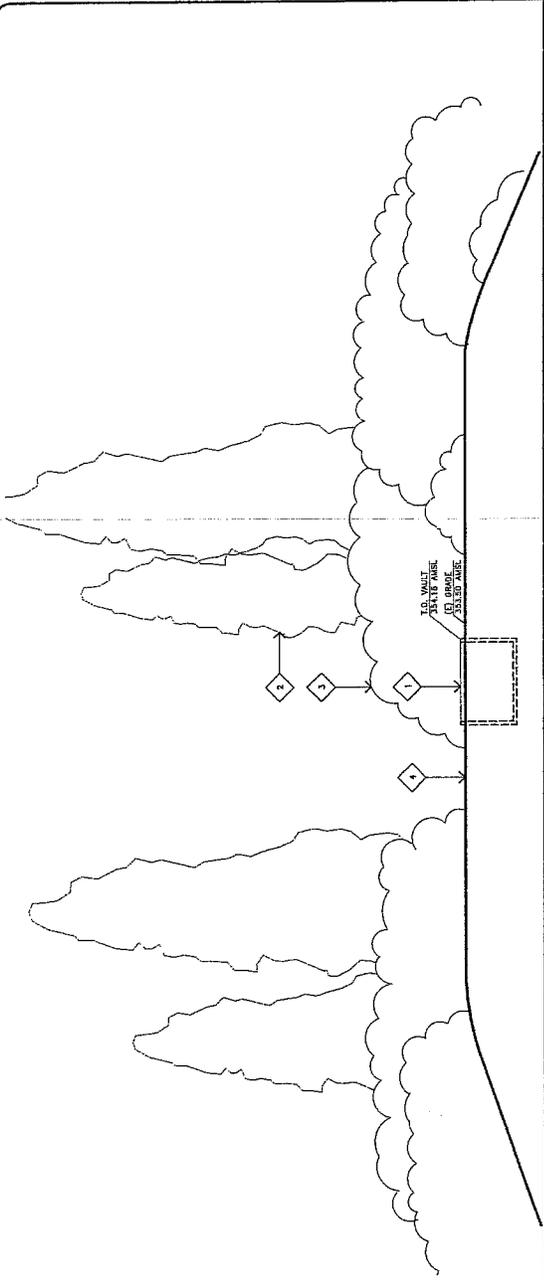

EXISTING SOUTHWEST ELEVATION

- ELEVATION KEYNOTES
- 1 (E) (C) AT&T ANTENNAS MOUNTED ON (E) WOOD.
 - 2 (E) WOOD POWER POLE.
 - 3 (E) TREES.
 - 4 (E) AT&T UNDERGROUND VAULT.
 - 5 (E) AT&T MICROWAVE ANTENNA.
 - 6 (E) SHRUBS.

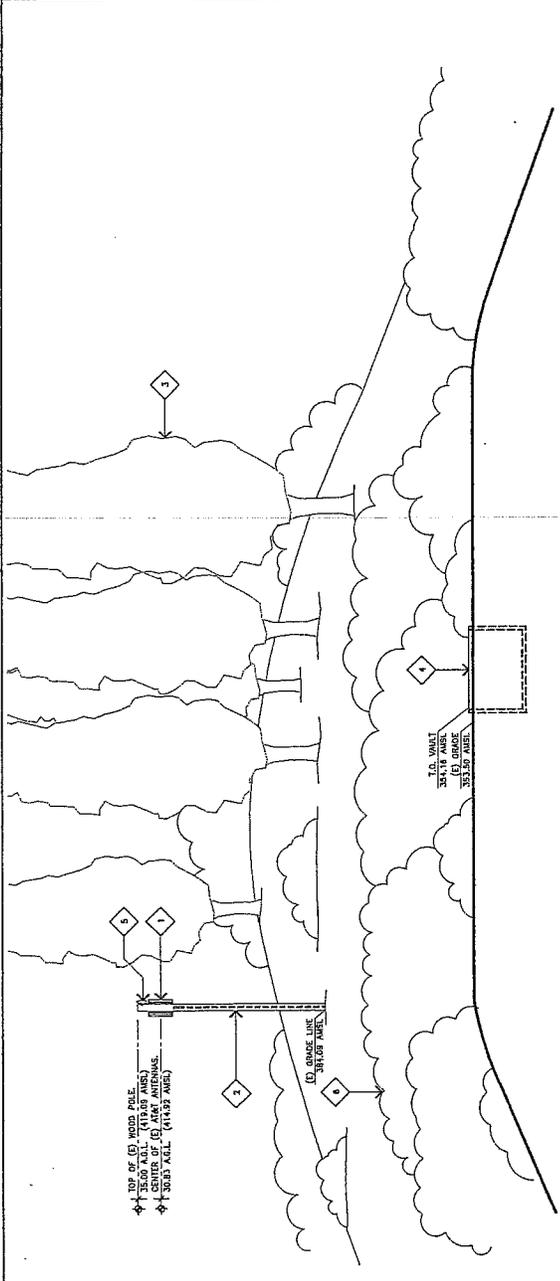

EXISTING NORTHEAST ELEVATION

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 (702) 744-0581

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APPLICANT
at&t
 COMMUNICATIONS SERVICE
 PLSAULTON, CALIFORNIA 94588

CITY OF SAUSALITO
 430 LUTHO STREET
 SAUSALITO, CALIFORNIA 94965
 APPROVALS

R.F.	DATE
ZONING	DATE
CONSTRUCTION	DATE
SITE ACQUISITION	DATE
OWNER APPROVAL	DATE

PROJECT NAME
AT&T 2ND CARRIER MODS
 101 & RODEO
 SITE NUMBER
 CNU4525
 PROJECT ADDRESS
 101 & RODEO
 SAUSALITO, CALIFORNIA 94965

REV. NUMBER
 64-81-810
 DRAWING DATES
 12/12/08 (P1)
 01/27/09 (P2)
 1004 20'S (P3)
 03/17/09 FIELD CORRECTION (P3)
 03/03/09 PLANNING COMMENTS (P4)

RFS
 REVISION 4-B
 SHEET TITLE

**NORTHEAST AND SOUTHWEST
 EXISTING ELEVATIONS**

A-2.1


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FILED

MAR 19 2009

CITY OF SAUSALITO
 COMMUNITY DEVELOPMENT

432
 PAGE #22

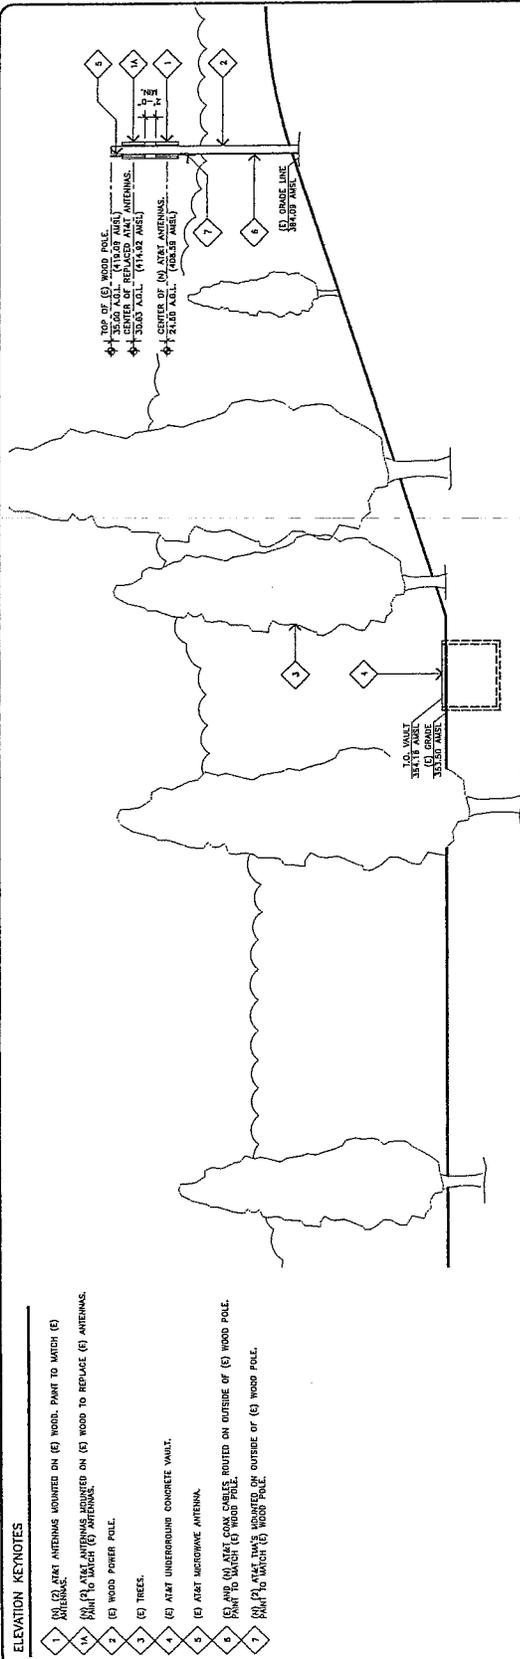


- ELEVATION KEYNOTES**
- 1 (1) AT&T ANTENNAS MOUNTED ON (E) WOOD POLE TO MATCH (E) ANTENNAS.
 - 2 (2) AT&T ANTENNAS MOUNTED ON (E) WOOD POLE TO MATCH (E) ANTENNAS.
 - 3 (3) WOOD POWER POLE.
 - 4 (4) TREE.
 - 5 (5) AT&T UNDERGROUND CONCRETE VAULT.
 - 6 (6) AT&T MICROWAVE ANTENNA.
 - 7 (7) WOOD POLE.

PROPOSED SOUTHEAST ELEVATION

SCALE: 3/32"=1'-0"

DATE: 12 12 03

DATE: 03 12 09

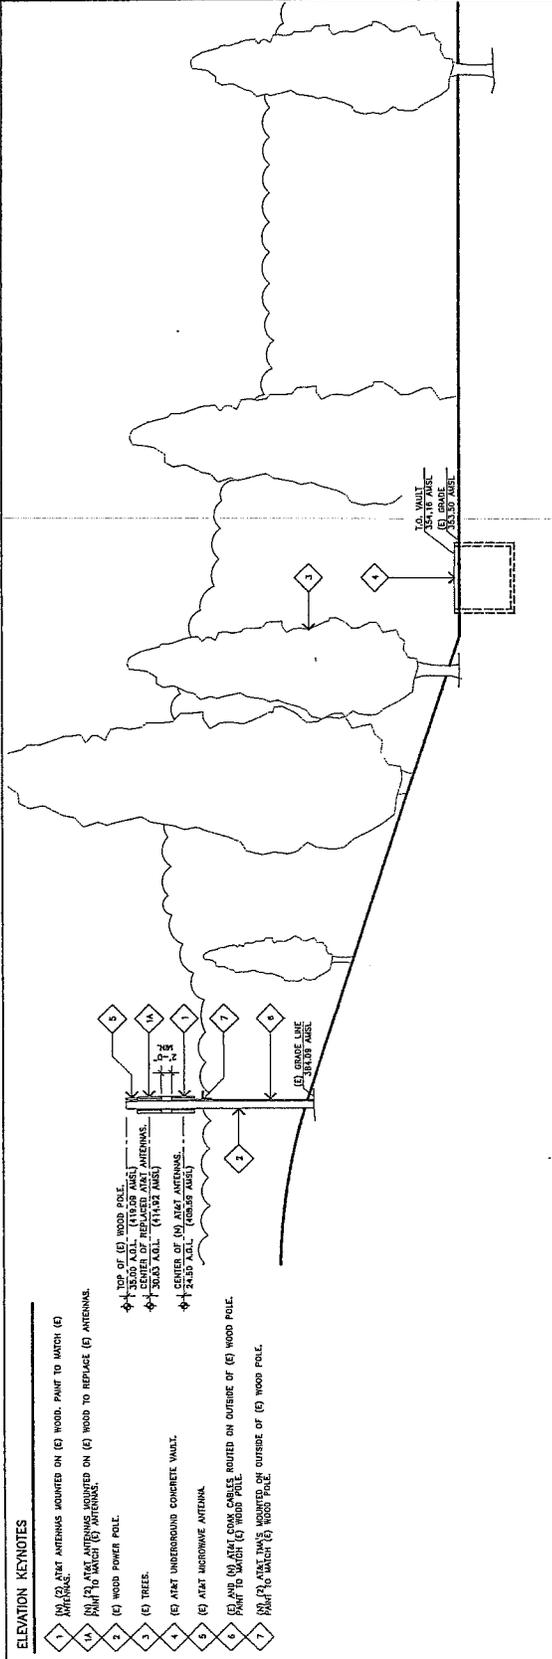

- ELEVATION KEYNOTES**
- 1 (1) AT&T ANTENNAS MOUNTED ON (E) WOOD POLE TO MATCH (E) ANTENNAS.
 - 2 (2) AT&T ANTENNAS MOUNTED ON (E) WOOD POLE TO MATCH (E) ANTENNAS.
 - 3 (3) WOOD POWER POLE.
 - 4 (4) TREE.
 - 5 (5) AT&T UNDERGROUND CONCRETE VAULT.
 - 6 (6) AT&T MICROWAVE ANTENNA.
 - 7 (7) WOOD POLE.

PROPOSED NORTHWEST ELEVATION

SCALE: 3/32"=1'-0"

DATE: 12 12 03

DATE: 03 12 09

JRA
Jaltry Romo & Associates, Inc.
Arizona • California • Nevada
ARIZONA: (520) 246-5274
CALIFORNIA: (951) 710-4411
NEVADA: (702) 748-9858

at&t
APPLICANT

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APPROVALS

DATE	

PROJECT NAME: AT&T 2ND CARRIER MODS
101 & RODEO

SITE NUMBER: CNU4523
PROJECT ADDRESS: 430 LITTO STREET, SAUSALITO, CALIFORNIA 94965

DATE: 12/12/03
BY: GSK TO BROWER (P1)
01/17/09
100A TO'S (P2)
01/27/09
FIELD APPROVAL (P3)
03/04/09
PENDING COMMENTS (P4)

PROJ. NUMBER: 64-101-010
DRAWING SETS:

REVISIONS: 12/12/03 GSK TO BROWER (P1)
01/17/09 100A TO'S (P2)
01/27/09 FIELD APPROVAL (P3)
03/04/09 PENDING COMMENTS (P4)

REVISION 4.2

SHEET TITLE: NORTHWEST AND SOUTHEAST PROPOSED ELEVATIONS

A-3

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MAR 19 2009

CITY OF SAUSALITO
COMMUNITY DEVELOPMENT



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APPLICANT
at&t
 1430 ROSEWOOD DRIVE
 FLOUENTON, CALIFORNIA 94588
 DRIVER
 CITY OF SALDALITO
 SALDALITO, CALIFORNIA 94845
 APPROVALS

RF.	DATE
ZONING	DATE
CONSTRUCTION	DATE
SITE ACQUISITION	DATE
OWNER APPROVAL	DATE

PROJECT NAME
AT&T 2ND CARRIER MODS
 SITE NAME
101 & RODEO
 SITE NUMBER
0114525

PROJECT ADDRESS
 181 RODEO AVENUE
 SALDALITO, CALIFORNIA 94845

APN NUMBER
 84-181-010


DRAWING DATES
 12/10/08 BOX 20 REVIEW (P1)
 01/14/09 FIELD CHECK (P2)
 02/18/09 FIELD CHECK (P3)
 03/03/09 PLANNING COMMENTS (P4)

RPS REVISION 4.2

SHEET TITLE

**NORTHEAST AND SOUTHWEST
 PROPOSED ELEVATIONS**

A-3.1

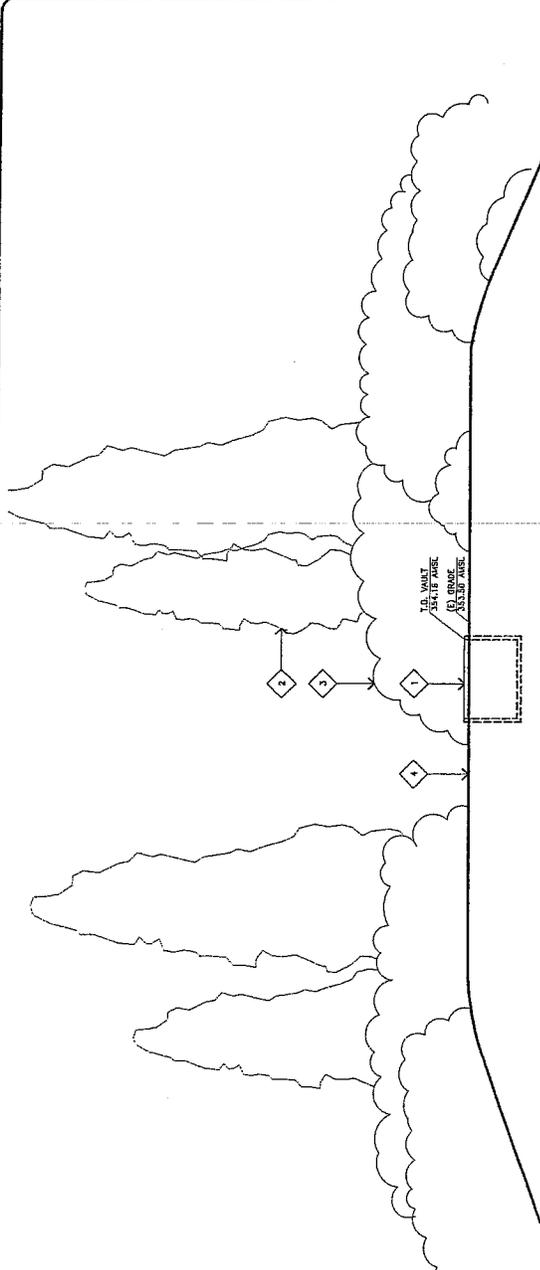


SCALE: 3/32"=1'-0"
 0 3' 6" 12'

PROPOSED SOUTHWEST ELEVATION

ELEVATION KEYNOTES

- 1 ANTENNA MOUNTED ON (E) WOOD POLE. PAINT TO MATCH (E)
- 2 ANTENNA MOUNTED ON (E) WOOD POLE. PAINT TO MATCH (E)
- 3 ANTENNA MOUNTED ON (E) WOOD POLE. PAINT TO MATCH (E)
- 4 ANTENNA MOUNTED ON (E) WOOD POLE. PAINT TO MATCH (E)
- 5 WOOD POWER POLE
- 6 TREE
- 7 AT&T UNDERGROUND WALT
- 8 AT&T MICROWAVE ANTENNA
- 9 SHRUB
- 10 AND (H) AT&T COAX CABLES ROUTED ON OUTSIDE OF (E) WOOD POLE. PAINT TO MATCH (E) WOOD POLE
- 11 AT&T WALT MOUNTED ON OUTSIDE OF (E) WOOD POLE. PAINT TO MATCH (E) WOOD POLE

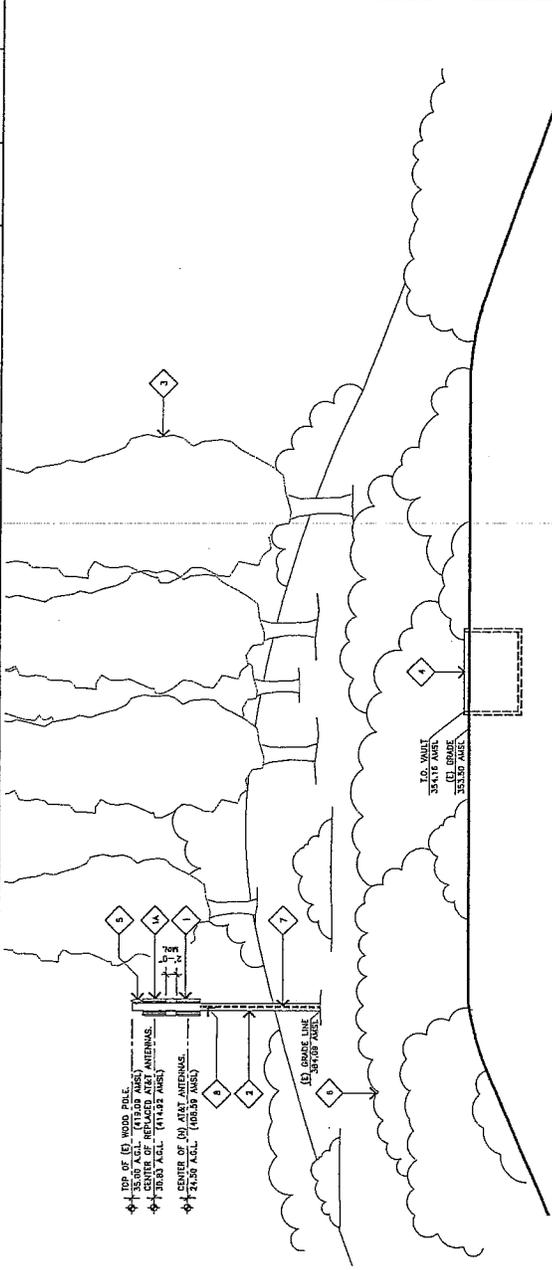

PROPOSED NORTHEAST ELEVATION

SCALE: 3/32"=1'-0"
 0 3' 6" 12'

MAR 19 2009
 CITY OF SALDALITO
 COMMUNITY DEVELOPMENT

482

PAGE #204

JRA

Jiffrey Roca & Associates, Inc.
 Arizona • California • Nevada
 1000 N. GARDEN AVENUE
 SUITE 200
 GARDEN GROVE, CALIFORNIA 92640
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 (702) 798-8551

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APPLICANT

4430 ROSENWOOD DRIVE
 PLACEMEN, CALIFORNIA 91388
 OWNER
 CITY OF SALVATO
 SALVATO, CALIFORNIA 94588
 APPROVALS

R.F.T.	DATE
ZONING	DATE
CONSTRUCTION	DATE
SITE ACQUISITION	DATE
OWNER APPROVAL	DATE

PROJECT NAME
AT&T 2ND CARRIER MODS
 SITE NAME
101 W. RODEO
 CITY
CA 94525

PROJECT ADDRESS
 101 RODEO AVENUE
 SALVATO, CALIFORNIA 94588

APN NUMBER
 64-10-1240

DRAWING DATES
 12/10/08 90% CD REVIEW (P1)
 01/17/09 100% CD REVIEW (P2)
 02/10/09 FIELD CONFIRMATION (P3)
 02/02/09 PLANNING COMMENT (P4)


REVISION
 REVISION 4.2
 SHEET TITLE

SITE SECTION

A-4

SITE SECTION KEYNOTES

- 1 (E) AT&T ANTENNAS MOUNTED ON (E) WOOD POLE TO MATCH (E) ANTENNAS.
- 2 (E) AT&T ANTENNAS MOUNTED ON (E) WOOD TO REPLACE (E) ANTENNAS. PAINT TO MATCH (E) ANTENNAS.
- 3 (E) WOOD POWER POLE.
- 4 (E) TREES.
- 5 (E) AT&T UNDERGROUND CONCRETE VAULT.
- 6 (E) AT&T MICROWAVE ANTENNA.

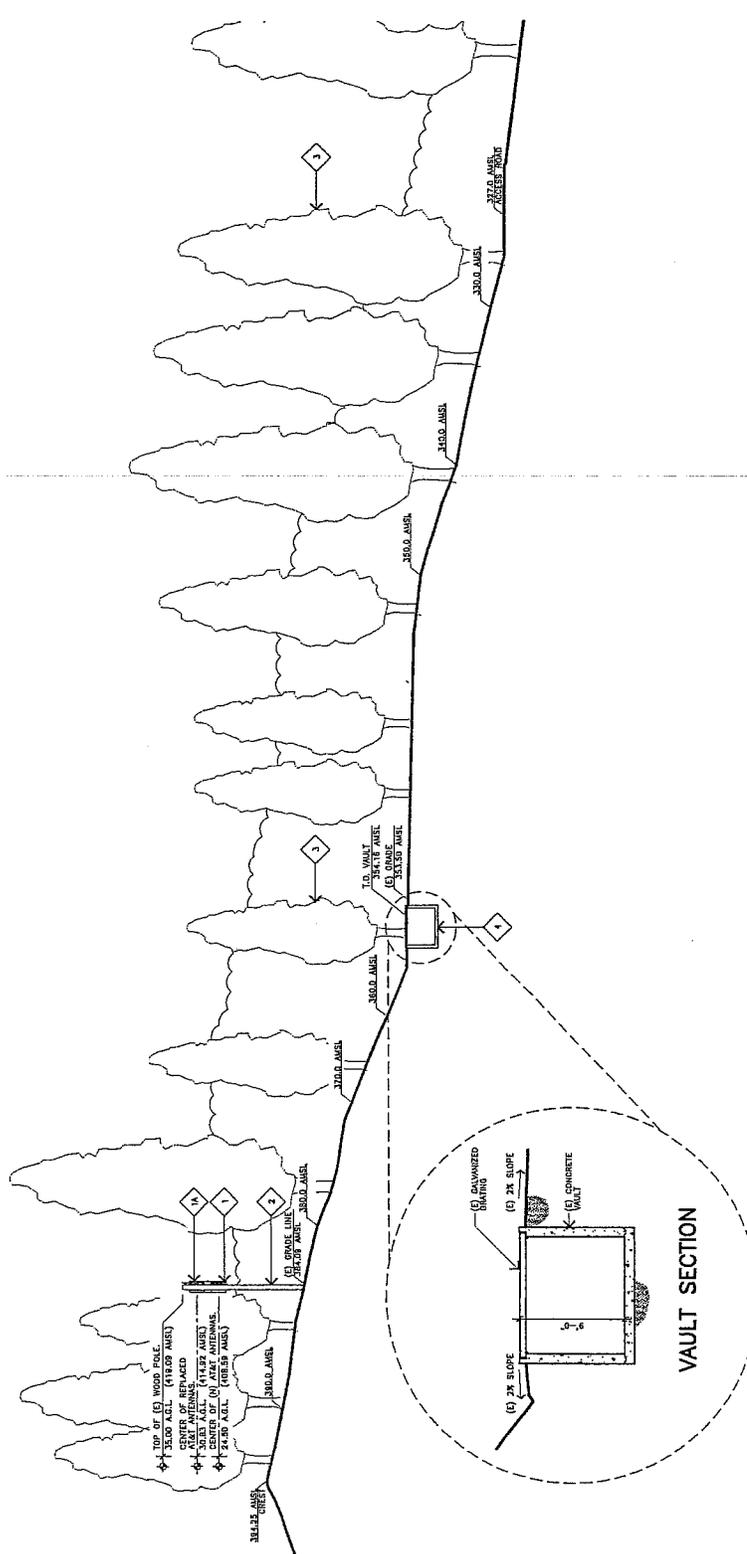

SITE SECTION

SCALE: 1" = 100'
 DATE: MAR 19 2009
 CITY OF SALVATO
 COMMUNITY DEVELOPMENT

MAR 19 2009

CITY OF SALVATO
 COMMUNITY DEVELOPMENT

482



PAGE # 25

ENLARGED SITE PLAN KEYNOTES

- 1 (N) (O) AT&T ANTENNAS MOUNTED BELOW (E) (E) AT&T ANTENNAS TO BE REPLACED WITH ANTENNAS TO MATCH (E) ANTENNAS WITH INDICATIONS (O).
- 2 (E) AT&T UNITS MICROCELL EQUIPMENT CABINET, TO BE REMOVED.
- 3 (N) AT&T 2518 UNITS MICROCELL EQUIPMENT CABINET MOUNTED ON A (O) PIPE MOUNT.
- 4 (N) (O) AT&T 1800Z DMM'S AND 184'S WITH SUN SHIELDS, STACKED, MOUNTED WITHIN (O) VAULT.
- 5 (E) AT&T TMM CABINET, TO BE REMOVED.
- 6 (E) AT&T 2208 RIS EQUIPMENT CABINET.
- 7 (E) ACCESS WARD.
- 8 (E) AT&T PULLBOX.
- 9 (E) AT&T AC PANEL.
- 10 (E) AT&T GENERATOR RECEPTACLE.
- 11 (E) AT&T ELECTRICAL DISCONNECT.
- 12 (E) AT&T ELECTRICAL TRANSFORMER.
- 13 (N) AT&T FIBER-OPT BATTERY CABINET MOUNTED WITHIN (E) VAULT.
- 14 (N) (O) AT&T TMM'S MOUNTED ON (E) WOOD POLE.
- 15 (N) AT&T DC POWER FEED; APPROX. LENGTH 8'-0". SHOW DIAGNOSTICALLY.
- 16 (N) AT&T JUMPER CABLES; APPROX. LENGTH 10'-0". SHOW DIAGNOSTICALLY.
- 17 (E) AT&T COAX CABLE ROUTE.
- 18 (N) AT&T COAX CABLE ROUTE. INSTALL (N) 4" UNDERGROUND CONDUIT.
- 19 (E) AT&T MICROWAVE ANTENNA.
- 20 (N) AT&T AC POWER FEED; APPROX. LENGTH ±10'-0". SHOW DIAGNOSTICALLY.
- 21 (N) AT&T AC POWER FEED; APPROX. LENGTH ±15'-0". SHOW DIAGNOSTICALLY.
- 22 (E) AT&T WINDSHIELD EXIT PORTS.
- 23 (E) GALVANIZED STEEL DRIVING ROOF ENCLOSURE.

ENLARGED SITE PLAN GENERAL NOTES

- A. GROUND ALL (N) EQUIPMENT AND COAX.
- B. (E) AT&T ANTENNAS TO BE REPLACED ABOVE. NOT SHOWN FOR CLARITY.

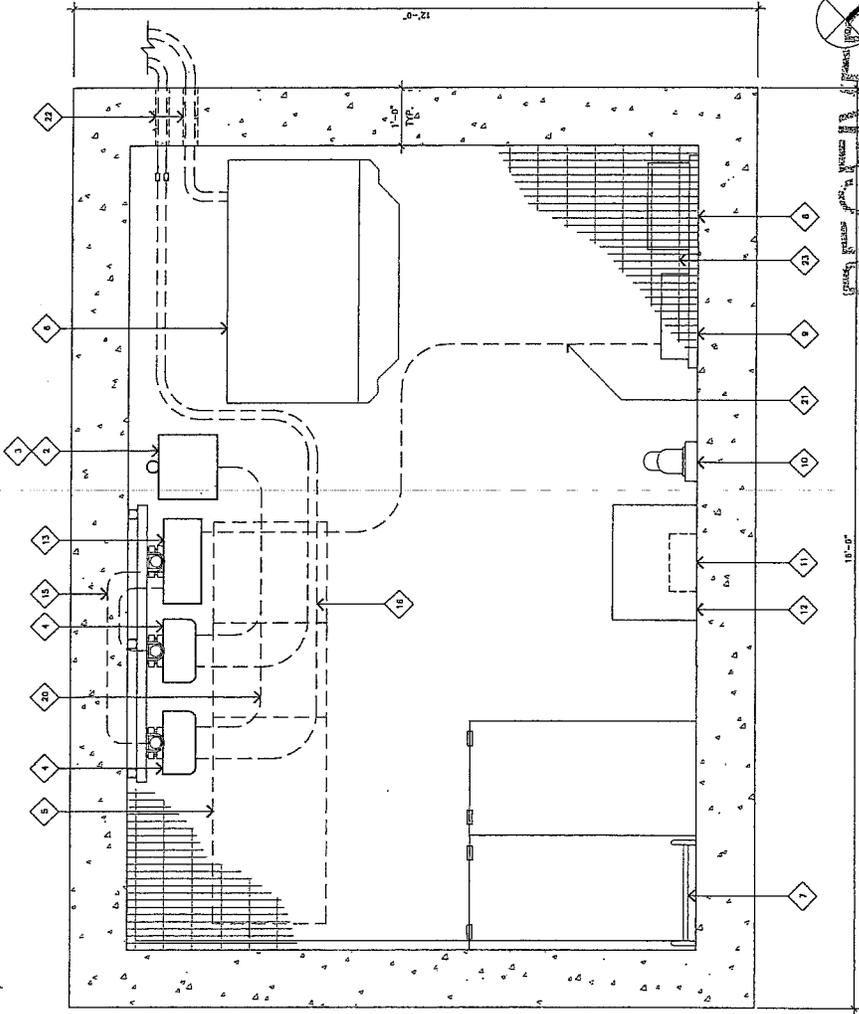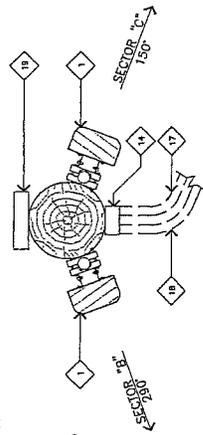

JRA
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Albuquerque • Dallas • Denver
Houston • Los Angeles • Miami
New York • San Jose • Seattle
Tel: (480) 344-3333
Fax: (480) 344-3333
www.jra.com

APPLICANT

4430 ROSEWOOD DRIVE
FOLSOM, CALIFORNIA, 95630

OWNER
AT&T WORLDWIDE
425 LIND STREET
SUNNYVALE, CALIFORNIA, 94089

APPROVALS

BY: _____ DATE _____

ZONING _____ DATE _____

CONSTRUCTION _____ DATE _____

SITE ADJUSTMENT _____ DATE _____

OWNER APPROVAL _____ DATE _____

PROJECT NAME
AT&T 2ND CARRIER MODS

SITE NAME
101 ST. MARINO

SITE NUMBER
CNU4525

PROJECT ADDRESS
101. ROSEA AVENUE
SAUSALITO, CALIFORNIA 94965

RFI NUMBER
15-11-1010

DRAWING DATES
12/15/09 SHEET NO. 0010 (P1)
01/27/10 SHEET NO. 0011 (P2)
02/19/10 FIELD CORRECTION (P3)
03/05/10 PLANNING COMMENTS (P4)

RFS REVISION 4.2
SHEET TITLE

A-1.1

EQUIPMENT FLOOR PLAN

CITY OF SAUSALITO
COMMUNITY DEVELOPMENT

SCALE: 1" = 10'-0"
MAR 11 2010

1

Handwritten notes: 482, P266-24

ATTACHMENT 2

RESOLUTION NO. _____

**A RESOLUTION OF THE CITY COUNCIL
OF THE CITY OF SAUSALITO, CALIFORNIA
APPROVING THE FIRST AMENDMENT TO THE LEASE AGREEMENT BY AND
BETWEEN THE CITY OF SAUSALITO AND AT&T @ HWY 101 AND RODEO
DRIVE**

WHEREAS, effective as of September 10, 2002 the City of Sausalito entered into a Lease Agreement with Bay Area Cellular Telephone Company dba AT&T Wireless Services for a portion of that certain real property owned by the City and located at Hwy 101 and Rodeo Drive (the "Lease"); and

WHEREAS, the City and the AT&T desire to enter into the First Amendment to the Lease which is attached hereto as Exhibit "A" and incorporated herein by reference; and

WHEREAS, pursuant to Resolution No. 2009-30 the Planning Commission approved a Conditional Use Permit and a Design Review Permit for Replacement of Two Existing Antennas and Installation of Two New Antennas on an Existing Monopole; Installation of Equipment in an Existing Underground Equipment Vault East of the Intersection of Rodeo Avenue and Highway 101 (CUP/DR 09-030); and

WHEREAS, the approval of the proposed Amendment is exempt from the application of the California Environmental Quality Act (California Public Resources Code Section 21000, et seq., "CEQA"), pursuant to Section 15301 (Class 1 Categorical Exemption) of the State CEQA Guidelines (Title 14, California Code of Regulations Section 15000, et seq.).

Now, therefore, the City Council of the City of Sausalito does hereby resolve as follows:

1. The City Council hereby finds that the proposed Amendment is exempt from the application of CEQA pursuant to Section 15301 (Class 1 Categorical Exemption) of the State CEQA Guidelines and the City Clerk, or her designee, is directed to cause Notices of Exemption to be posted in accordance with CEQA.
2. The First Amendment to the Lease Agreement by and between the City of Sausalito and AT&T which is attached hereto as Exhibit "A" is hereby approved and the City Manager is authorized to execute the First Amendment on behalf of the City.

Item #: 482
Meeting Date: _____
Page #: 27

3. Upon execution of the Amendment, the City Manager (or his designee), is authorized, on behalf of the City, to approve and/or sign all documents necessary and appropriate to carry out and implement the Amendment, and to administer the City's obligations, responsibilities and duties to be performed under the Amendment and related documents.

PASSED AND ADOPTED at a regular meeting of the City Council of the City of Sausalito on the ____ day of _____, 2010, by the following vote:

AYES:

NOES:

ABSENT:

ABSTAIN:

MAYOR OF THE CITY OF SAUSALITO

CITY CLERK

Item #: 482
Meeting Date:
Page #: 28

ATTACHMENT 3 - EXHIBIT A TO RESOLUTION

First Amendment to AT&T Lease

Item #: 4B2
Meeting Date: _____
Page #: 29

Market: San Francisco
Cell Site Number: CNU4525
Cell Site Name: Hwy. 101 & Rodeo
FA Number: 10101370
Address: Hwy. 101 & Rodeo Avenue

FIRST AMENDMENT TO LEASE AGREEMENT

THIS FIRST AMENDMENT TO LEASE AGREEMENT (“**Amendment**”), dated as of the latter of the signature dates below, is by and between The City of Sausalito, a municipal corporation, having a mailing address of 420 Litho Street, Sausalito, CA 94965 (hereinafter referred to as “**Landlord**”) and New Cingular Wireless PCS, LLC, a Delaware limited liability company, successor in interest to Bay Area Cellular Telephone Company, having a mailing address of 12555 Cingular Way, Suite 1300, Alpharetta, GA 30004 (hereinafter referred to as “**Tenant**”).

WHEREAS, Landlord and Tenant entered into a Lease Agreement dated September 10, 2002, whereby Landlord leased to Tenant certain Premises, therein described, that are a portion of the Property located with the CalTrans right-of-way at the northbound Rodeo Avenue off ramp and Highway 101, Sausalito, CA (“**Agreement**”); and

WHEREAS, Landlord and Tenant desire to adjust the rent in conjunction with the modifications to the Agreement contained herein; and

WHEREAS, Landlord and Tenant desire to amend the Agreement to modify the equipment; and

WHEREAS, Landlord and Tenant desire to amend the Agreement to modify the notice section thereof; and

WHEREAS, Landlord and Tenant desire to amend the Agreement to permit Tenant to add, modify and/or replace equipment in order to be in compliance with any current or future federal, state or local mandated application, including but not limited to emergency 911 communication services; and

WHEREAS, Landlord and Tenant, in their mutual interest, wish to amend the Agreement as set forth below accordingly.

NOW THEREFORE, in consideration of the foregoing and other good and valuable consideration, the receipt and sufficiency of which are hereby acknowledged, Landlord and Tenant agree as follows:

1. **Rent.** Commencing on the first day of the month following the date that Tenant commences construction (the “Rent Commencement Date”), Rent shall be increased by \$500 per month, subject to adjustments as provided in the Agreement. Upon Tenant’s removal of antennas, Rent

will revert to the original rate, subject to adjustments as provided in the Agreement, upon thirty (30) days' prior written notice to Landlord.

2. **Communication Facility.** Section 2 of the Agreement is revised to supplement Tenant's Equipment as more fully described on Revised Exhibit C-1, attached hereto and incorporated herein. The supplemented Equipment is in addition to the Equipment currently located at the Premises.

3. **Notices.** Section 17 of the Agreement is hereby deleted in its entirety and replaced with the following:

NOTICES. All notices, requests, demands and communications hereunder will be given by first class certified or registered mail, return receipt requested, or by a nationally recognized overnight courier, postage prepaid, to be effective when properly sent and received, refused or returned undelivered. Notices will be addressed to the parties as follows.

As to Tenant:

New Cingular Wireless PCS, LLC
Attn: Network Real Estate Administration
Re: Cell Site # CNU4525, Cell Site Name Hwy. 101 & Rodeo (CA)
FA No: 10101370
12555 Cingular Way, Suite 1300
Alpharetta, GA 30004

With a required copy of such notice sent to AT&T Legal at:
If sent via certified or registered mail:

New Cingular Wireless PCS, LLC
Attn: AT&T Legal Department
Re: Cell Site # CNU4525, Cell Site Name Hwy. 101 & Rodeo (CA)
FA No: 10101370
P.O. Box 97061
Redmond, WA 98073-9761

Or

If sent via nationally recognized overnight courier:

New Cingular Wireless PCS, LLC
Attn: AT&T Legal Department
Re: Cell Site # CNU4525, Cell Site Name Hwy. 101 & Rodeo (CA)
FA No: 10101370
16331 NE 72nd Way
Redmond, WA 98052-7827

As to Landlord:
City of Sausalito
420 Litho Street

482
11/08/07 2531

Sausalito, CA 94965
Attn: City Manager

Either party hereto may change the place for the giving of notice to it by thirty (30) days prior written notice to the other as provided herein.

4. **Emergency 911 Service.** In the future, without the payment of additional rent and at a location mutually acceptable to Landlord and Tenant, Landlord agrees that Tenant may add, modify and/or replace equipment in order to be in compliance with any current or future federal, state or local mandated application, including but not limited to emergency 911 communication services. Landlord reserves the right to review and approve of any emergency 911 equipment prior to installation.

5. **Other Terms and Conditions Remain.** In the event of any inconsistencies between the Agreement and this Amendment, the terms of this Amendment shall control. Except as expressly set forth in this Amendment, the Agreement otherwise is unmodified and remains in full force and effect. Each reference in the Agreement to itself shall be deemed also to refer to this Amendment.

6. **Capitalized Terms.** All capitalized terms used but not defined herein shall have the same meanings as defined in the Agreement.

4B2

PAGE # 30

IN WITNESS WHEREOF, the parties have caused their properly authorized representatives to execute and seal this Amendment on the dates set forth below.

“LANDLORD”

City of Sausalito

By: _____
Name: _____
Title: _____
Date: _____

“TENANT”

New Cingular Wireless PCS, LLC,
A Delaware limited liability company

By: AT&T Mobility Corporation
Its: Manager

By: _____
Name: _____
Title: _____
Date: _____

STATE OF CALIFORNIA)
)
COUNTY OF _____)

On _____ before me, _____, the undersigned, a Notary Public in and for said State, personally appeared _____

_____, who proved to me on the basis of satisfactory evidence to be the person(s) whose name(s) is/are subscribed to the within instrument and acknowledged to me that he/she/they executed the same in his/her/their authorized capacity(ies), and that by his/her/their signature(s) on the instrument the person(s), or the entity upon behalf of which the person(s) acted, executed the instrument.

I certify under PENALTY OF PERJURY under the laws of the State of California that the foregoing paragraph is true and correct.

WITNESS my hand and official seal.

Signature _____

Name _____
(typed or printed)

(Seal)

STATE OF CALIFORNIA)
)
COUNTY OF _____)

On _____ before me, _____, the undersigned, a Notary Public in and for said State, personally appeared _____

_____, who proved to me on the basis of satisfactory evidence to be the person(s) whose name(s) is/are subscribed to the within instrument and acknowledged to me that he/she/they executed the same in his/her/their authorized capacity(ies), and that by his/her/their signature(s) on the instrument the person(s), or the entity upon behalf of which the person(s) acted, executed the instrument.

I certify under PENALTY OF PERJURY under the laws of the State of California that the foregoing paragraph is true and correct.

WITNESS my hand and official seal.

Signature _____

Name _____
(typed or printed)

(Seal)

REVISED EXHIBIT C-1

See attached exhibit comprised of 10 pages, last revision date March 3, 2009, prepared by Jeffrey Rome & Associates, Inc.

Notes:

1. This Exhibit may be replaced by a land survey and/or construction drawings of the Premises once it is received by Licensee.
2. Any setback of the Premises from the Property's boundaries shall be the distance required by the applicable governmental authorities.
3. Width of access road shall be the width required by the applicable governmental authorities, including police and fire departments.
4. The type, number and mounting positions and locations of antennas and transmission lines are illustrative only. Actual types, numbers and mounting positions may vary from what is shown above.

GENERAL SPECIFICATIONS

- 1. THE LATEST EDITION OF THE AMERICAN INSTITUTE OF ARCHITECTS DOCUMENTS... 2. THE CONTRACTOR SHALL PROVIDE TEMPORARY WATER, POWER AND... 3. THE CONTRACTOR SHALL BE RESPONSIBLE FOR OBTAINING ALL NECESSARY PERMITS... 4. THE CONTRACTOR SHALL BE RESPONSIBLE FOR OBTAINING ALL NECESSARY PERMITS... 5. THE CONTRACTOR SHALL BE RESPONSIBLE FOR OBTAINING ALL NECESSARY PERMITS...

PAINTING NOTES & SPECIFICATIONS

- 1. ALL PAINT PRODUCT LINES SHALL BE SHOWN WILLIAMS UNLESS SPECIALLY NOTED OTHERWISE... 2. ALL PAINTS SHALL BE APPLIED TO CLEAN, DRY, AND UNIFORM SURFACES... 3. ALL PAINTS SHALL BE APPLIED TO CLEAN, DRY, AND UNIFORM SURFACES...

STRUCTURAL SPECIFICATIONS

- A. GENERAL... 1. ALL STRUCTURAL STEEL SHALL BE A36 UNLESS OTHERWISE SPECIFIED... 2. ALL STRUCTURAL STEEL SHALL BE A36 UNLESS OTHERWISE SPECIFIED... 3. ALL STRUCTURAL STEEL SHALL BE A36 UNLESS OTHERWISE SPECIFIED...

JRA Jeffrey Horn & Associates, Inc. 1011 14th Street, San Francisco, CA 94101. at&t 1430 Rockwood Drive, Pleasanton, California 94568. PROJECT: 101 & ROBELO CNU4525. SHEET: 101 & ROBELO. DATE: 02/17/99.

MAR 19 7 CITY OF SAUSALITO COMMUNITY DEVELOPMENT

482 2000 # 39

JRA
 Jeffrey Ross & Associates, Inc.
 Atlanta - California - Nevada
 1000 S. GARDEN ST.
 CALIFORNIA (916) 735-3379
 NEVADA (702) 735-0809

PROPRIETARY INFORMATION
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APPLICANT
 AT&T
 1430 ROSEWOOD DRIVE
 PLEASANTON, CALIFORNIA, 94588

OWNER
 CITY OF SAUSALITO
 SAUSALITO, CALIFORNIA, 94868

APPROVALS

PLANNING	DATE
ZONING	DATE
CONSTRUCTION	DATE
SITE ACQUISITION	DATE
OWNER APPROVAL	DATE

PROJECT NAME
 AT&T 2ND CARRIER MODS
 101 W. WOOD AVENUE
 SITE NUMBER
 CNU4525

PROJECT ADDRESS
 101 WOOD AVENUE
 SAUSALITO, CALIFORNIA 94868
 415-351-1111

DRAWING DATES

12/15/08	SIZE TO DRAW (PT)
01/27/09	100% 20% (PT)
03/02/09	PLANNING COMMENTS (PA)

REVISION

NO.	REVISION
42	

SHEET TITLE
 SITE PLAN

A-0



- SITE PLAN KEYNOTES**
- 1 (1) 10' WIND ANTENNAS AND 10' WIND ANTENNAS TO BE REPLACED.
 - 2 (2) 10' WIND ANTENNAS WITH 10' WIND ANTENNAS TO BE REPLACED (SEE SHEET A-1).
 - 3 (3) WIND UNDERGROUND TOWER SEE SHEET A-1.
 - 4 (4) WOODS AREA.
 - 5 (5) AND TO UNDERGROUND CABLE ROUTE APPROX. DISTANCE 100'-100'.
 - 6 (6) 10' WIND ANTENNAS TO BE REPLACED.
 - 7 (7) SINGLE FAMILY RESIDENTIAL NEIGHBORHOOD.
 - 8 (8) MULTY FAMILY RESIDENTIAL NEIGHBORHOOD.

SCALE:
 1" = 100'

DATE:
 MAR 19 11

CITY OF SAUSALITO
 COMMUNITY DEVELOPMENT

NOT USED | 2 | SITE PLAN

PAR #38
 482



Jeffrey Egan & Associates, Inc.
Attn: S. Collins - Project
18000
ALBANY, CA 94706
TEL: (925) 746-1570
FAX: (925) 746-1573
ALBANY, CA 94706
TEL: (925) 746-1570

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THE INFORMATION CONTAINED HEREIN IS THE PROPERTY OF JIRA AND IS NOT TO BE REPRODUCED OR TRANSMITTED IN ANY FORM OR BY ANY MEANS, ELECTRONIC OR MECHANICAL, INCLUDING PHOTOCOPYING, RECORDING, OR BY ANY INFORMATION STORAGE AND RETRIEVAL SYSTEM, WITHOUT THE WRITTEN PERMISSION OF JIRA.



APPROVALS
OWNER: AT&T
CITY OF SAN FRANCISCO
SAN FRANCISCO, CALIFORNIA
DATE: _____
CONSTRUCTION: _____
SITE ACQUISITION: _____
OWNER APPROVAL: _____

PROJECT NAME: AT&T 2ND FLOOR ANTENNAS
SITE NUMBER: 101 & RODEO
ADDRESS: 101 CALIFORNIA ST., SUITE 200, SAN FRANCISCO, CALIFORNIA 94108

DRAWING DATES
02/15/98
03/17/98
03/18/98
03/20/98
03/22/98

REVISION 4.2
SHEET TITLE
ENLARGED SITE PLAN

A-1

- 1. CONTRACTOR TO PROVIDE ALL WIRE TO INSTALL COAX, RETS AND ANTENNAS AS SPECIFIED ON SHEETS R-1 THROUGH R-3.
- 2. UNLESS OTHERWISE NOTED, ALL COAX CONNECTORS, ANGLARY EQUIPMENT (INCLUDING COAX TAPERS, COAX ADAPTERS, COAX CONNECTORS, COAX CONNECTORS AND TRANSFORMERS) SHALL BE OF THE FOLLOWING MANUFACTURER: HARRIS COMMUNICATIONS, INC.
- 3. CONTRACTOR TO COLOR CODE ALL COAX CABLES AS FOLLOWS ON SHEETS R-1 THROUGH R-3.
- 4. CONTRACTOR TO COLOR CODE ALL COAX CABLES AS FOLLOWS ON SHEETS R-1 THROUGH R-3.


THMA	TR 1	TR 2	TR 3	TR 4	TR 5	TR 6
1. WHITE	1. ORANGE	1. RED	1. GREEN	1. BLUE	1. PURPLE	1. BROWN
2. YELLOW	2. VIOLET	2. GREEN	2. RED	2. BLUE	2. PURPLE	2. BROWN
3. WHITE	3. ORANGE	3. RED	3. GREEN	3. BLUE	3. PURPLE	3. BROWN
4. YELLOW	4. VIOLET	4. GREEN	4. RED	4. BLUE	4. PURPLE	4. BROWN
5. WHITE	5. ORANGE	5. RED	5. GREEN	5. BLUE	5. PURPLE	5. BROWN

THMA	TR 1	TR 2	TR 3	TR 4	TR 5	TR 6
1. WHITE	1. ORANGE	1. RED	1. GREEN	1. BLUE	1. PURPLE	1. BROWN
2. YELLOW	2. VIOLET	2. GREEN	2. RED	2. BLUE	2. PURPLE	2. BROWN
3. WHITE	3. ORANGE	3. RED	3. GREEN	3. BLUE	3. PURPLE	3. BROWN
4. YELLOW	4. VIOLET	4. GREEN	4. RED	4. BLUE	4. PURPLE	4. BROWN
5. WHITE	5. ORANGE	5. RED	5. GREEN	5. BLUE	5. PURPLE	5. BROWN

4. VERIFY ANTENNA HEIGHT AND SPACING. THE COLOR CODE OF THE ANTENNA FREQUENCY CHANNELS (I.E. UHF, VHF, L-BAND, S-BAND, X-BAND, KA-BAND, Q-BAND, W-BAND) SHALL BE IDENTIFIED BY THE CONTRACTOR. THE CONTRACTOR SHALL VERIFY THE ANTENNA HEIGHT AND SPACING AGAINST THE PLANS WHICH ACTUAL FIELD CONDITIONS MAY VARY FROM THE PLANS. THE CONTRACTOR SHALL NOTIFY THE ARCHITECT IMMEDIATELY IN WRITING IF ANY DISCREPANCIES ARE FOUND.

5. BEFORE THE INSTALLATION OF ANTENNAS, THE CONTRACTOR SHALL VERIFY THE ANTENNA HEIGHT AND SPACING AGAINST THE PLANS WHICH ACTUAL FIELD CONDITIONS MAY VARY FROM THE PLANS. THE CONTRACTOR SHALL NOTIFY THE ARCHITECT IMMEDIATELY IN WRITING IF ANY DISCREPANCIES ARE FOUND.

6. CONTRACTOR TO PROVIDE ALL WIRE TO INSTALL COAX, RETS AND ANTENNAS AS SPECIFIED ON SHEETS R-1 THROUGH R-3.

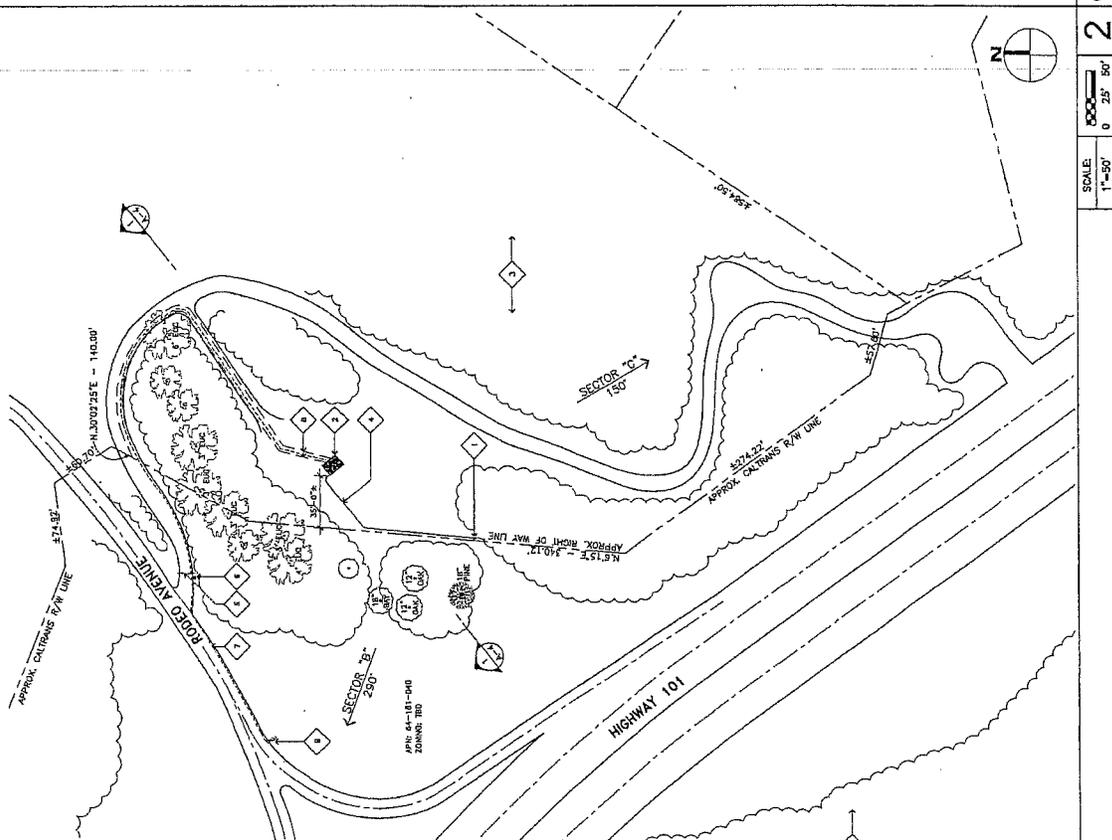

- 1. (A) AND (B) ANTENNAS AND (C) ANTENNAS TO BE REPLACED.
- 2. (D) ANTENNAS TO BE REPLACED.
- 3. (E) ANTENNAS TO BE REPLACED.
- 4. (F) ANTENNAS TO BE REPLACED.
- 5. (G) ANTENNAS TO BE REPLACED.
- 6. (H) ANTENNAS TO BE REPLACED.
- 7. (I) ANTENNAS TO BE REPLACED.
- 8. (J) ANTENNAS TO BE REPLACED.
- 9. (K) ANTENNAS TO BE REPLACED.
- 10. (L) ANTENNAS TO BE REPLACED.
- 11. (M) ANTENNAS TO BE REPLACED.
- 12. (N) ANTENNAS TO BE REPLACED.
- 13. (O) ANTENNAS TO BE REPLACED.
- 14. (P) ANTENNAS TO BE REPLACED.
- 15. (Q) ANTENNAS TO BE REPLACED.
- 16. (R) ANTENNAS TO BE REPLACED.
- 17. (S) ANTENNAS TO BE REPLACED.
- 18. (T) ANTENNAS TO BE REPLACED.
- 19. (U) ANTENNAS TO BE REPLACED.
- 20. (V) ANTENNAS TO BE REPLACED.
- 21. (W) ANTENNAS TO BE REPLACED.
- 22. (X) ANTENNAS TO BE REPLACED.
- 23. (Y) ANTENNAS TO BE REPLACED.
- 24. (Z) ANTENNAS TO BE REPLACED.
- 25. (AA) ANTENNAS TO BE REPLACED.
- 26. (AB) ANTENNAS TO BE REPLACED.
- 27. (AC) ANTENNAS TO BE REPLACED.
- 28. (AD) ANTENNAS TO BE REPLACED.
- 29. (AE) ANTENNAS TO BE REPLACED.
- 30. (AF) ANTENNAS TO BE REPLACED.
- 31. (AG) ANTENNAS TO BE REPLACED.
- 32. (AH) ANTENNAS TO BE REPLACED.
- 33. (AI) ANTENNAS TO BE REPLACED.
- 34. (AJ) ANTENNAS TO BE REPLACED.
- 35. (AK) ANTENNAS TO BE REPLACED.
- 36. (AL) ANTENNAS TO BE REPLACED.
- 37. (AM) ANTENNAS TO BE REPLACED.
- 38. (AN) ANTENNAS TO BE REPLACED.
- 39. (AO) ANTENNAS TO BE REPLACED.
- 40. (AP) ANTENNAS TO BE REPLACED.
- 41. (AQ) ANTENNAS TO BE REPLACED.
- 42. (AR) ANTENNAS TO BE REPLACED.
- 43. (AS) ANTENNAS TO BE REPLACED.
- 44. (AT) ANTENNAS TO BE REPLACED.
- 45. (AU) ANTENNAS TO BE REPLACED.
- 46. (AV) ANTENNAS TO BE REPLACED.
- 47. (AW) ANTENNAS TO BE REPLACED.
- 48. (AX) ANTENNAS TO BE REPLACED.
- 49. (AY) ANTENNAS TO BE REPLACED.
- 50. (AZ) ANTENNAS TO BE REPLACED.

SITE PLAN GENERAL NOTES
A. THE SITE WAS SURVEYED BY JIRA & ASSOCIATES SURVEY, INC. ON MARCH 20, 2001.

ENLARGED SITE PLAN

SCALE: 1"=50'

2 GENERAL ANTENNA & CABLE NOTES


MAR 19 '98

CITY OF SAUSALITO
COMMUNITY DEVELOPMENT

482

PA6R-39

JRA
 Jeffrey Ryan & Associates, Inc.
 Irvine • California • Nevada
 Arizona • (414) 264-5779
 Phoenix • (602) 795-8839

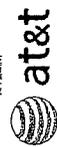AFFILIATE

 AIR INFORMATION GROUP
 10111 W. BUCKLEBOURNE AVENUE
 SUITE 100
 CHANDLER, ARIZONA 85226-4400

APPROVALS

DATE	DATE
ZONING	DATE
CONSTRUCTION	DATE
SITE ACQUISITION	DATE
POWER APPROVAL	DATE

PROJECT NAME
AT&T 2ND AND CARRIER WOODS
101 & RODEO

SITE NUMBER
 101-101-0000

PROJECT ADDRESS
 101 RODEO AVENUE
 SAUNDERS, CALIFORNIA 94945

APN NUMBER
 04-110-010

DRAWING DATES
 01/17/08
 02/25/08
 03/16/08
 04/02/08



FIELD CLASSIFICATION (P1)
 04/02/08

PLANNING CONSULTANT (P4)

REVISION 4.2

SHEET TITLE
 NORTHWEST AND SOUTHEAST
 EXISTING ELEVATIONS

A-2

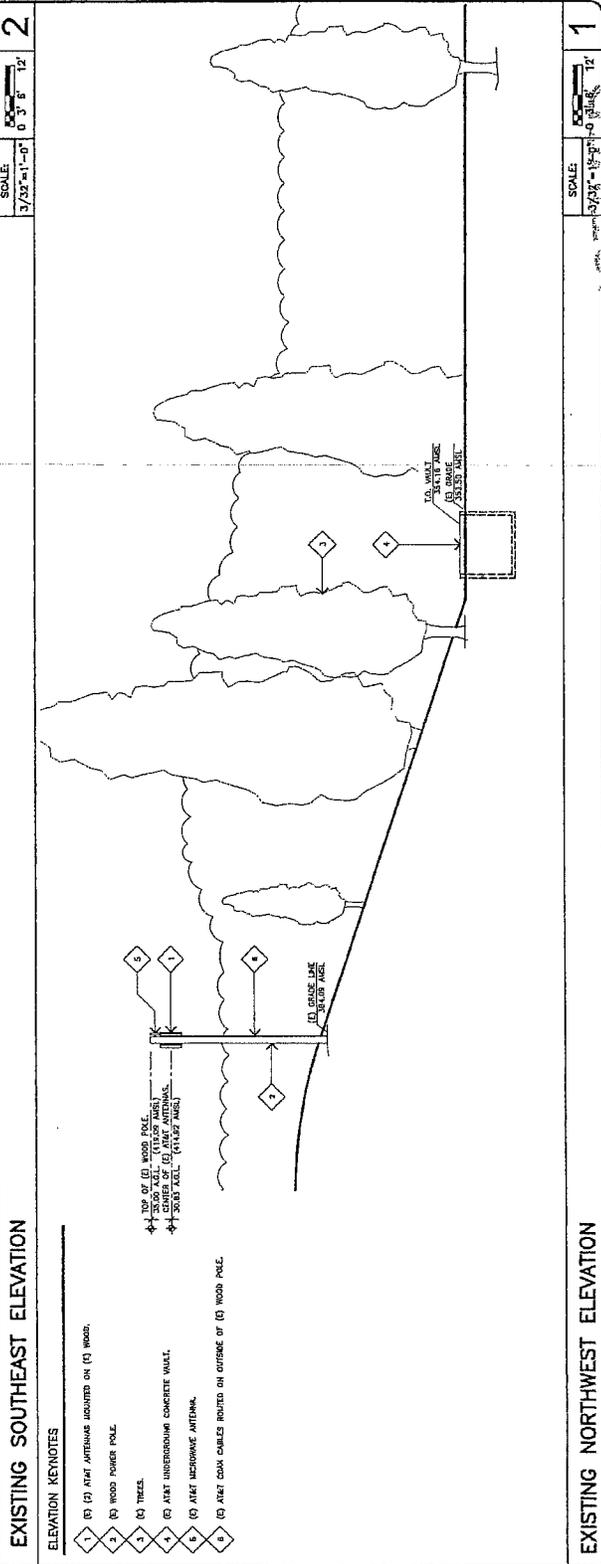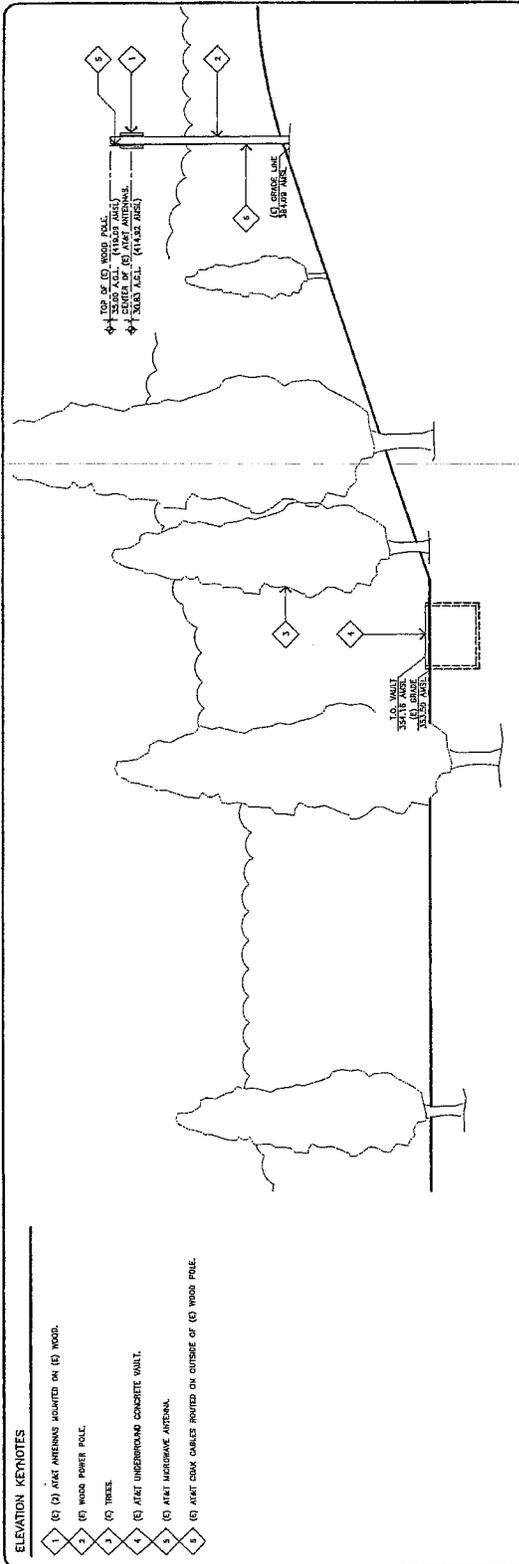

ELEVATION KEYNOTES

- 1 (1) AT&T ANTENNAS MOUNTED ON (1) WOOD.
- 2 (2) WIND POWER POLE.
- 3 (3) TREE.
- 4 (4) AT&T UNDERGROUND CONCRETE WALL.
- 5 (5) AT&T MICROWAVE ANTENNA.
- 6 (6) AT&T RACK CABLES ROUTED ON OUTSIDE OF (1) WOOD POLE.

ELEVATION KEYNOTES

- 1 (1) AT&T ANTENNAS MOUNTED ON (1) WOOD.
- 2 (2) WIND POWER POLE.
- 3 (3) TREE.
- 4 (4) AT&T UNDERGROUND CONCRETE WALL.
- 5 (5) AT&T MICROWAVE ANTENNA.
- 6 (6) AT&T RACK CABLES ROUTED ON OUTSIDE OF (1) WOOD POLE.

EXISTING SOUTHEAST ELEVATION

SCALE: 3/32"=1'-0"

0' 3' 6' 12'

2

EXISTING NORTHWEST ELEVATION

SCALE: 3/32"=1'-0"

0' 3' 6' 12'

1

RECEIVED

MAR 19 2009
 CITY OF SAUSALITO
 COMMUNITY DEVELOPMENT

482

PAGE # 40

JRA
 Jeffrey Ross & Associates, Inc.
 Arizona • California • Nevada
 ALBUQUERQUE (505) 244-5373
 CALIFORNIA (415) 749-3553
 NASHVILLE (615) 752-0025

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at&t
 APPLICANT
 1100 RIVINGTON DRIVE, SUITE 200
 PLAZA
 PHOENIX, ARIZONA 85016
 CITY OF SALISALITO
 101 2ND STREET
 SALISALITO, CALIFORNIA 91065

APPROVALS

DATE	DATE

PROJECT NAME
AT&T 2ND CARRIER MODS
 101 & RODEO
 PROJECT ADDRESS
 101 RODEO AVENUE
 SALISALITO, CALIFORNIA 91065


APR NUMBER
 04-11-001

ISSUE DATES
 10/15/08
 07/27/09
 02/16/09
 09/24/09

ISSUE DESCRIPTIONS (P1)
 100% 20% (P2)
 FIELD COMPARISON (P3)
 PLANNING COMMISSION (P4)

REVISION 4.2
 SHEET TITLE
NORTHEAST AND SOUTHWEST EXISTING ELEVATIONS

A-2.1

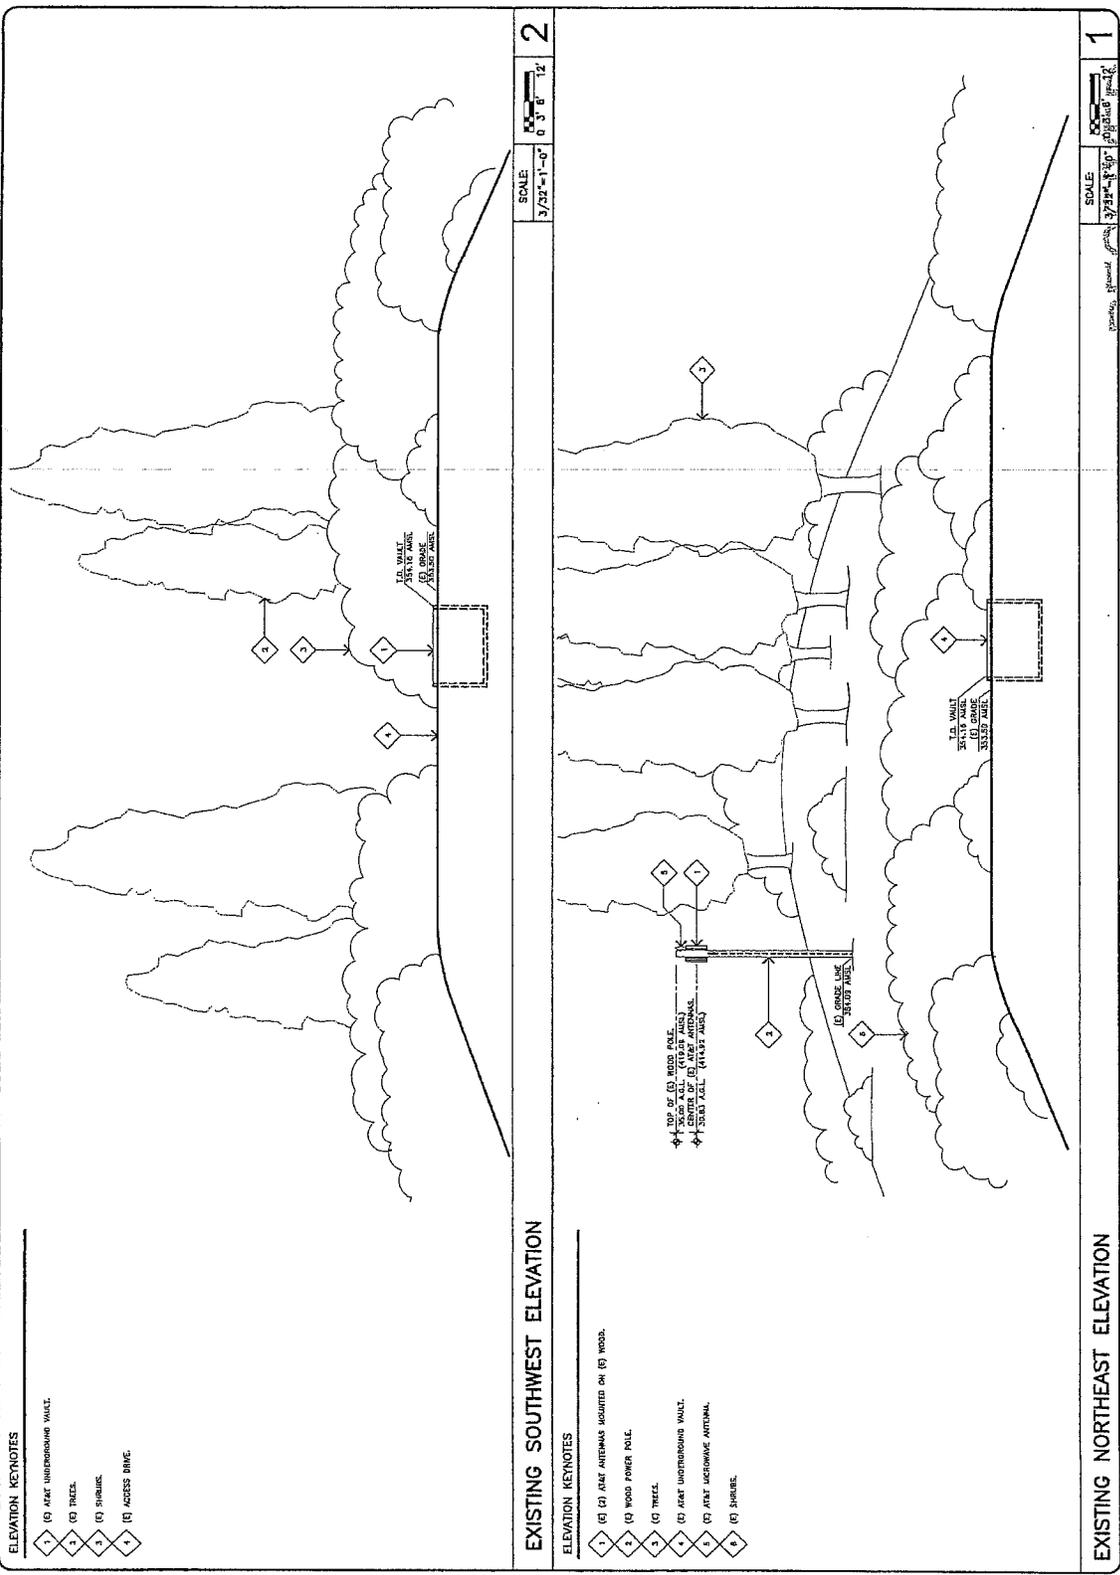

- ELEVATION KEYNOTES**
- 1 (E) A&T UNDERGROUND WALK.
 - 2 (E) TRUCE.
 - 3 (E) POWER.
 - 4 (E) ACCESS DRIVE.

EXISTING SOUTHWEST ELEVATION

- ELEVATION KEYNOTES**
- 1 (E) (E) A&T ANTENNAS MOUNTED ON (E) WOOD.
 - 2 (E) WOOD POWER POLE.
 - 3 (E) TRUCE.
 - 4 (E) A&T UNDERGROUND WALK.
 - 5 (E) A&T UNDERGROUND ANTENNA.
 - 6 (E) SHOWER.

EXISTING NORTHEAST ELEVATION

SCALE
 1/32" = 1'-0"

2

1

RECEIVED

MAR 19 2009

CITY OF SALISALITO
 COMMUNITY DEVELOPMENT

482
 PAPER 24

JRA
 Jeffrey Rame & Associates, Inc.
 Arizona • California • Nevada
 (482) 284-5379
 (482) 284-5378
 (702) 792-2020

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APPROVAL
 ENGINEER
 CITY OF SAUSALITO
 SAUSALITO, CALIFORNIA, 94965


DATE	

PROJECT NAME
 AT&T 2ND CARRIER MODS
SITE NAME
 101 E RODEO
CITY
 CHULA VISTA
PROJECT ADDRESS
 101 RODEO AVENUE
 SAUSALITO, CALIFORNIA 94965

ISSUANCE DATES
 12/15/08 (1)
 01/27/09 (1)
 02/16/09 (1)
 04/01/09 (1)
 04/01/09 (1)
 04/01/09 (1)
 04/01/09 (1)

REVISION 4.2
 SHEET TITLE
 NORTHWEST AND SOUTHEAST
 PROPOSED ELEVATIONS

A-3

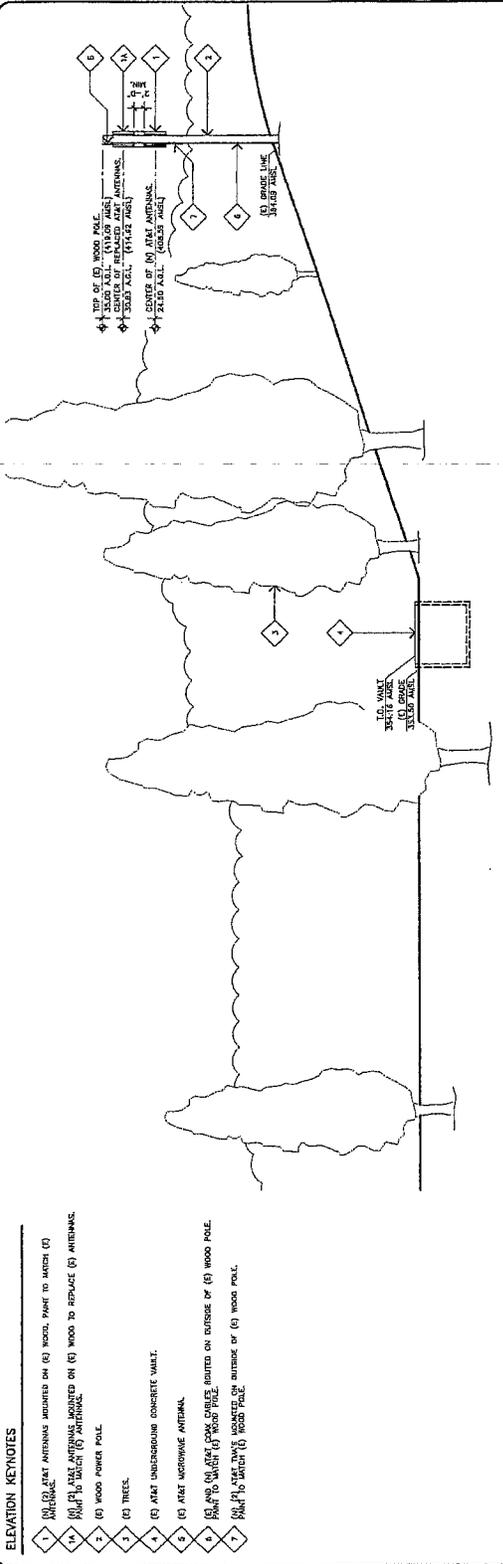


- ELEVATION KEYNOTES**
- 1 (1) AT&T ANTENNAS MOUNTED ON (E) WOOD POLE TO MATCH (1)
 - 2 (2) AT&T ANTENNAS MOUNTED ON (E) WOOD TO REPLACE (E) ANTENNAS. PAINT TO MATCH (E) WITHINNA.
 - 3 (3) WOOD POWER POLE.
 - 4 (4) TREES.
 - 5 (5) AT&T UNDERGROUND CONCRETE VAULT.
 - 6 (6) AT&T MICROWAVE ANTENNA.
 - 7 (7) (A) AND (B) AT&T COAX CABLES ROUTED ON OUTSIDE OF (E) WOOD POLE. PAINT TO MATCH (E) WOOD POLE.
 - 8 (8) (A) AND (B) AT&T COAX CABLES MOUNTED ON OUTSIDE OF (E) WOOD POLE. PAINT TO MATCH (E) WOOD POLE.

PROPOSED SOUTHEAST ELEVATION

SCALE 3/32"=1'-0"

2

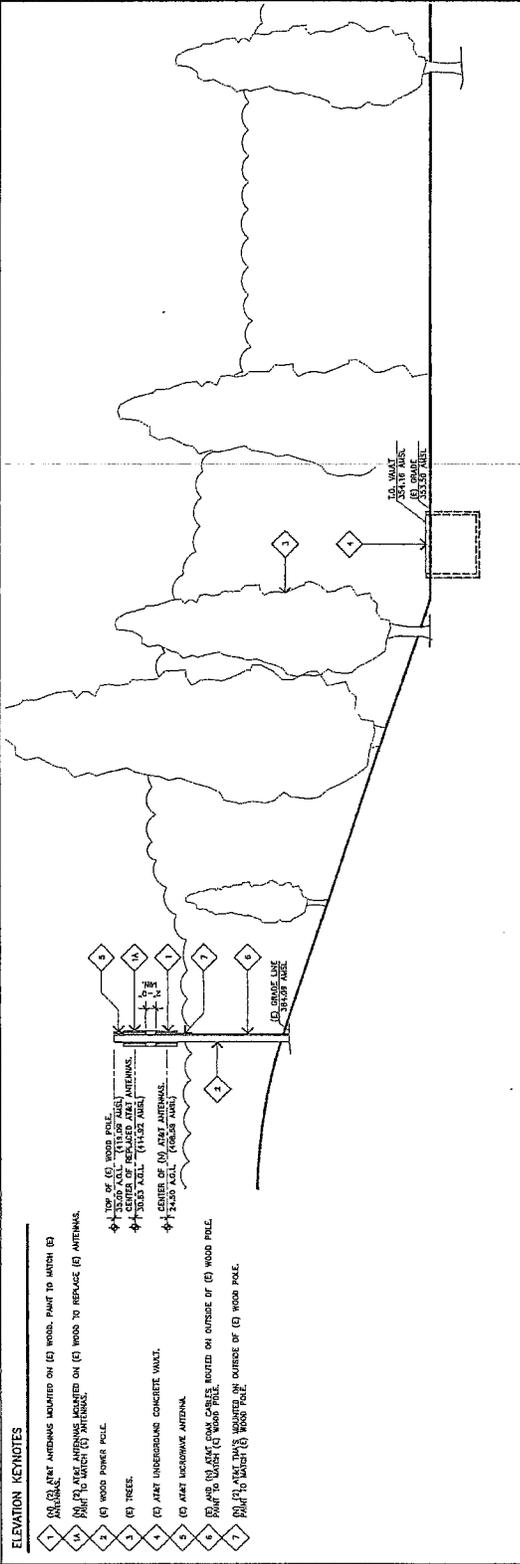

- ELEVATION KEYNOTES**
- 1 (1) AT&T ANTENNAS MOUNTED ON (E) WOOD POLE TO MATCH (E)
 - 2 (2) AT&T ANTENNAS MOUNTED ON (E) WOOD TO REPLACE (E) ANTENNAS. PAINT TO MATCH (E) WITHINNA.
 - 3 (3) WOOD POWER POLE.
 - 4 (4) TREES.
 - 5 (5) AT&T UNDERGROUND CONCRETE VAULT.
 - 6 (6) AT&T MICROWAVE ANTENNA.
 - 7 (7) (A) AND (B) AT&T COAX CABLES ROUTED ON OUTSIDE OF (E) WOOD POLE. PAINT TO MATCH (E) WOOD POLE.
 - 8 (8) (A) AND (B) AT&T COAX CABLES MOUNTED ON OUTSIDE OF (E) WOOD POLE. PAINT TO MATCH (E) WOOD POLE.

PROPOSED NORTHWEST ELEVATION

SCALE 3/32"=1'-0"

1

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CITY OF SAUSALITO
 COMMUNITY DEVELOPMENT

4B2

PROJ # 42

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 Jeffrey Lam & Associates, Inc.
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 Atlanta, Georgia 30309
 (404) 525-3333
 (415) 395-0089
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CLIENT
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 4430 ROSEWOOD DRIVE
 PLACENTIA, CALIFORNIA, 92666

OWNER
 AT&T
 3000 UNIVERSITY AVENUE
 SUITE 1000
 SAN JOSE, CALIFORNIA, 95128

APPROVALS

DATE	DATE

PROJECT NAME
 AT&T 2ND CARRIER MODS
 101 & RODEO

SITE NUMBER
 CHU4525

PROJECT ADDRESS
 101 & RODEO
 SAN JOSE, CALIFORNIA 95131

APR NUMBER
 81-81-840


DRAWING DATES
 12/15/08
 03/20/09
 03/23/09
 03/23/09
 03/23/09

REVISIONS

REVISION 4.2
SHEET TITLE

**NORTHEAST AND SOUTHWEST
 PROPOSED ELEVATIONS**

A-3.1

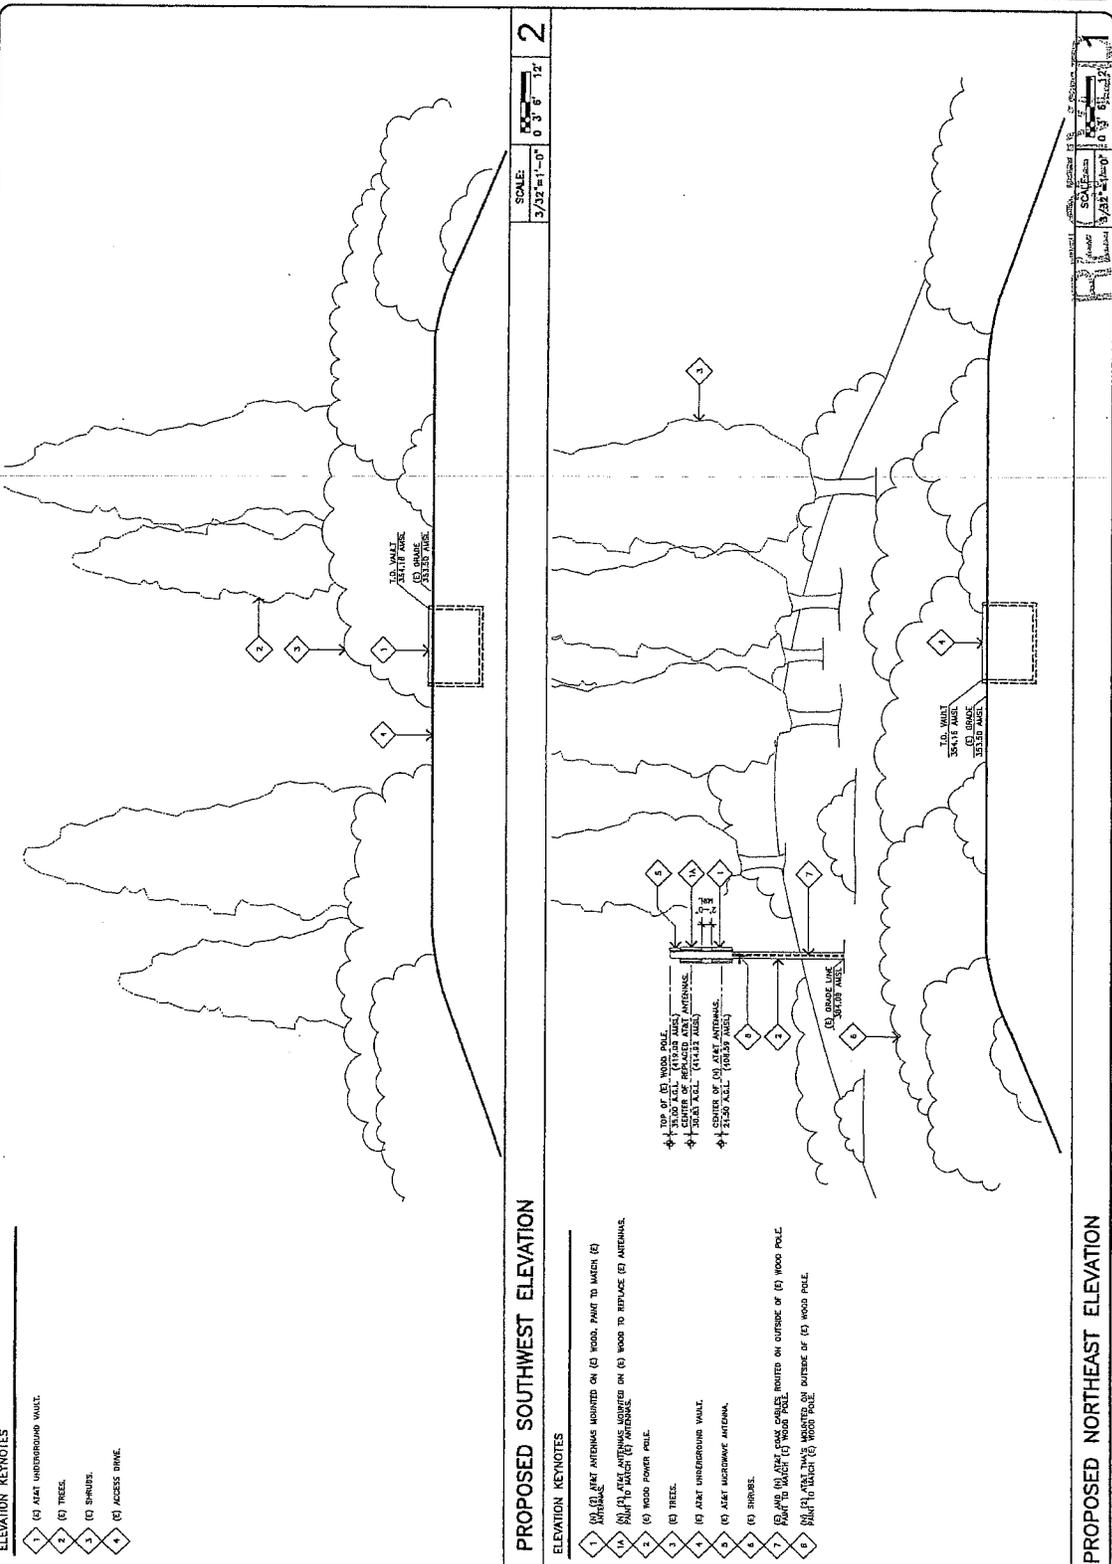

- ELEVATION KEYNOTES**
- 1 (E) AT&T UNDERGROUND WALK
 - 2 (E) TREES
 - 3 (E) SHORES
 - 4 (E) ACCESS DRIVE

- PROPOSED SOUTHWEST ELEVATION**
- ELEVATION KEYNOTES**
- 1 (E) AT&T ANTENNAS MOUNTED ON (E) WOOD POLE TO MATCH (E)
 - 2 (E) WOOD POLE TO MATCH (E) ANTENNAS
 - 3 (E) WOOD POWER POLE
 - 4 (E) TREES
 - 5 (E) AT&T UNDERGROUND WALK
 - 6 (E) AT&T MICROWAVE ANTENNA
 - 7 (E) SHORES
 - 8 (E) WOOD POLE TO MATCH (E) WOOD POLE
 - 9 (E) WOOD POLE TO MATCH (E) WOOD POLE

- PROPOSED NORTHEAST ELEVATION**

MAR 19 2009
 CITY OF SAUSALITO
 COMMUNITY DEVELOPMENT

4182
 PAGE 4/3

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at&t
 APPLICANT
 101 RODEO AVENUE
 SUITE 200
 SAN FRANCISCO, CALIFORNIA 94108

OWNER	DATE
CITY OF SAUSALITO	
APPROVALS	
DATE	

PROJECT NAME
 AT&T 2ND CARRIER MODS
 101 & RODEO
 SAN FRANCISCO, CALIFORNIA 94108

PROJECT ADDRESS
 101 RODEO AVENUE
 SAN FRANCISCO, CALIFORNIA 94108

ISSUING DATES
 12/15/06
 01/17/08
 02/10/08
 04/24/08



REVISIONS
 REVISION 4.2

SHEET TITLE
 SITE SECTION

A-4

SITE SECTION KEYNOTES

- 1 (A) AT&T ANTENNAS MOUNTED ON (E) WOOD POLE TO MATCH (E) ANTENNAS.
- 2 (A) AT&T ANTENNAS MOUNTED ON (E) WOOD TO REPLACE (E) ANTENNAS.
- 3 (E) WOOD POWER POLE.
- 4 (E) TREES.
- 5 (E) AT&T UNDERGROUND CONCRETE VAULT.
- 6 (E) AT&T UNDERGROUND ANTENNA.

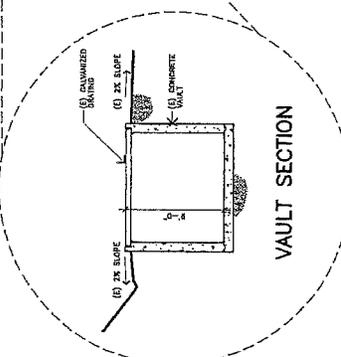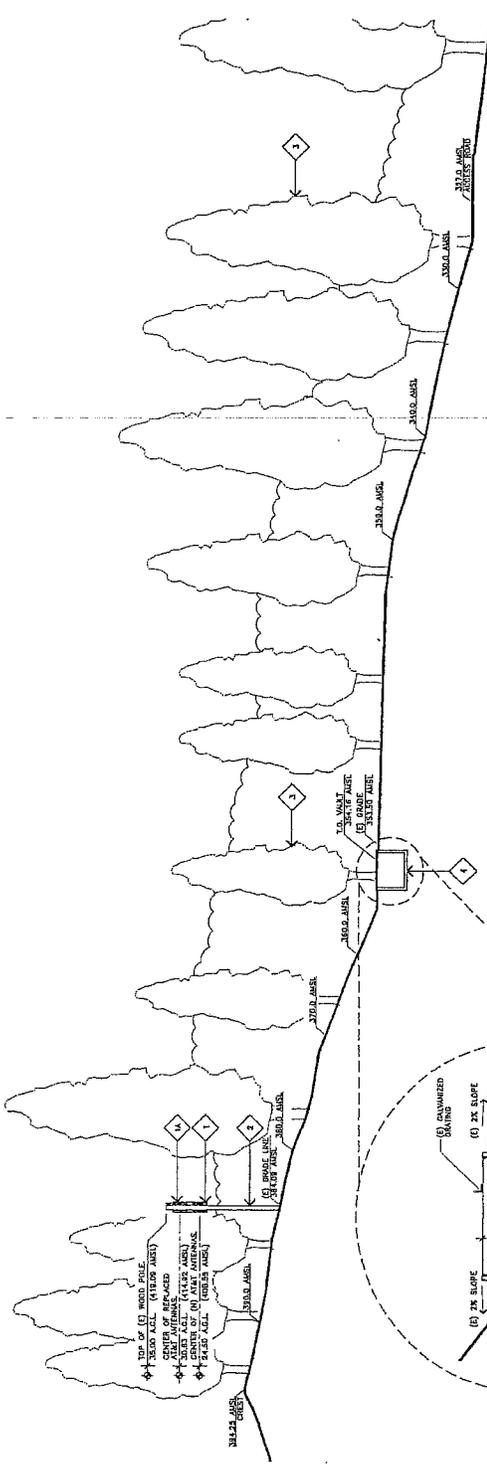

SITE SECTION

SCALE
 1" = 10'



MAR 19 2009

**CITY OF SAUSALITO
 COMMUNITY DEVELOPMENT**

482
PAGE #44

ENLARGED SITE PLAN KEYNOTES

- 1. (N) AT&T MICROCELL EQUIPMENT CABINET TO BE REMOVED.
- 2. (E) AT&T MICROCELL EQUIPMENT CABINET TO BE REMOVED.
- 3. (N) AT&T 1518 UNITS MICROCELL EQUIPMENT CABINET MOUNTED ON X (E) PPE MOUNT.
- 4. (N) AT&T 1518 UNITS MICROCELL EQUIPMENT CABINET MOUNTED ON X (E) PPE MOUNT.
- 5. (E) AT&T 1518 UNITS MICROCELL EQUIPMENT CABINET MOUNTED ON X (E) PPE MOUNT.
- 6. (E) AT&T 1518 UNITS MICROCELL EQUIPMENT CABINET MOUNTED ON X (E) PPE MOUNT.
- 7. (E) AT&T 1518 UNITS MICROCELL EQUIPMENT CABINET MOUNTED ON X (E) PPE MOUNT.
- 8. (E) AT&T 1518 UNITS MICROCELL EQUIPMENT CABINET MOUNTED ON X (E) PPE MOUNT.
- 9. (E) AT&T 1518 UNITS MICROCELL EQUIPMENT CABINET MOUNTED ON X (E) PPE MOUNT.
- 10. (E) AT&T 1518 UNITS MICROCELL EQUIPMENT CABINET MOUNTED ON X (E) PPE MOUNT.
- 11. (E) AT&T 1518 UNITS MICROCELL EQUIPMENT CABINET MOUNTED ON X (E) PPE MOUNT.
- 12. (E) AT&T 1518 UNITS MICROCELL EQUIPMENT CABINET MOUNTED ON X (E) PPE MOUNT.
- 13. (E) AT&T 1518 UNITS MICROCELL EQUIPMENT CABINET MOUNTED ON X (E) PPE MOUNT.
- 14. (E) AT&T 1518 UNITS MICROCELL EQUIPMENT CABINET MOUNTED ON X (E) PPE MOUNT.
- 15. (E) AT&T 1518 UNITS MICROCELL EQUIPMENT CABINET MOUNTED ON X (E) PPE MOUNT.
- 16. (E) AT&T 1518 UNITS MICROCELL EQUIPMENT CABINET MOUNTED ON X (E) PPE MOUNT.
- 17. (E) AT&T 1518 UNITS MICROCELL EQUIPMENT CABINET MOUNTED ON X (E) PPE MOUNT.
- 18. (E) AT&T 1518 UNITS MICROCELL EQUIPMENT CABINET MOUNTED ON X (E) PPE MOUNT.
- 19. (E) AT&T 1518 UNITS MICROCELL EQUIPMENT CABINET MOUNTED ON X (E) PPE MOUNT.
- 20. (E) AT&T 1518 UNITS MICROCELL EQUIPMENT CABINET MOUNTED ON X (E) PPE MOUNT.
- 21. (E) AT&T 1518 UNITS MICROCELL EQUIPMENT CABINET MOUNTED ON X (E) PPE MOUNT.
- 22. (E) AT&T 1518 UNITS MICROCELL EQUIPMENT CABINET MOUNTED ON X (E) PPE MOUNT.

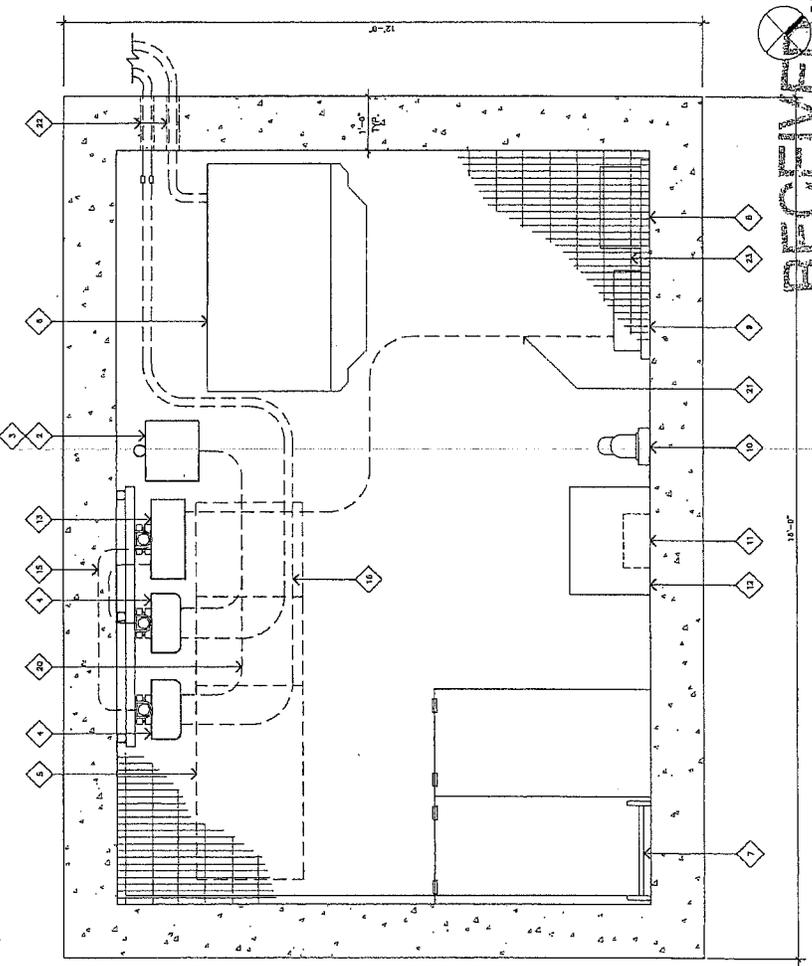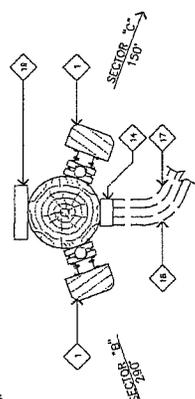

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 MAR 14 2008
 SCALE: 1/4" = 1'-0"
 SHEET NO. 1

EQUIPMENT FLOOR PLAN

CITY OF SAUSALITO
 COMMUNITY DEVELOPMENT

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at&t
 4430 ROSEWOOD DRIVE
 PHARMACIAN, CALIFORNIA, 94985

DATE	DATE	DATE	DATE	DATE
DATE	DATE	DATE	DATE	DATE
DATE	DATE	DATE	DATE	DATE
DATE	DATE	DATE	DATE	DATE
DATE	DATE	DATE	DATE	DATE

PROJECT NAME
AT&T 2ND CARRIER HOODS
 101 & RODEO
 SITE NUMBER
 CNU4525
 PROJECT ADDRESS
 SAUSALITO, CALIFORNIA 94965

APN NUMBER
 64-181-000
DRAWING DATES
 12/10/08
 01/20/09
 02/10/09
 03/05/09

REVISION A.2
 SHEET TITLE
EQUIPMENT FLOOR PLAN

A-1.1

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